

# CALIFORNIA HIGH-SPEED TRAIN

Project Environmental Impact Report/Environmental Impact Statement

FINAL

Merced to Fresno Section  
Project EIR/EIS

**Volume III:**

**Section F1 – Alignment Plans**

Hybrid Alternative with Ave 21 Wye

April 2012



**CALIFORNIA**  
High-Speed Rail Authority



**U.S. Department of Transportation**  
Federal Railroad Administration






SHT NO.	DWG NO.	DRAWING TITLE LINE 3	DRAWING TITLE LINE 4	DRAWING TITLE LINE 5	DRAWING TITLE LINE 6
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	T2086-A	HYBRID	AVENUE 24/SR152/AVENUE 21	TRACK PLAN AND PROFILE	STA 6152+00 TO STA 6208+00
	T2087-A	HYBRID	AVENUE 24/SR152/AVENUE 21	TRACK PLAN AND PROFILE	STA 6208+00 TO STA 6264+00
	T2088-A	HYBRID	AVENUE 24/SR152/AVENUE 21	TRACK PLAN AND PROFILE	STA 6264+00 TO STA 6320+00
	T2089-A	HYBRID	AVENUE 24/SR152/AVENUE 21	TRACK PLAN AND PROFILE	STA 6320+00 TO STA 6376+00
	T2090-A	HYBRID	AVENUE 24/SR152/AVENUE 21	TRACK PLAN AND PROFILE	STA 6376+00 TO STA 6432+00
	T2091-A	HYBRID	AVENUE 24/SR152/AVENUE 21	TRACK PLAN AND PROFILE	STA 6342+00 TO STA 6488+00
	T2092-A	HYBRID	AVENUE 24/SR152/AVENUE 21	TRACK PLAN AND PROFILE	STA 6488+00 TO STA 6542+00
	T2093-A	HYBRID	AVENUE 21	TRACK PLAN AND PROFILE	STA 6146+00 TO STA 6202+00
	T2094-A	HYBRID	AVENUE 21	TRACK PLAN AND PROFILE	STA 6202+00 TO STA 6258+00
	T2095-A	HYBRID	AVENUE 21	TRACK PLAN AND PROFILE	STA 6258+00 TO STA 6314+00
	T2096-A	HYBRID	AVENUE 21	TRACK PLAN AND PROFILE	STA 6314+00 TO STA 6370+00
	T2097-A	HYBRID	AVENUE 21	TRACK PLAN AND PROFILE	STA 6370+00 TO STA 6426+00
	T2098-A	HYBRID	AVENUE 21	TRACK PLAN AND PROFILE	STA 6426+00 TO STA 6482+00
	T2099-A	HYBRID	AVENUE 21	TRACK PLAN AND PROFILE	STA 6482+00 TO STA 6506+32
	T1100-A	HYBRID	AVENUE 21	PLAN AND PROFILE	STA 267+40.72 TO STA 320+00
	T1101-A	HYBRID	AVENUE 21	PLAN AND PROFILE	STA 320+00 TO STA 375+00
	T1102-A	HYBRID	AVENUE 21	PLAN AND PROFILE	STA 375+00 TO STA 430+00
	T1103-A	HYBRID	AVENUE 21	PLAN AND PROFILE	STA 430+00 TO STA 485+00
	T1104-A	HYBRID	AVENUE 21	PLAN AND PROFILE	STA 485+00 TO STA 540+00
	T1105-A	HYBRID	AVENUE 21	PLAN AND PROFILE	STA 540+00 TO STA 595+00
	T1106-A	HYBRID	AVENUE 21	PLAN AND PROFILE	STA 595+00 TO STA 650+00
	T1107-A	HYBRID	AVENUE 21	PLAN AND PROFILE	STA 650+00 TO STA 705+00
	T1108-A	HYBRID	AVENUE 21	PLAN AND PROFILE	STA 705+00 TO STA 760+00
	T1109-A	HYBRID	AVENUE 21	PLAN AND PROFILE	STA 760+00 TO STA 815+00
	T1110-A	HYBRID	AVENUE 21	PLAN AND PROFILE	STA 815+00 TO STA 868+86.88
	T1111-A	HYBRID		PLAN AND PROFILE	STA 1865+00 TO STA 1920+00
	T1112-A	HYBRID		PLAN AND PROFILE	STA 1920+00 TO STA 1975+00
	T1113-A	HYBRID		PLAN AND PROFILE	STA 1975+00 TO STA 2030+00

SHT NO.	DWG NO.	DRAWING TITLE LINE 3	DRAWING TITLE LINE 4	DRAWING TITLE LINE 5	DRAWING TITLE LINE 6
	T1114-A	HYBRID		PLAN AND PROFILE	STA 2030+00 TO STA 2085+00
	T1115-A	HYBRID		PLAN AND PROFILE	STA 2085+00 TO STA 2140+00
	T1116-A	HYBRID		PLAN AND PROFILE	STA 2140+00 TO STA 2195+00
	T1117-A	HYBRID		PLAN AND PROFILE	STA 2195+00 TO STA 2250+00
	T1118-A	HYBRID		PLAN AND PROFILE	STA 2250+00 TO STA 2305+00
	T1119-A	HYBRID		PLAN AND PROFILE	STA 2305+00 TO STA 2360+00
	T1120-A	HYBRID		PLAN AND PROFILE	STA 2360+00 TO STA 2415+00
	T1121-A	HYBRID		PLAN AND PROFILE	STA 2415+00 TO STA 2470+00
	T1122-A	HYBRID		PLAN AND PROFILE	STA 2470+00 TO STA 2525+00
	T1123-A	HYBRID		PLAN AND PROFILE	STA 2525+00 TO STA 2580+00
	T1124-A	HYBRID		PLAN AND PROFILE	STA 2580+00 TO STA 2635+00
	T1125-A	HYBRID		PLAN AND PROFILE	STA 2635+00 TO STA 2690+00
	T1126-A	HYBRID		PLAN AND PROFILE	STA 2690+00 TO STA 2740+55.79
	T1127-A	HYBRID		PLAN AND PROFILE	STA 1713+98 TO STA 1748+00
	T1128-A	HYBRID		PLAN AND PROFILE	STA 1748+00 TO STA 1801+61.51
	T2197-A	HYBRID - SB MERCED CONNECTION	AVENUE 21	PLAN AND PROFILE	STA 200+20 TO STA 250+00
	T2198-A	HYBRID - SB MERCED CONNECTION	AVENUE 21	PLAN AND PROFILE	STA 250+00 TO STA 305+00
	T2199-A	HYBRID - SB MERCED CONNECTION	AVENUE 21	PLAN AND PROFILE	STA 305+00 TO STA 360+00
	T2200-A	HYBRID - SB MERCED CONNECTION	AVENUE 21	PLAN AND PROFILE	STA 360+00 TO STA 377+99.09
	T2201-A	HYBRID - NB MERCED CONNECTION	AVENUE 21	PLAN AND PROFILE	STA 500+00 TO STA 550+00
	T2202-A	HYBRID - NB MERCED CONNECTION	AVENUE 21	PLAN AND PROFILE	STA 550+00 TO STA 605+00
	T2203-A	HYBRID - NB MERCED CONNECTION	AVENUE 21	PLAN AND PROFILE	STA 605+00 TO STA 660+00
	T2204-A	HYBRID - NB MERCED CONNECTION	AVENUE 21	PLAN AND PROFILE	STA 660+00 TO STA 677+39.72=
	T2205-A	UPRR/SR 99 MERCED CONNECTION	AVENUE 21	PLAN AND PROFILE	STA 4907+26.62 TO STA 4915+00
	T2206-A	UPRR/SR 99 MERCED CONNECTION	AVENUE 21	PLAN AND PROFILE	STA 4915+00 TO STA 4970+00
	T2207-A	UPRR/SR 99 MERCED CONNECTION		PLAN AND PROFILE	STA 4970+00 TO STA 5025+00
	T2208-A	UPRR/SR 99 MERCED CONNECTION		PLAN AND PROFILE	STA 5025+00 TO STA 5080+00
	T2209-A	UPRR/SR 99 MERCED CONNECTION		PLAN AND PROFILE	STA 5080+00 TO STA 5135+00
	T2210-A	UPRR/SR 99 MERCED CONNECTION		PLAN AND PROFILE	STA 5135+00 TO STA 5190+00
	T2211-A	UPRR/SR 99 MERCED CONNECTION		PLAN AND PROFILE	STA 5190+00 TO STA 5245+00
	T2212-A	UPRR/SR 99 MERCED CONNECTION		PLAN AND PROFILE	STA 5245+00 TO STA 5300+00
	T2213-A	UPRR/SR 99 MERCED CONNECTION		PLAN AND PROFILE	STA 5300+00 TO STA 5355+00
	T2214-A	UPRR/SR 99 MERCED CONNECTION		PLAN AND PROFILE	STA 5355+00 TO STA 5410+00
	T2215-A	UPRR/SR 99 MERCED CONNECTION		PLAN AND PROFILE	STA 5410+00 TO STA 5465+00
	T2216-A	UPRR/SR 99 MERCED CONNECTION		PLAN AND PROFILE	STA 5465+00 TO STA 5520+00
	T2217-A	UPRR/SR 99 MERCED CONNECTION		PLAN AND PROFILE	STA 5520+00 TO STA 5575+00
	T2218-A	UPRR/SR 99 MERCED CONNECTION		PLAN AND PROFILE	STA 5575+00 TO STA 5630+00
	T2219-A	UPRR/SR 99 MERCED CONNECTION		PLAN AND PROFILE	STA 5630+00 TO STA 5685+00
	T2220-A	UPRR/SR 99 MERCED CONNECTION		PLAN AND PROFILE	STA 5685+00 TO STA 5740+00
	T2221-A	UPRR/SR 99 MERCED CONNECTION		PLAN AND PROFILE	STA 5740+00 TO STA 5795+00
	T2222-A	UPRR/SR 99 MERCED CONNECTION		PLAN AND PROFILE	STA 5795+00 TO STA 5850+00
	T2223-A	UPRR/SR 99 MERCED CONNECTION		PLAN AND PROFILE	STA 5850+00 TO STA 5905+00
	T2224-A	UPRR/SR 99 MERCED CONNECTION		PLAN AND PROFILE	STA 5905+00 TO STA 5960+00
	T2225-A	UPRR/SR 99 MERCED CONNECTION		PLAN AND PROFILE	STA 5960+00 TO STA 6015+00
	T2226-A	UPRR/SR 99 MERCED CONNECTION		PLAN AND PROFILE	STA 6015+00 TO STA 6066+14.05
	T2250-A	UPRR/SR 99 WYE - NB CONNECTION	AVENUE 21	PLAN AND PROFILE	STA 505+00 TO STA 555+00
	T2251-A	UPRR/SR 99 WYE - NB CONNECTION	AVENUE 21	PLAN AND PROFILE	STA 555+00 TO STA 610+00
	T2252-A	UPRR/SR 99 WYE - NB CONNECTION	AVENUE 21	PLAN AND PROFILE	STA 610+00 TO STA 665+00
	T2253-A	UPRR/SR 99 WYE - NB CONNECTION	AVENUE 21	PLAN AND PROFILE	STA 665+00 TO STA 720+00
	T2254-A	UPRR/SR 99 WYE - NB CONNECTION	AVENUE 21	PLAN AND PROFILE	STA 720+00 TO STA 775+00
	T2255-A	UPRR/SR 99 WYE - NB CONNECTION	AVENUE 21	PLAN AND PROFILE	STA 775+00 TO STA 830+00
	T2256-A	UPRR/SR 99 WYE - NB CONNECTION	AVENUE 21	PLAN AND PROFILE	STA 830+00 TO STA 846+93.43
	T2260-A	UPRR/SR 99 WYE - SB CONNECTION	AVENUE 21	PLAN AND PROFILE	STA 105+00 TO STA 125+00
	T2261-A	UPRR/SR 99 WYE - SB CONNECTION	AVENUE 21	PLAN AND PROFILE	STA 125+00 TO STA 180+00
	T2262-A	UPRR/SR 99 WYE - SB CONNECTION	AVENUE 21	PLAN AND PROFILE	STA 180+00 TO STA 235+00
	T2263-A	UPRR/SR 99 WYE - SB CONNECTION	AVENUE 21	PLAN AND PROFILE	STA 235+00 TO STA 290+00
	T2264-A	UPRR/SR 99 WYE - SB CONNECTION	AVENUE 21	PLAN AND PROFILE	STA 290+00 TO STA 345+00
	T2265-A	UPRR/SR 99 WYE - SB CONNECTION	AVENUE 21	PLAN AND PROFILE	STA 345+00 TO STA 400+00
	T2266-A	UPRR/SR 99 WYE - SB CONNECTION	AVENUE 21	PLAN AND PROFILE	STA 400+00 TO STA 416+33.89

"SEE T3000-T3017 DRAWINGS FOR  
TYPICAL SECTION LIMITS AND DETAILS"

						DESIGNED BY A. SHIELDS	<b>RECORD SET 15% DESIGN SUBMITTAL</b>	<b>AECOM</b> Technical Services, Inc. 2020 L Street, Suite 300 Sacramento, CA 95811	 <b>CALIFORNIA</b> HIGH-SPEED RAIL AUTHORITY	<b>CALIFORNIA HIGH-SPEED TRAIN PROJECT MERCED TO FRESNO</b>  HYBRID ALIGNMENT AVENUE 21 INDEX OF DRAWINGS SHEET 1 OF 1	CONTRACT NO. HSR06-007
					DRAWN BY A. SHIELDS	DRAWING NO. T0010-A					
					CHECKED BY A. BOONE	SCALE NONE					
					IN CHARGE A. BOONE	SHEET NO. OF ###					
					DATE 07/27/2011						
REV	DATE	BY	CHK	APP	DESCRIPTION						



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ABBREVIATIONS

ALIGNMENT

HORIZONTAL	
BC	BEGINNING OF CURVE
CS	CURVE TO SPIRAL
EC	END OF CURVE
PC	POINT OF CURVE
PCC	POINT OF COMPOUND CIRCULAR CURVES
PCS	POINT OF CURVE TO SPIRAL
PF	POINT OF FROG
PI	POINT OF INTERSECTION OF TWO TANGENTS
PITO	POINT OF INTERSECTION OF TURNOUT
POC	POINT ON CURVE
POS	POINT ON SPIRAL
POT	POINT ON TANGENT
PRC	POINT OF REVERSE CURVES
PS	POINT OF SWITCH
PSC	POINT OF SPIRAL TO CURVE
PT	POINT OF TANGENCY
R	RADIUS OF CURVATURE IN FEET
SC	SPIRAL TO CURVE
SPO	POINT OF ORIGIN OF COMPOUND SPIRAL
SS	POINT OF SPIRAL TO SPIRAL
ST	SPIRAL TO TANGENT
TS	TANGENT TO SPIRAL
V	DESIGN VELOCITY IN MILES PER HOUR
VERTICAL	
PVC	POINT OF VERTICAL CURVE (BEGINNING OF CURVE)
PVI	POINT OF VERTICAL INTERSECTION (OF TANGENTS)
PVT	POINT OF VERTICAL TANGENCY (ENDING OF CURVE)
VC	VERTICAL CURVE

MISCELLANEOUS

BEG	BEGIN
BLVD	BOULEVARD
CL	CENTER LINE
CLR	CENTERLINE, CLASS
CLR	CLEAR
COL	COLUMN
DWG	DRAWING
EQ	EQUATION
EXIST(E)	EXISTING
IN	INCH
LT	LEFT
MAX	MAXIMUM
MIN	MINIMUM
N	NORTH
NB	NORTH BOUND
NTS	NOT TO SCALE
OG	ORIGINAL GROUND
O/H OH	OVER HEAD
PG&E	PACIFIC GAS & ELECTRIC
PGL	PROFILE GRADE LINE
RR	RAILROAD
RD	ROAD
R/W ROW	RIGHT OF WAY
RT	RIGHT
SS	SANITARY SEWER
SHT	SHEET
ST	STREET
STD	STANDARD
SD	STORM DRAIN
STRUCT	STRUCTURE
T	TELEPHONE
	(OH) OVERHEAD LINE
	(UG) UNDERGROUND LINE
TOR	TOP OF RAIL
TK	TRACK
TO	TURNOUT
TYP	TYPICAL
TBD	TO BE DETERMINED
TF	TELECOMMUNICATIONS FIBER
	OPTIC
V VERT	VERTICAL
W	WATER, WEST

SYMBOLS

	MATCH LINE
	HST TRACK
	PROPOSED HST RIGHT-OF-WAY
	FREIGHT/PASSENGER TRACK - EXISTING
	EXISTING RIGHT-OF-WAY
	EXISTING BRIDGE FEATURES
	RETAINING WALLS
	ORIGINAL GROUND
	GAS LINE (16")
	COMMUNICATION LINE
	WATER LINE
	FIBER OPTIC LINE
	ELECTRICAL LINE
	ELECTRICAL TOWER
	SEWER LINE
	STORM DRAIN LINE
	FUEL LINE
	TELEPHONE LINE
	PETROLEUM LINE (12")
	OVERHEAD
	NORTH ARRROW
	PVI
	POTENTIAL SOUND BARRIER

NOTES:

- EXISTING ROADS TO BE GRADE SEPARATED OVER THE HIGH SPEED TRAIN (HST) RIGHT OF WAY ARE INDICATED IN THE ALIGNMENT PROFILE. ALL OTHER ROADS CROSSING THE PROPOSED HST TRACKS WILL BE CLOSED OR RELOCATED. SEE ROADWAY PLANS FOR ADDITIONAL INFORMATION.
- SEE STRUCTURE PLANS FOR LIMITS AND DETAILS OF VIADUCTS, STREAM CROSSINGS, RETAINING WALLS AND OTHER HST STRUCTURES.
- SEE ROADWAY PLANS FOR ROADWAY RELOCATIONS, GRADE SEPARATIONS, AND MODIFICATIONS TO STATE HIGHWAY FACILITIES.
- UTILITIES INDICATED ON THE PLANS ARE FOR REFERENCE ONLY. SEE "UTILITIES CONFLICT MEMO" FOR ADDITIONAL INFORMATION AND PROPOSED RELOCATION CONCEPTS.
- ROAD/LOCAL ACCESS DELINEATED FOR FURTHER EVALUATION. ADDITIONAL STUDIES WILL BE CONDUCTED DURING PRELIMINARY ENGINEERING PHASE (30% DESIGN) TO SUBSTANTIATE ITS INCLUSION OR EXCLUSION FROM THE PROPOSED IMPORVEMENTS.
- STANDALONE RADIO SITES WILL BE PROVIDED IN BETWEEN TRACTION POWER FACILITIES (SUBSTATIONS, SWITCHING STATIONS, AND PARALLELING STATIONS). SPACING OF THESE SITES WILL VARY BETWEEN 1-1/2 AND 3 MILES. ACCESS TO THESE SITES WILL BE PROVIDED AT THE NEAREST PUBLIC ROAD THAT CROSSES THE HIGH SPEED TRAIN ALIGNMENT.

"SEE T3000-T3017 DRAWINGS FOR  
TYPICAL SECTION LIMITS AND DETAILS"

REV	DATE	BY	CHK	APP	DESCRIPTION

DESIGNED BY B. CHAN
DRAWN BY S. LEONG
CHECKED BY A. BOWE
IN CHARGE J. VALSECCHI
DATE 07/27/2011

RECORD SET  
15% DESIGN  
SUBMITTAL

NOT FOR  
CONSTRUCTION



CALIFORNIA  
HIGH-SPEED RAIL AUTHORITY

CALIFORNIA HIGH-SPEED TRAIN PROJECT  
MERCED TO FRESNO  
GENERAL

ABBREVIATIONS, SYMBOLS AND NOTES

CONTRACT NO. HSR06-007
DRAWING NO. T0100-A
SCALE NO SCALE
SHEET NO. ### OF ###



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"SEE T3000-T3017 DRAWINGS FOR  
TYPICAL SECTION LIMITS AND DETAILS"

REV	DATE	BY	CHK	APP	DESCRIPTION
1	12/12/2011	AS			TRACK REALIGNMENT

DESIGNED BY A. SHIELDS
DRAWN BY H. SULLIVAN
CHECKED BY A. BOONE
IN CHARGE A. BOONE
DATE 07/27/2011

**RECORD SET**  
**15% DESIGN**  
**SUBMITTAL**

**NOT FOR**  
**CONSTRUCTION**

**AECOM**  
Technical Services, Inc.  
2020 L Street, Suite 300  
Sacramento, CA 95811

**CH2MHILL**

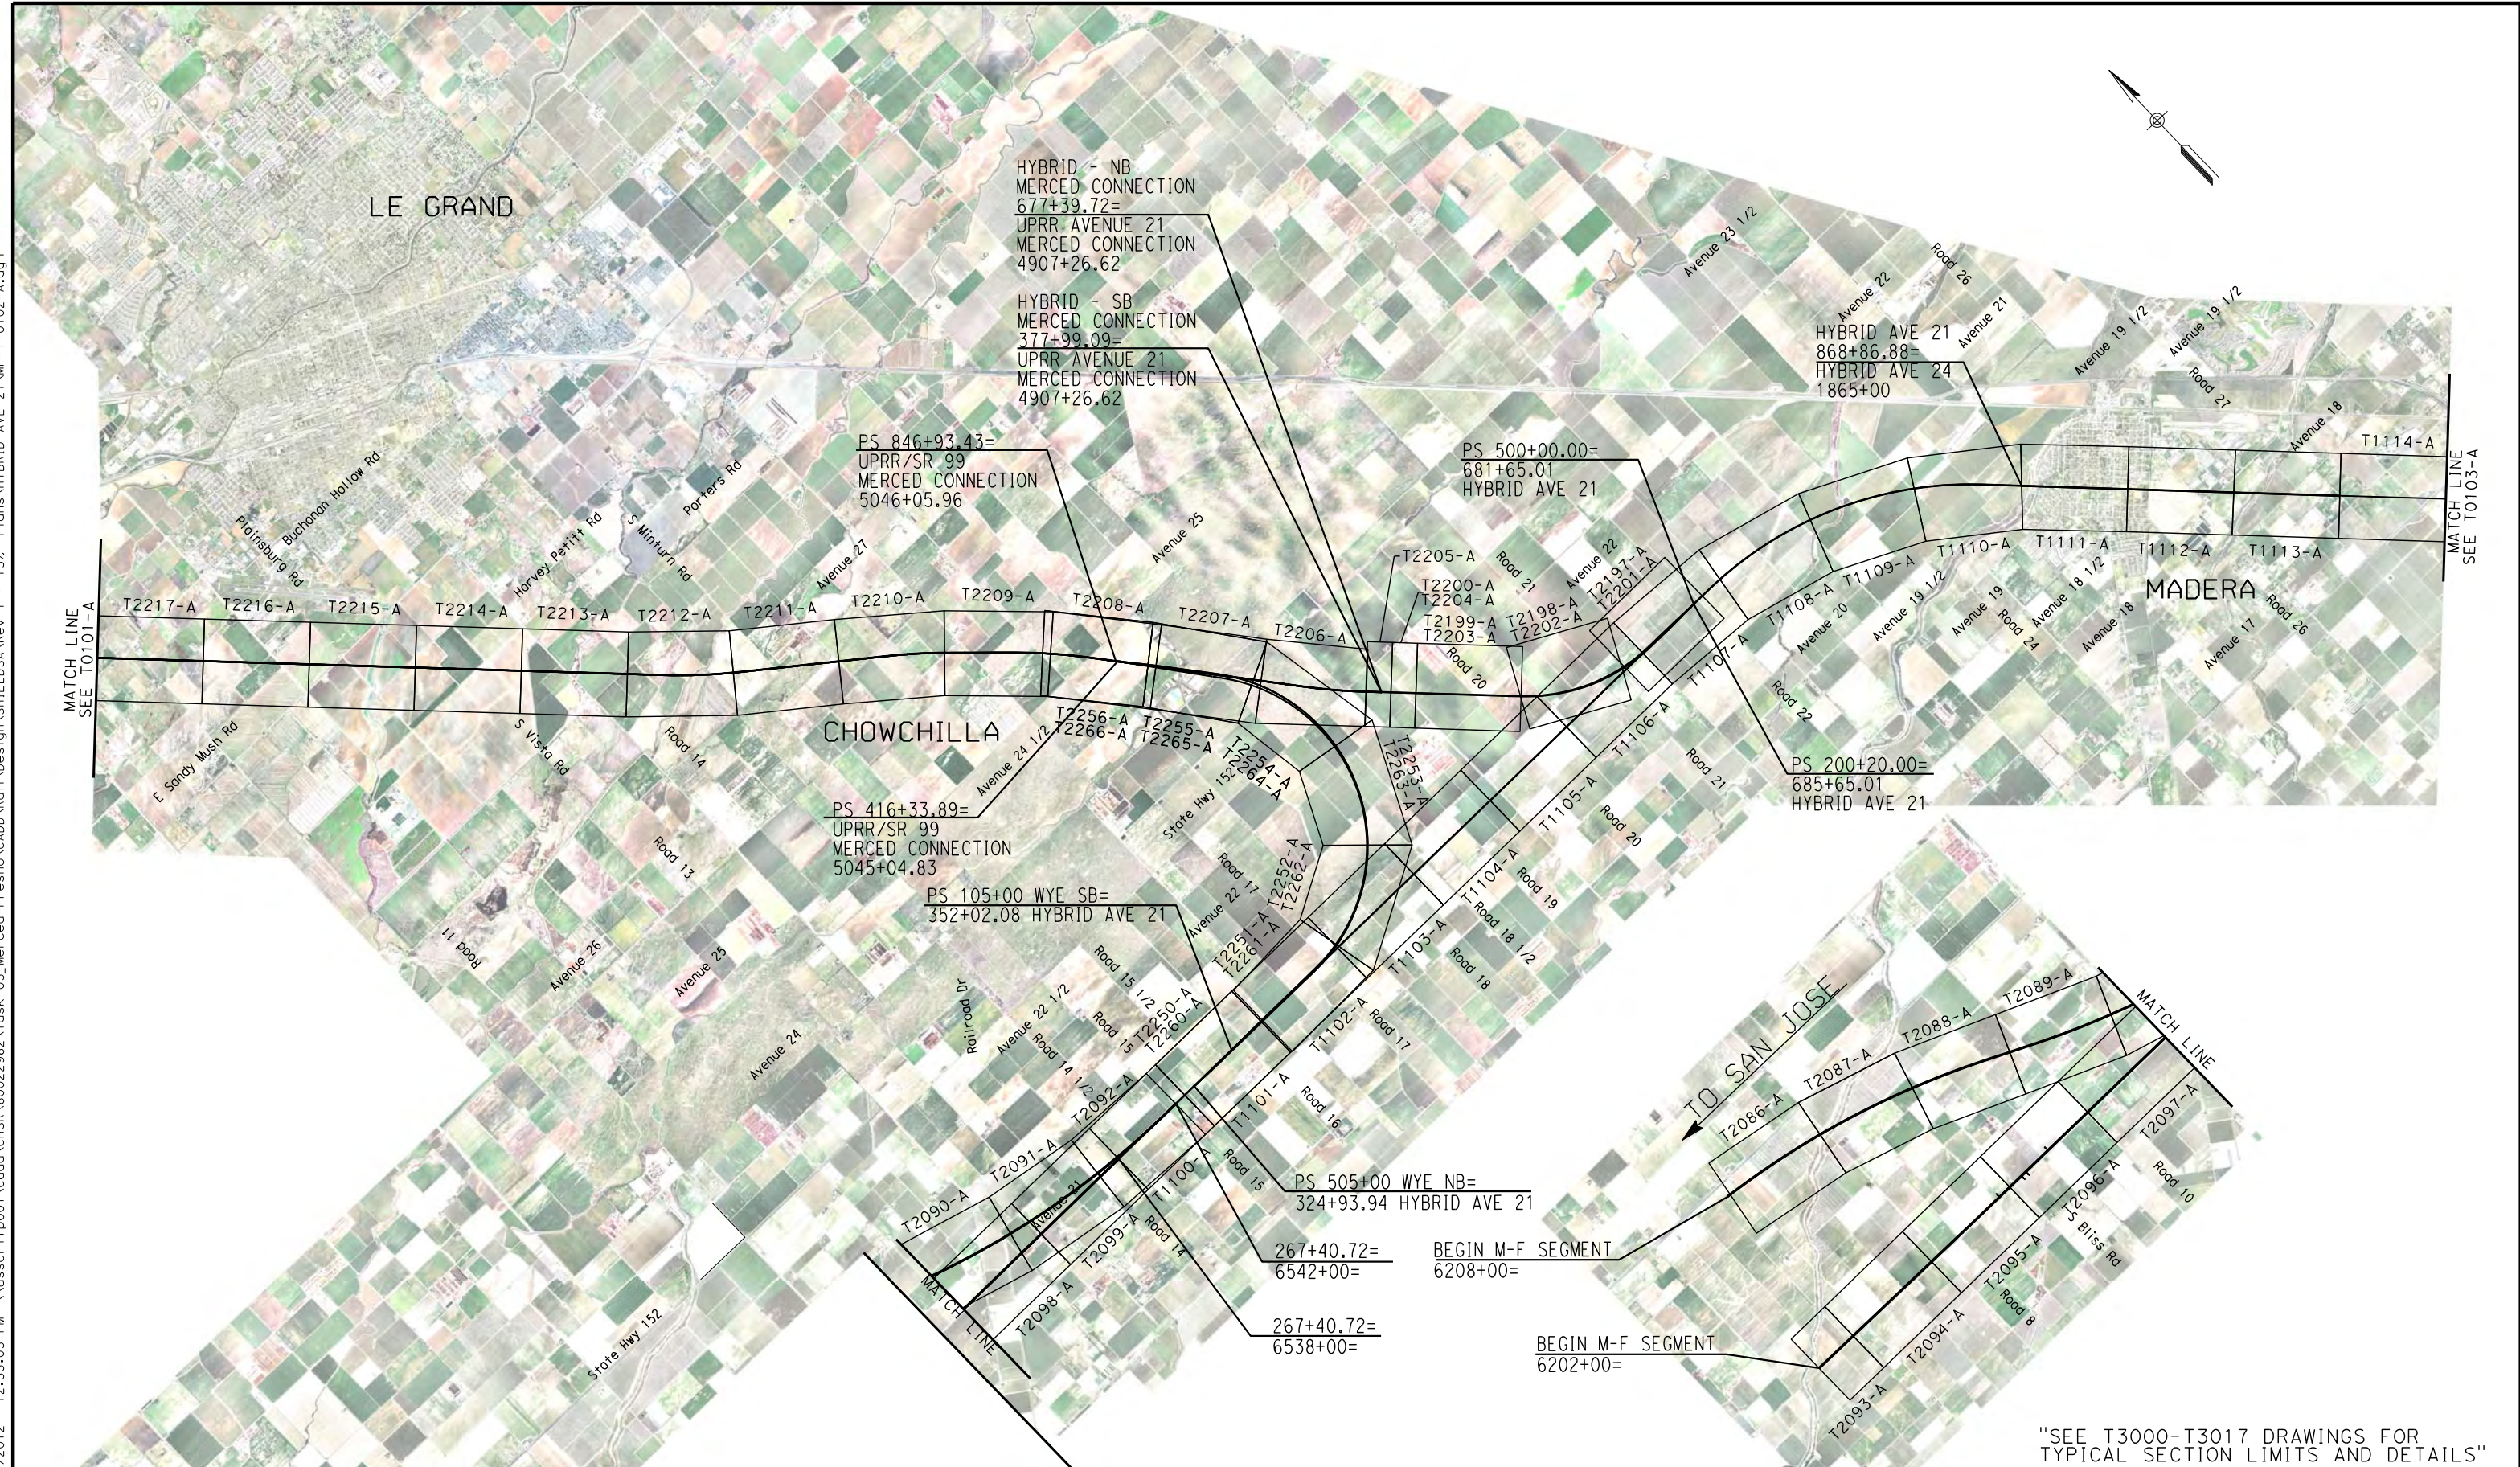



**CALIFORNIA**  
HIGH-SPEED RAIL AUTHORITY

**CALIFORNIA HIGH-SPEED TRAIN PROJECT**  
**MERCED TO FRESNO**  
HYBRID ALIGNMENT  
AVENUE 21  
KEY MAP  
SHEET 1 OF 3

CONTRACT NO. HSR06-007
DRAWING NO. T0101-A
SCALE NO SCALE
SHEET NO. ### OF ###





						DESIGNED BY A. SHIELDS	<b>RECORD SET</b> <b>15% DESIGN</b> <b>SUBMITTAL</b>  <b>NOT FOR</b> <b>CONSTRUCTION</b>	 Technical Services, Inc. 2020 L Street, Suite 300 Sacramento, CA 95811	 <b>CALIFORNIA</b> HIGH-SPEED RAIL AUTHORITY	<b>CALIFORNIA HIGH-SPEED TRAIN PROJECT</b> <b>MERCED TO FRESNO</b> HYBRID ALIGNMENT AVENUE 21 KEY MAP SHEET 2 OF 3	CONTRACT NO. HSR06-007
					DRAWN BY H. SULLIVAN	DRAWING NO. T0102-A					
					CHECKED BY A. BOONE	SCALE NO SCALE					
					IN CHARGE A. BOONE	SHEET NO. ### OF ###					
1	12/12/2011	AS			TRACK REALIGNMENT	DATE 07/27/2011					
REV	DATE	BY	CHK	APP	DESCRIPTION						



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"SEE T3000-T3017 DRAWINGS FOR  
TYPICAL SECTION LIMITS AND DETAILS"

REV	DATE	BY	CHK	APP	DESCRIPTION
1	12/12/2011	AS			TRACK REALIGNMENT

DESIGNED BY  
A. SHIELDS  
DRAWN BY  
H. SULLIVAN  
CHECKED BY  
A. BOONE  
IN CHARGE  
A. BOONE  
DATE  
07/27/2011

RECORD SET  
15% DESIGN  
SUBMITTAL

NOT FOR  
CONSTRUCTION

**AECOM**  
Technical Services, Inc.  
2020 L Street, Suite 300  
Sacramento, CA 95811  
**CH2MHILL**



**CALIFORNIA**  
HIGH-SPEED RAIL AUTHORITY

**CALIFORNIA HIGH-SPEED TRAIN PROJECT**  
**MERCED TO FRESNO**  
HYBRID ALIGNMENT  
AVENUE 21  
KEY MAP  
SHEET 3 OF 3

CONTRACT NO.  
HSR06-007  
DRAWING NO.  
T0103-A  
SCALE  
NO SCALE  
SHEET NO.  
### OF ###



### TRACK ALIGNMENT DATA SUMMARY TABLE - SOUTHBOUND TRACK

CURVE	ELEMENT	POINT TYPE	STATION	COORDINATES		RADIUS (FT)	LENGTH (FT)	DELTA, Δ	K	P	DESIGN SPEED (MPH)	ACTUAL SUPERELEVATION (EA)(IN)	UNBALANCED SUPERELEVATION (EA)(IN)	WCB (0°00'00") (TANGENT)	WCB (0°00'00")		
				NORTHING	EASTING										START ANGLE	END ANGLE	
	TANGENT	POB	5367+74.09	1858039.02	6512080.45		10097.07							S 89°46'01" E			
	TANGENT	TS	5468+71.16	1857997.95	6522177.45												
SR-1-SB	CLOTHOID	TS	5468+71.16	1857997.95	6522177.45												
	CLOTHOID	SPI	5479+71.18	1857993.48	6523277.46		1650.00	1°03'02"	824.99	2.52				S 89°46'01" E	S 88°43'00" E		
	CLOTHOID	SC	5485+21.16	1857981.16	6523827.34												
	ARC	SC	5485+21.16	1857981.16	6523827.34												
	ARC	PI	5543+57.72	1857850.43	6529662.42	45000.00	11608.30	14°46'49"			250	4.00	1.56	S 88°43'00" E	S 73°56'11" E		
	ARC	CC		1812992.45	6522819.41												
	ARC	CS	5601+29.47	1856235.43	6535271.09												
	CLOTHOID	CS	5601+29.47	1856235.43	6535271.09												
	CLOTHOID	SPI	5606+79.48	1856083.24	6535799.63		1650.00	1°03'02"	824.99	2.52				S 73°56'11" E	S 72°53'10" E		
	CLOTHOID	ST	5617+79.47	1855759.53	6536850.94												
	TANGENT	ST	5617+79.47	1855759.53	6536850.94		3900.12							S 72°53'10" E			
	TANGENT	TS	5656+79.58	1854611.83	6540578.37												
SR-2-SB	CLOTHOID	TS	5656+79.58	1854611.83	6540578.37												
	CLOTHOID	SPI	5667+79.60	1854288.12	6541629.68		1650.00	1°03'00"	824.99	2.52				S 72°53'10" E	S 73°56'10" E		
	CLOTHOID	SC	5673+29.58	1854135.93	6542158.22												
	ARC	SC	5673+29.58	1854135.93	6542158.22												
	ARC	PI	5732+61.69	1852494.45	6547858.7	45016.50	11796.24	15°00'50"			250	4.00	1.55	S 73°56'10" E	S 88°57'00" E		
	ARC	CC		1897394.68	6554614.76												
	ARC	CS	5791+25.83	1852385.74	6553789.81												
	CLOTHOID	CS	5791+25.83	1852385.74	6553789.81												
	CLOTHOID	SPI	5796+75.84	1852375.66	6554339.73		1650.00	1°03'00"	824.99	2.52				S 88°57'00" E	S 90°00'00" E		
	CLOTHOID	ST	5807+75.83	1852375.66	6555439.75												
	TANGENT	ST	5807+75.83	1852375.66	6555439.75		28794.12							S 90°00'00" E			
	TANGENT	TS	6095+69.95	1852375.66	6584233.87												
SR-3-SB	CLOTHOID	TS	6095+69.95	1852375.66	6584233.87												
	CLOTHOID	SPI	6106+69.97	1852375.66	6585333.89		1650.00	1°03'02"	824.99	2.52				S 90°00'00" E	S 88°56'58" E		
	CLOTHOID	SC	6112+19.95	1852365.58	6585883.81												
	ARC	SC	6112+19.95	1852365.58	6585883.81												
	ARC	PI	6204+28.65	1852196.76	6595090.97	45000.00	18166.59	23°07'50"			250	4.00	1.56	S 88°56'58" E	S 65°49'09" E		
	ARC	CC		1807373.14	6585058.86												
	ARC	CS	6293+86.54	1848424.71	6603491.68												
	CLOTHOID	CS	6293+86.54	1848424.71	6603491.68												
	CLOTHOID	SPI	6299+36.56	1848199.41	6603993.44		1650.00	1°03'02"	824.99	2.52				S 65°49'09" E	S 64°46'07" E		
	CLOTHOID	ST	6310+36.54	1847730.5	6604988.51												
	TANGENT	ST	6310+36.54	1847730.5	6604988.51		1353.50							S 64°46'07" E			
	TANGENT	TS	6323+90.04	1847153.54	6606212.88												

REV	DATE	BY	CHK	APP	DESCRIPTION

DESIGNED BY	P. JACOBY
DRAWN BY	ALBERT S.
CHECKED BY	RESHMA C.
IN CHARGE	D. WEMMER
DATE	4/15/2011

**15% DRAFT  
SUBMITTAL  
FOR INTERNAL  
USE ONLY**

**NOT FOR  
CONSTRUCTION**



# CALIFORNIA HIGH-SPEED TRAIN PROJECT

## MERCED TO FRESNO

HYBRID  
AVENUE 24/SR152/AVENUE 2  
TRACK GEOMETRY DATA

CONTRACT NO. HSR08-05
DRAWING NO. TJ7401A
SCALE NO SCALE
SHEET NO.



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P0037225

TRACK ALIGNMENT DATA SUMMARY TABLE - SOUTHBOUND TRACK

CURVE	ELEMENT	POINT TYPE	STATION	COORDINATES		RADIUS (FT)	LENGTH (FT)	DELTA, Δ	K	P	DESIGN SPEED (MPH)	ACTUAL SUPERELEVATION (EA)(IN)	UNBALANCED SUPERELEVATION (EA)(IN)	WCB (0°00'00") (TANGENT)	WCB (0°00'00")	
				NORTHING	EASTING										START ANGLE	END ANGLE
SR-4-SB	CLOTHOID	TS	6323+90.04	1847153.54	6606212.88											
	CLOTHOID	SPI	6334+90.06	1846684.64	6607207.95		1650.00	1°03'00"	824.99	2.52					S 64°46'07" E	S 65°49'08" E
	CLOTHOID	SC	6340+40.04	1846459.33	6607709.7											
	ARC	SC	6340+40.04	1846459.33	6607709.7											
	ARC	PI	6434+27.70	1842613.92	6616273.64	45016.50	18510.04	23°33'33"			250	4.00	1.55		S 65°49'08" E	S 89°22'40" E
	ARC	CC		1887525.83	6626149.55											
	ARC	CS	6525+50.08	1842511.99	6625660.74											
	CLOTHOID	CS	6525+50.08	1842511.99	6625660.74											
	CLOTHOID	SPI	6531+00.10	1842506.01	6626210.73		1650.00	1°03'00"	824.99	2.52					S 89°22'40" E	N 89°34'20" E
	CLOTHOID	ST	6542+00.08	1842514.23	6627310.72											

REV	DATE	BY	CHK	APP	DESCRIPTION	

DESIGNED BY P. JACOBY
DRAWN BY ALBERT S.
CHECKED BY RESHMA C.
IN CHARGE D. WEMMER
DATE 4/15/2011

15% DRAFT  
SUBMITTAL  
FOR INTERNAL  
USE ONLY

NOT FOR  
CONSTRUCTION



CALIFORNIA  
HIGH-SPEED RAIL AUTHORITY

CALIFORNIA HIGH-SPEED TRAIN PROJECT  
MERCED TO FRESNO


HYBRID  
AVENUE 24/SR152/AVENUE 21  
TRACK GEOMETRY DATA

CONTRACT NO. HSR08-05
DRAWING NO. TJ7402A
SCALE NO SCALE
SHEET NO.



### TRACK ALIGNMENT DATA SUMMARY TABLE - NORTHBOUND TRACK

CURVE	ELEMENT	POINT TYPE	STATION	COORDINATES		RADIUS (FT)	LENGTH (FT)	DELTA, Δ	K	P	DESIGN SPEED (MPH)	ACTUAL SUPERELEVATION (EA)(IN)	UNBALANCED SUPERELEVATION (EA)(IN)	WCB (0°00'00'') (TANGENT)	WCB (0°00'00'')	
				NORTHING	EASTING										START ANGLE	END ANGLE
	TANGENT	POB	5367+74.09	1858055.52	6512080.52		10096.92							S 89°46'01" E		
	TANGENT	TS	5468+71.01	1858014.45	6522177.36											
SR-1-NB	CLOTHOID	TS	5468+71.01	1858014.45	6522177.36											
	CLOTHOID	SPI	5479+71.23	1858009.98	6523277.57		1650.30	1°03'01"	825.14	2.52					S 89°46'01" E	S 88°43'00" E
	CLOTHOID	SC	5485+21.31	1857997.66	6523827.55											
	ARC	SC	5485+21.31	1857997.66	6523827.55											
	ARC	PI	5543+60.16	1857866.9	6529664.94	45016.50	11612.86	14°46'50"			250	4.00	1.55		S 88°43'00" E	S 73°56'10" E
	ARC	CC		1812992.45	6522819.41											
	ARC	CS	5601+34.18	1856251.25	6535275.8											
	CLOTHOID	CS	5601+34.18	1856251.25	6535275.8											
	CLOTHOID	SPI	5606+84.30	1856099.02	6535804.44		1650.30	1°03'01"	825.14	2.52					S 73°56'10" E	S 72°53'10" E
	CLOTHOID	ST	5617+84.48	1855775.26	6536855.94											
	TANGENT	ST	5617+84.48	1855775.26	6536855.94		3900.12							S 72°53'10" E		
	TANGENT	TS	5656+84.59	1854627.56	6540583.37											
SR-2-NB	CLOTHOID	TS	5656+84.59	1854627.56	6540583.37											
	CLOTHOID	SPI	5667+84.41	1854303.91	6541634.49		1649.70	1°03'01"	824.84	2.52					S 72°53'10" E	S 73°56'10" E
	CLOTHOID	SC	5673+34.29	1854151.74	6542162.93											
	ARC	SC	5673+34.29	1854151.74	6542162.93											
	ARC	PI	5732+64.07	1852510.93	6547861.18	45000.00	11791.62	15°00'49"			250	4.00	1.56		S 73°56'10" E	S 88°56'59" E
	ARC	CC		1897394.68	6554614.76											
	ARC	CS	5791+25.91	1852402.24	6553789.96											
	CLOTHOID	CS	5791+25.91	1852402.24	6553789.96											
	CLOTHOID	SPI	5796+75.83	1852392.16	6554339.78		1649.70	1°03'01"	824.84	2.52					S 88°56'59" E	S 90°00'00" E
	CLOTHOID	ST	5807+75.61	1852392.16	6555439.6											
	TANGENT	ST	5807+75.61	1852392.16	6555439.6		28794.12							S 90°00'00" E		
	TANGENT	TS	6095+69.73	1852392.16	6584233.72											
SR-3-NB	CLOTHOID	TS	6095+69.73	1852392.16	6584233.72											
	CLOTHOID	SPI	6106+69.95	1852392.16	6585333.94		1650.30	1°03'01"	825.14	2.52					S 90°00'00" E	S 88°56'59" E
	CLOTHOID	SC	6112+20.03	1852382.08	6585883.96											
	ARC	SC	6112+20.03	1852382.08	6585883.96											
	ARC	PI	6204+32.27	1852213.23	6595094.66	45016.50	18173.56	23°07'51"			250	4.00	1.55		S 88°56'59" E	S 65°49'08" E
	ARC	CC		1807373.14	6585058.86											
	ARC	CS	6293+93.59	1848439.7	6603498.58											
	CLOTHOID	CS	6293+93.59	1848439.7	6603498.58											
	CLOTHOID	SPI	6299+43.71	1848214.36	6604000.42		1650.30	1°03'01"	825.14	2.52					S 65°49'08" E	S 64°46'07" E
	CLOTHOID	ST	6310+43.89	1847745.37	6604995.68											
	TANGENT	ST	6310+43.89	1847745.37	6604995.68		1353.50							S 64°46'07" E		
	TANGENT	TS	6323+97.39	1847168.41	6606220.04											

						DESIGNED BY P. JACOBY	<b>15% DRAFT SUBMITTAL FOR INTERNAL USE ONLY</b>  <b>NOT FOR CONSTRUCTION</b>			<b>CALIFORNIA HIGH-SPEED TRAIN PROJECT MERCED TO FRESNO</b>  HYBRID AVENUE 24/SR152/AVENUE 21 TRACK GEOMETRY DATA	CONTRACT NO. HSR08-05
						DRAWN BY ALBERT S.					DRAWING NO. TJ7403A
						CHECKED BY RESHMA C.					SCALE NO SCALE
						IN CHARGE D. WEMMER					SHEET NO.
						DATE 4/15/2011					
REV	DATE	BY	CHK	APP	DESCRIPTION						



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P0037225

TRACK ALIGNMENT DATA SUMMARY TABLE - NORTHBOUND TRACK

CURVE	ELEMENT	POINT TYPE	STATION	COORDINATES		RADIUS (FT)	LENGTH (FT)	DELTA, Δ	K	P	DESIGN SPEED (MPH)	ACTUAL SUPERELEVATION (EA)(IN)	UNBALANCED SUPERELEVATION (EA)(IN)	WCB (0°00'00") (TANGENT)	WCB (0°00'00")	
				NORTHING	EASTING										START ANGLE	END ANGLE
SR-4-NB	CLOTHOID	TS	6323+97.39	1847168.41	6606220.04											
	CLOTHOID	SPI	6334+97.21	1846699.58	6607214.94		1649.70	1°03'01"	824.84	2.52					S 64°46'07" E	S 65°49'08" E
	CLOTHOID	SC	6340+47.09	1846474.32	6607716.6											
	ARC	SC	6340+47.09	1846474.32	6607716.6											
	ARC	PI	6434+31.15	1842630.41	6616277.26	45000.00	18502.95	23°33'31"			250	4.00	1.56		S 65°49'08" E	S 89°22'40" E
	ARC	CC		1887525.83	6626149.55											
	ARC	CS	6525+50.04	1842528.49	6625660.77											
	CLOTHOID	CS	6525+50.04	1842528.49	6625660.77											
	CLOTHOID	SPI	6530+99.96	1842522.51	6626210.65		1649.70	1°03'01"	824.84	2.52					S 89°22'40" E	N 89°34'20" E
	CLOTHOID	ST	6541+99.74	1842530.73	6627310.44											

REV	DATE	BY	CHK	APP	DESCRIPTION	

DESIGNED BY P. JACOBY
DRAWN BY ALBERT S.
CHECKED BY RESHMA C.
IN CHARGE D. WEMMER
DATE 4/15/2011

15% DRAFT  
SUBMITTAL  
FOR INTERNAL  
USE ONLY

NOT FOR  
CONSTRUCTION



CALIFORNIA  
HIGH-SPEED RAIL AUTHORITY

CALIFORNIA HIGH-SPEED TRAIN PROJECT  
MERCED TO FRESNO

HYBRID  
AVENUE 24/SR152/AVENUE 21  
TRACK GEOMETRY DATA

CONTRACT NO. HSR08-05
DRAWING NO. TJ7404A
SCALE NO SCALE
SHEET NO.



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P0037225

DESIGNED BY	A. GURA
DRAWN BY	J. PAZ
CHECKED BY	S. GOOLLA
IN CHARGE	D. WEMMER
DATE	4/15/2011



CONTRACT NO.	HSR08-05
DRAWING NO.	TJ7903
SCALE	NO SCALE
SHEET NO.	



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P0037225

DESIGNED BY	A. GURA
DRAWN BY	J. PAZ
CHECKED BY	S. GOOLLA
IN CHARGE	D. WEMMER
DATE	4/15/2011



CONTRACT NO.	HSR08-05
DRAWING NO.	TJ7906
SCALE	NO SCALE
SHEET NO.	



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shieldsa

TRACK ALIGNMENT CURVE DATA SUMMARY TABLE-HYBRID AVE 21 MAIN LINE SB

CURVE	DESIGN SPEED (V) (MPH)	RADIUS (R) (FT)	ACTUAL SUPERELEVATION (Ea) (IN)	UNBALANCED SUPERELEVATION (Eu) (IN)	SPIRAL LENGTH (Ls) (FT)	BEGIN DRAWING
HYBRID201	220	19500	5.93	4.00	1350	T1107-A
HYBRID202	250	28000	6.00	2.93	2000	T1115-A
HYBRID203	250	28000	6.00	2.93	2000	T1118-A
HYBRID204	250	28016.5	6.00	2.93	2000	T1121-A
HYBRID205	250	28016.5	6.00	2.93	2000	T1124-A
HYBRID206	250	62000	2.75	1.28	900	T1129-A
HYBRID207	250	28000	6.00	2.93	2000	T1130-A

TRACK ALIGNMENT CURVE DATA SUMMARY TABLE - HYBRID AVE 21-SB MERCED CONNECTION

CURVE	DESIGN SPEED (V) (MPH)	RADIUS (R) (FT)	ACTUAL SUPERELEVATION (Ea) (IN)	UNBALANCED SUPERELEVATION (Eu) (IN)	SPIRAL LENGTH (Ls) (FT)	BEGIN STATION
HYBRID228	150	32000	0	0	220	T2197-A
HYBRID229	150	20224.46	1.25	2.50	220	T2197-A
HYBRID230	150	9200	7.00	4.00	1400	T2197-A
UPRR111	250	28016.5	6.00	2.93	2000	T2205-A
UPRR112	250	28000	6.00	2.93	2000	T2208-A
UPRR113	250	28000	6.00	2.93	2000	T2209-A
UPRR114	250	28016.5	6.00	2.93	2000	T2211-A
UPRR115	150	10000	6.00	3.00	1200	T2225-A

TRACK ALIGNMENT CURVE DATA SUMMARY TABLE - UPRR WYE-SB CONNECTION AVE 21

CURVE	DESIGN SPEED (V) (MPH)	RADIUS (R) (FT)	ACTUAL SUPERELEVATION (Ea) (IN)	UNBALANCED SUPERELEVATION (Eu) (IN)	SPIRAL LENGTH (Ls) (FT)	BEGIN DRAWING
UPRR118	150	32000	0	0	220	T2260-A
UPRR119	150	24000.00	1.25	2.50	220	T2260-A
UPRR120	140	8815.0	6.00	2.89	1200	T2261-A
UPRR121	150	32000	3.19	2.81	220	T2266-A

TRACK ALIGNMENT CURVE DATA SUMMARY TABLE-HYBRID AVE 21 MAIN LINE NB

CURVE	DESIGN SPEED (V) (MPH)	RADIUS (R) (FT)	ACTUAL SUPERELEVATION (Ea) (IN)	UNBALANCED SUPERELEVATION (Eu) (IN)	SPIRAL LENGTH (Ls) (FT)	BEGIN DRAWING
HYBRID101	220	19516.5	5.93	4.00	1350	T1107-A
HYBRID102	250	28016.5	6.00	2.93	2000	T1115-A
HYBRID103	250	28016.5	6.00	2.93	2000	T1118-A
HYBRID104	250	28000	6.00	2.93	2000	T1121-A
HYBRID105	250	28000	6.00	2.93	2000	T1124-A
HYBRID106	250	62016.5	2.75	1.28	900	T1129-A
HYBRID107	250	28016.5	6.00	2.93	2000	T1130-A

TRACK ALIGNMENT CURVE DATA SUMMARY TABLE - HYBRID AVE 21-NB MERCED CONNECTION

CURVE	DESIGN SPEED (V) (MPH)	RADIUS (R) (FT)	ACTUAL SUPERELEVATION (Ea) (IN)	UNBALANCED SUPERELEVATION (Eu) (IN)	SPIRAL LENGTH (Ls) (FT)	BEGIN DRAWING
HYBRID128	150	32000	0	0	220	T2201-A
HYBRID129	150	24000	1.25	2.50	220	T2201-A
HYBRID130	150	9200	7.00	4.00	1400	T2201-A
UPRR211	250	28000	6.00	2.93	2000	T2205-A
UPRR212	250	28016.5	6.00	2.93	2000	T2208-A
UPRR213	250	28016.5	6.00	2.93	2000	T2209-A
UPRR214	250	28000	6.00	2.93	2000	T2211-A
UPRR215	150	10016.5	6.00	3.00	1200	T2225-A

TRACK ALIGNMENT CURVE DATA SUMMARY TABLE - UPRR WYE-NB CONNECTION AVE 21

CURVE	DESIGN SPEED (V) (MPH)	RADIUS (R) (FT)	ACTUAL SUPERELEVATION (Ea) (IN)	UNBALANCED SUPERELEVATION (Eu) (IN)	SPIRAL LENGTH (Ls) (FT)	BEGIN DRAWING
UPRR218	150	32000	0	0	220	T2250-A
UPRR219	150	24020.25	1.25	2.50	220	T2150-A
UPRR220	140	9000	6.00	2.71	1200	T2251-A
UPRR221	150	24020.25	1.25	2.50	220	T2155-A
UPRR222	150	32000	3.19	2.81	220	T2256-A

REV	DATE	BY	CHK	APP	DESCRIPTION	

DESIGNED BY A. SHIELDS
DRAWN BY A. SHIELDS
CHECKED BY A. BOONE
IN CHARGE A. BOONE
DATE 07/20/2011

RECORD SET  
15% DESIGN  
SUBMITTAL

NOT FOR  
CONSTRUCTION



CALIFORNIA  
HIGH-SPEED RAIL AUTHORITY

CALIFORNIA HIGH-SPEED TRAIN PROJECT  
MERCED TO FRESNO

HYBRID ALIGNMENT  
AVENUE 21  
TRACK GEOMETRY DATA  
SHEET 1 OF 1

CONTRACT NO. HSR06-007
DRAWING NO. T0150-A
SCALE NO SCALE
SHEET NO. OF ###





1. TRACK, UCS POLES AND FOUNDATIONS, CABLE DUCTS AND DRAINAGE ARE SCHEMATIC AND DO NOT REPRESENT DESIGN.
2. RIGHT-OF-WAY REQUIRED FOR THE HIGH-SPEED RAIL GUIDEWAY WILL DEPEND UPON CONDITIONS ALONG THE ALIGNMENT, INCLUDING TERRAIN, WHERE CUT/FILL SLOPES, RETAINING STRUCTURES, AND ACCESS ARE REQUIRED.
3. SEE STRUCTURES, VIADUCT AND TUNNEL PLANS FOR DETAILED CROSS SECTIONS OF STRUCTURES.
4. BALLASTED OR UNBALLASTED TRACK STRUCTURE TO BE DETERMINED.

## STATION 5468+71.16 TO 5494+50.00



STATION 5494+50.00 TO 5582+51.76  
STATION 6095+69.95 TO 6147+15.51  
STATION 6277+56.72 TO 6310+30.54  
STATION 6323+90.04 TO 6542+00.08



						DESIGNED BY P. JACOBY	<b>15% DRAFT SUBMITTAL FOR INTERNAL USE ONLY</b>  <b>NOT FOR CONSTRUCTION</b>			<b>CALIFORNIA HIGH-SPEED TRAIN PROJECT MERCED TO FRESNO</b>  HYBRID AVENUE 24/SR152/AVENUE 21 TYPICAL SECTION	CONTRACT NO. HSR08-05
						DRAWN BY ALBERT S.					DRAWING NO. TJ3401A
						CHECKED BY RESHMA C.					
						IN CHARGE D. WEMMER					SCALE 1"=10'
						DATE 4/15/2011					SHEET NO.
REV	DATE	BY	CHK	APP	DESCRIPTION						

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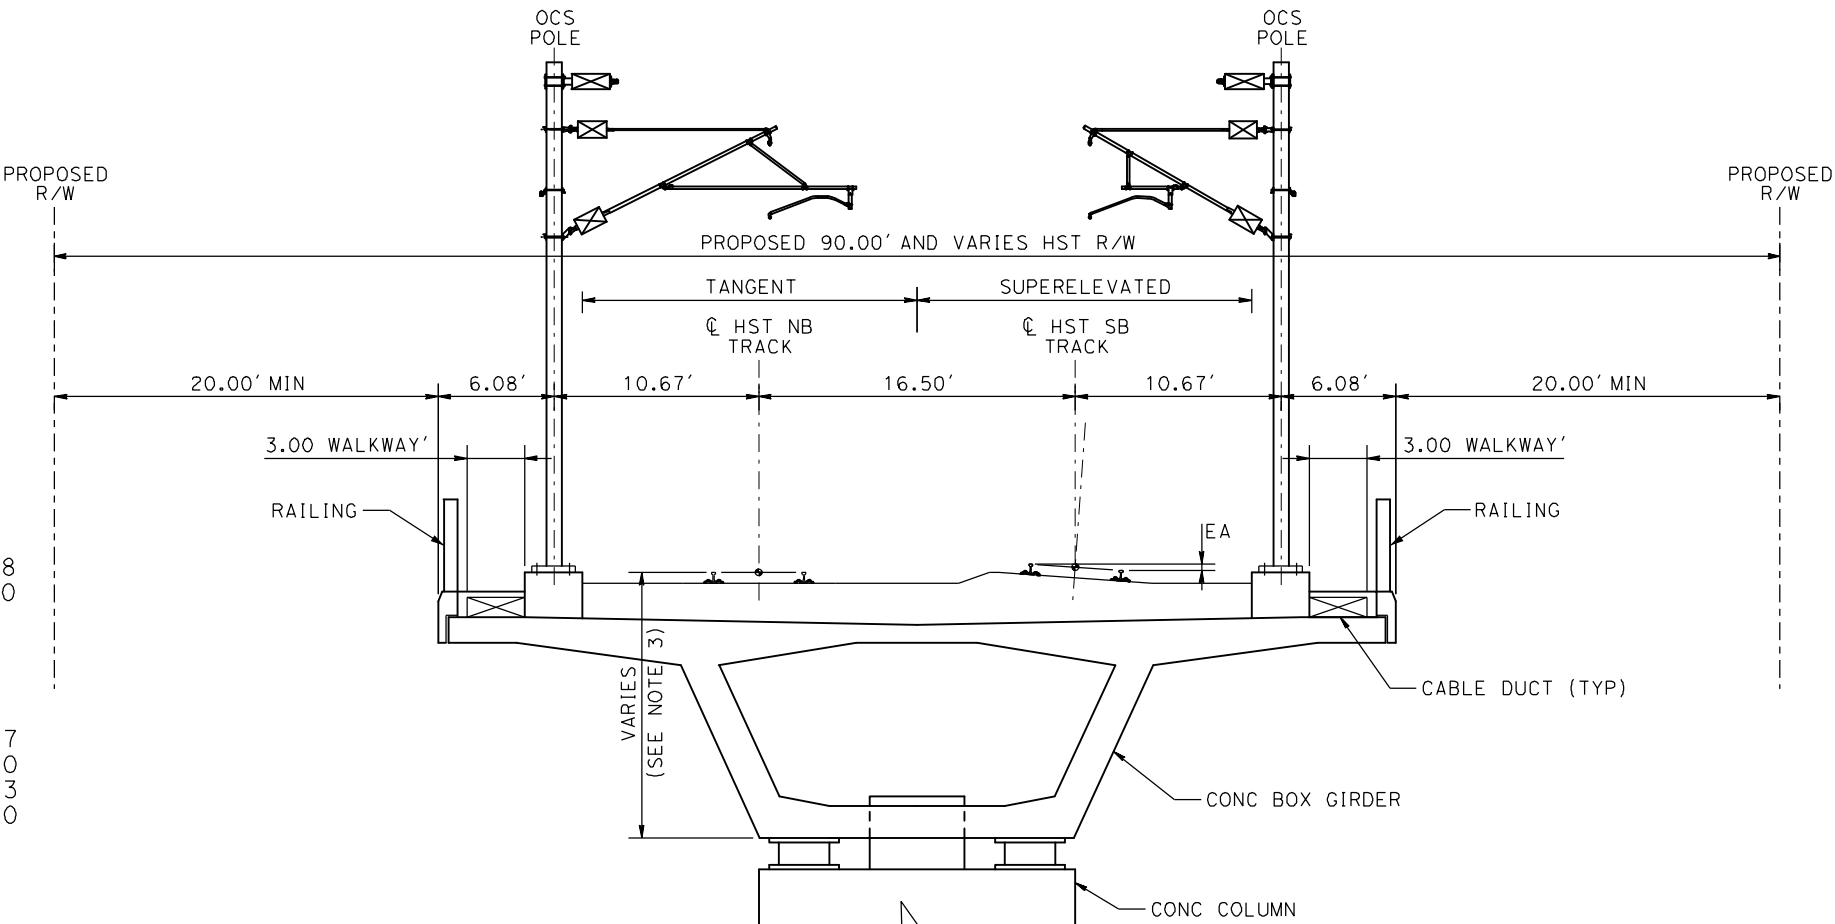
NOTE:  
POTENTIAL SOUND BARRIERS NOT SHOWN IN CROSS SECTIONS. FOR THE EXTENT OF POTENTIAL SOUND BARRIERS, SEE ALIGNMENT PLAN AND PROFILE SHEETS

**SECTION A-A**  
TANGENT

STATION 5617+79.47 TO 5656+79.58  
STATION 5807+75.83 TO 5906+50.00

SUPERELEVATED

STATION 5617+00.00 TO 5617+79.47  
STATION 5656+79.58 TO 5703+50.00  
STATION 5764+00.00 TO 5807+75.83  
STATION 6178+00.00 TO 6248+00.00



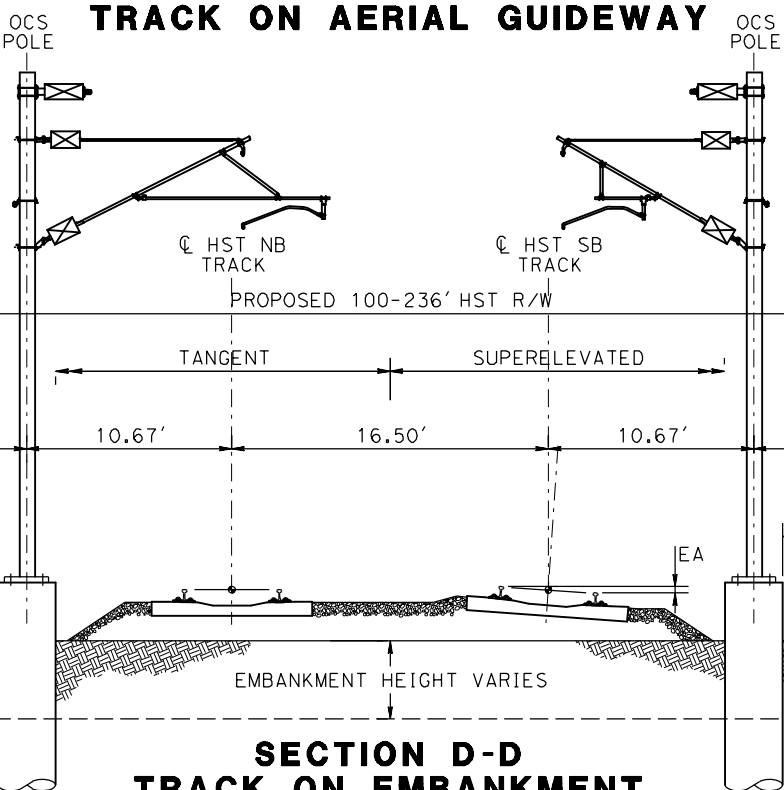
**SECTION B-B**  
TANGENT

STATION 5906+50.00 TO 5944+30.06

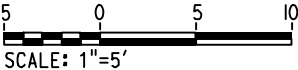
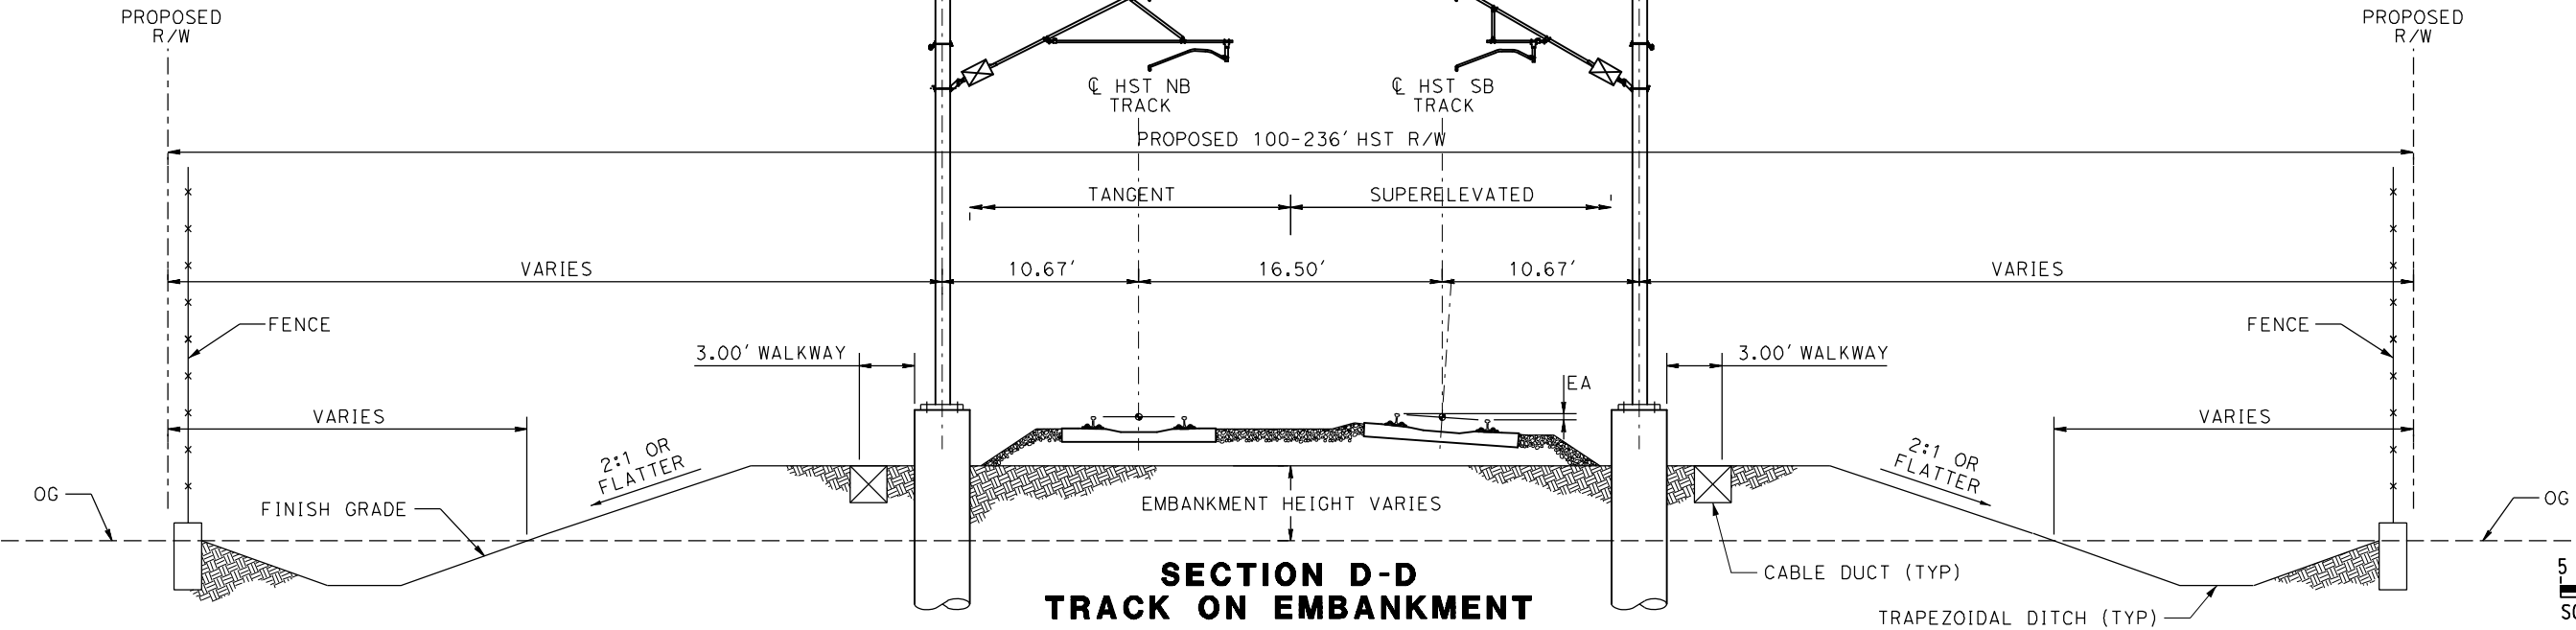
SUPERELEVATED

STATION 5582+51.76 TO 5617+00.00  
STATION 5703+50.00 TO 5764+00.00  
STATION 6147+15.51 TO 6178+00.00  
STATION 6248+00.00 TO 6277+56.72

**SECTION C-C**  
**TRACK ON AERIAL GUIDEWAY**



**SECTION D-D**  
**TRACK ON EMBANKMENT**



7/21/2011 1:14:48 PM c:\pwworking\p0037225\dms66818\JM-TJ-3402A.dgn

REV	DATE	BY	CHK	APP	DESCRIPTION

DESIGNED BY  
**P. JACOBY**  
DRAWN BY  
**ALBERT S.**  
CHECKED BY  
**RESHMA C.**  
IN CHARGE  
**D. WEMMER**  
DATE  
**4/15/2011**

**15% DRAFT  
SUBMITTAL  
FOR INTERNAL  
USE ONLY**  
  
**NOT FOR  
CONSTRUCTION**

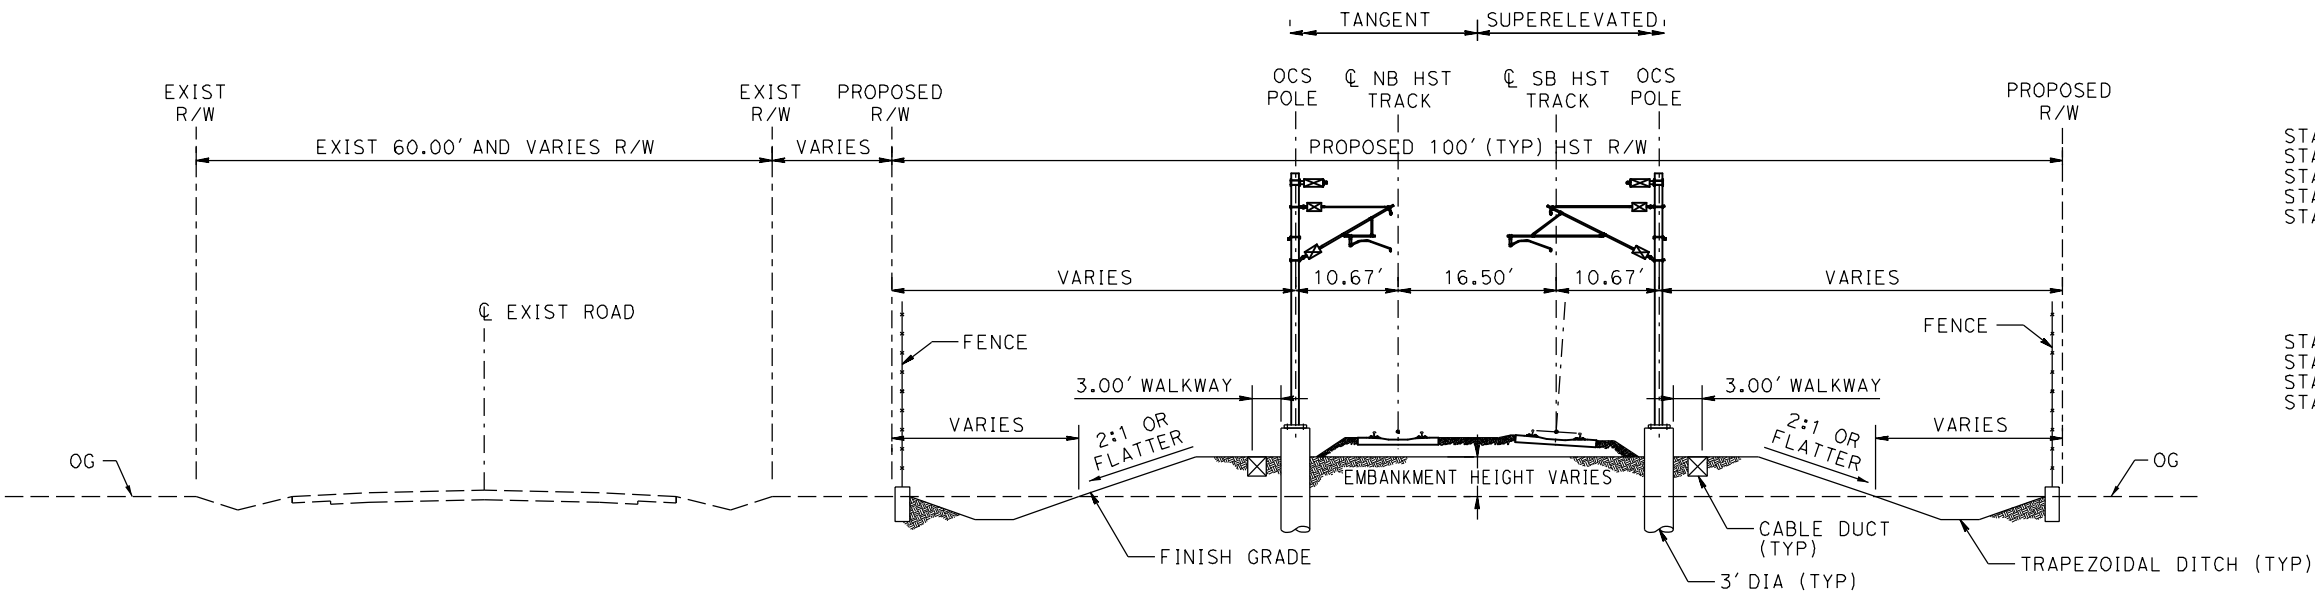


**CALIFORNIA HIGH-SPEED TRAIN PROJECT  
MERCED TO FRESNO**  
HYBRID  
AVENUE 24/SR152/AVENUE 21  
TYPICAL SECTION

CONTRACT NO.  
**HSR08-05**  
DRAWING NO.  
**TJ3402A**  
SCALE  
**1"=5'**  
SHEET NO.



NOTE:  
POTENTIAL SOUND BARRIERS NOT SHOWN IN CROSS SECTIONS. FOR THE EXTENT OF POTENTIAL SOUND BARRIERS, SEE ALIGNMENT PLAN AND PROFILE SHEETS



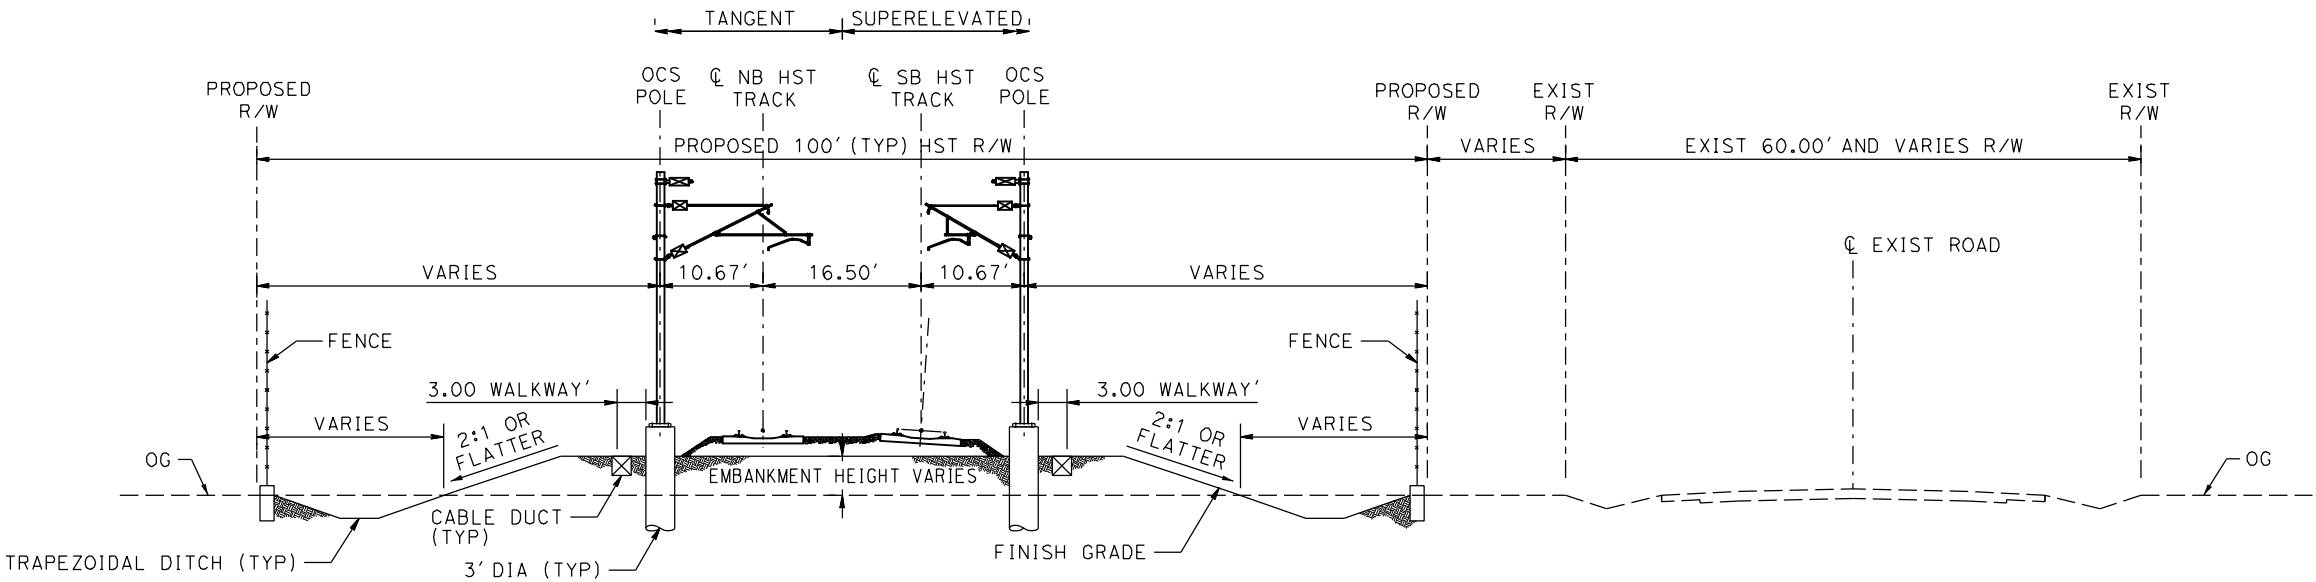
SECTION C-C  
TRACK ON EMBANKMENT WITH ADJACENT ROAD

SECTION C  
TANGENT

STATION A 4695+35.55 TO A 4697+25.00  
STATION A 4782+00.00 TO A 4821+82.78  
STATION A 4842+01.13 TO A 4956+10.00  
STATION A 5038+90.00 TO A 5254+31.95  
STATION A 5289+21.13 TO A 5367+74.09

SUPERELEVATED

STATION A 4663+00.00 TO A 4695+35.55  
STATION A 4821+82.78 TO A 4842+01.13  
STATION A 5254+31.95 TO A 5289+21.13  
STATION A 5367+74.09 TO A 5400+00.00



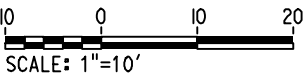
SECTION D-D  
TRACK ON EMBANKMENT WITH ADJACENT ROAD

SECTION D  
TANGENT

STATION A 5953+15.11 TO A 6065+36.88  
STATION A 6085+46.45 TO A 6097+25.00  
STATION A 6163+75.00 TO A 6248+11.13  
STATION A 6268+87.43 TO A 6389+93.79  
STATION A 6412+62.12 TO A 6748+12.50  
STATION A 6498+46.27 TO A 6506+31.89

SUPERELEVATED

STATION A 4639+00.00 TO A 4663+00.00  
STATION A 5900+95.00 TO A 5953+15.11  
STATION A 6065+36.88 TO A 6085+46.45  
STATION A 6248+11.13 TO A 6268+87.43  
STATION A 6389+93.79 TO A 6412+62.12  
STATION A 6748+12.50 TO A 6498+46.27

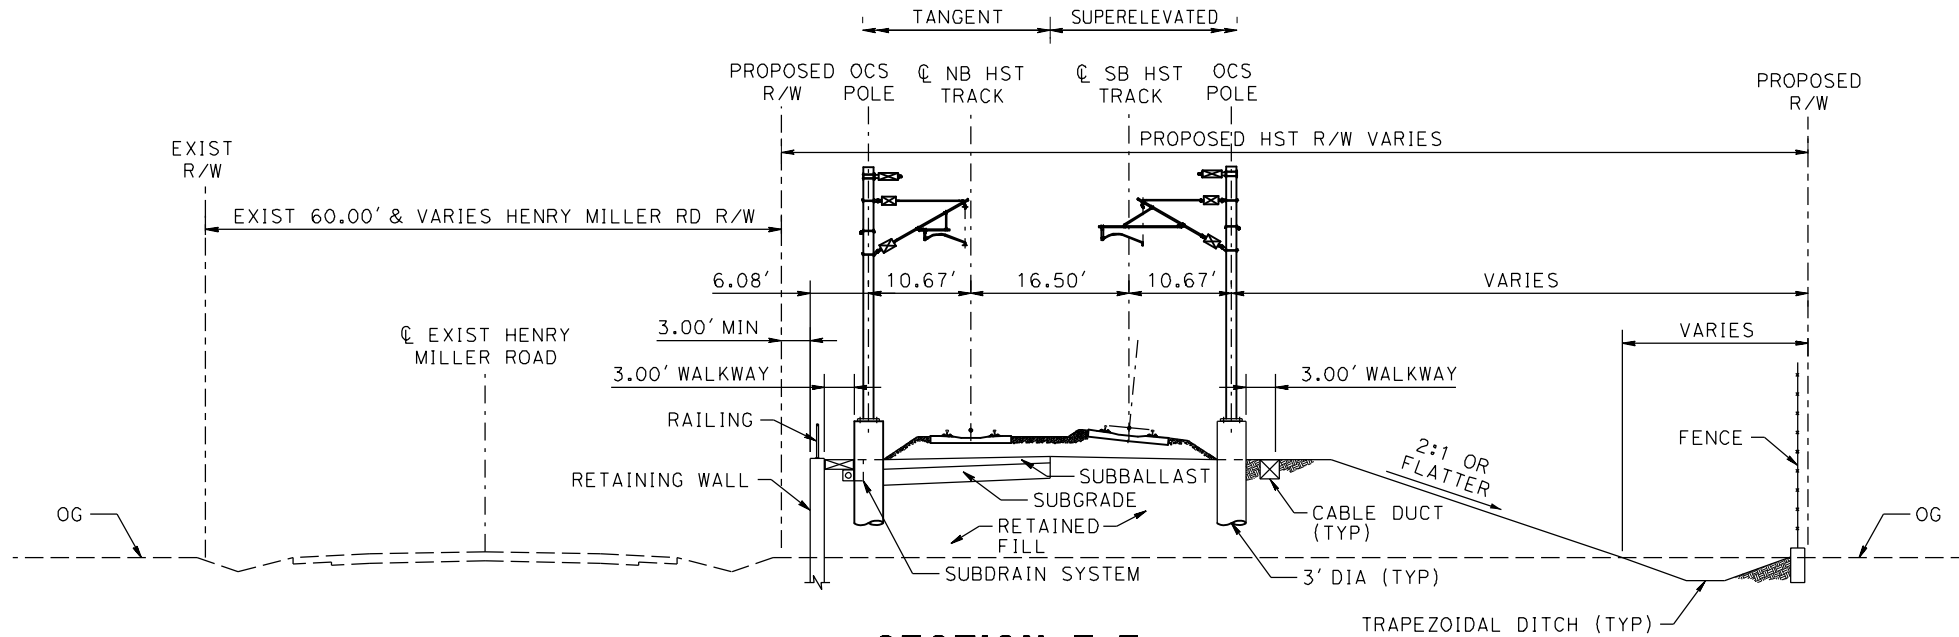


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7/2 P0037225						
		4/15/11				DRAFT 15% SUBMITTAL
REV	DATE	BY	CHK	APP	DESCRIPTION	

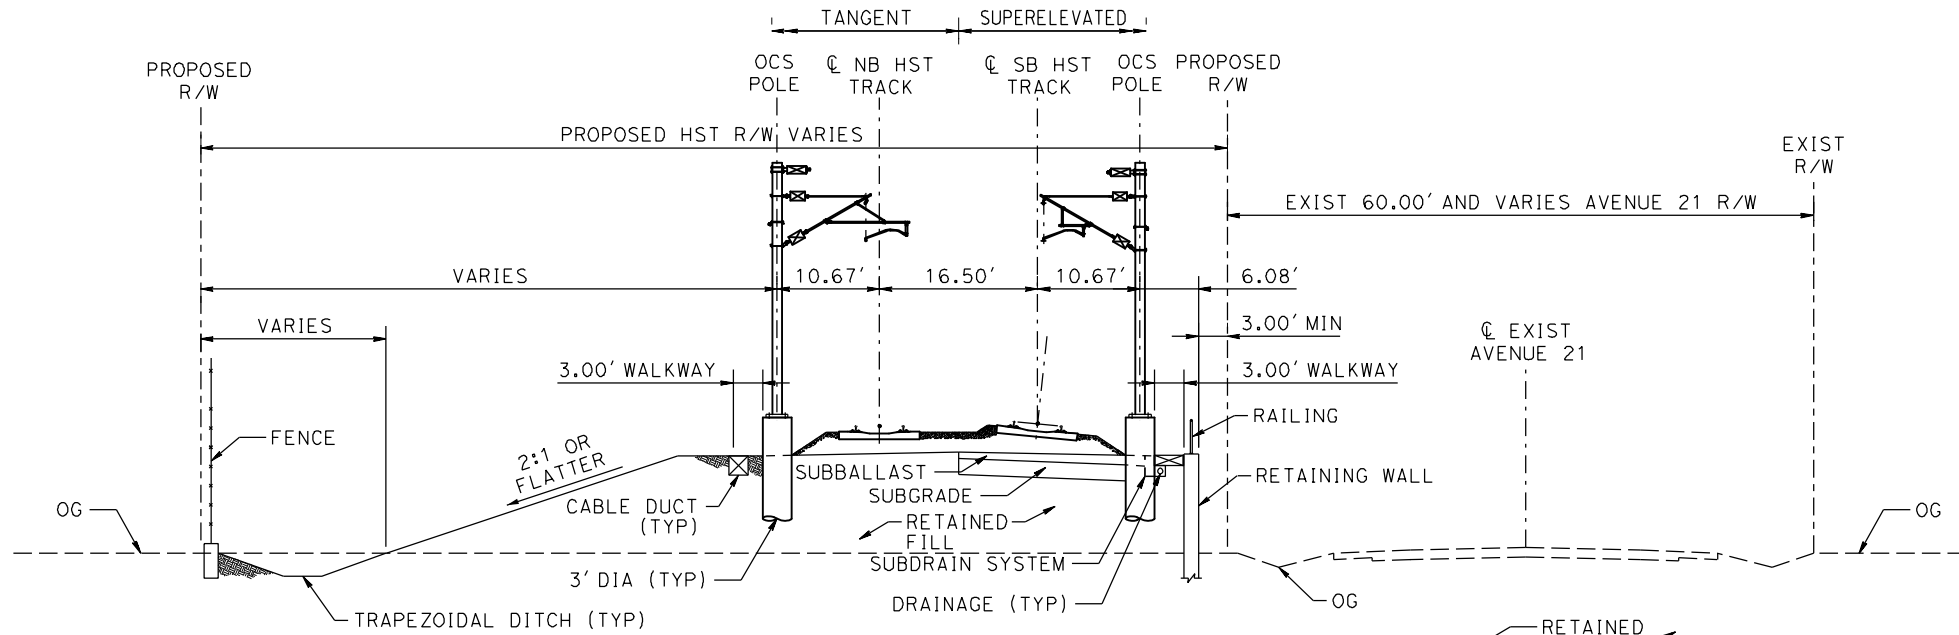


NOTE: POTENTIAL SOUND BARRIERS NOT SHOWN IN CROSS SECTIONS. FOR THE EXTENT OF POTENTIAL SOUND BARRIERS, SEE ALIGNMENT PLAN AND PROFILE SHEETS



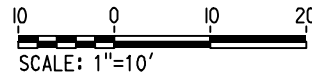
**SECTION E-E**  
**TYPICAL SECTION WITH RETAINED FILL ON LEFT**

TANGENT STATION A 4697+25 TO A 4723+88  
STATION A 4767+88 TO A 4782+00  
SUPERELEVATED N/A



**SECTION E-E**  
**TYPICAL SECTION WITH RETAINED FILL ON RIGHT**

TANGENT STATION A 6097+25 TO A 6116+75  
STATION A 6142+00 TO A 6163+75  
SUPERELEVATED N/A



\$USER\$ \$DATE\$ \$TIME\$ \$FILE\$

REV	DATE	BY	CHK	APP	DESCRIPTION

DESIGNED BY  
**A. GURA**  
DRAWN BY  
**A. GURA**  
CHECKED BY  
**S. GOOLLA**  
IN CHARGE  
**D. WEMMER**  
DATE  
**4/15/2011**

**15% DRAFT  
SUBMITTAL  
FOR INTERNAL  
USE ONLY**

**NOT FOR  
CONSTRUCTION**



**CALIFORNIA HIGH-SPEED TRAIN PROJECT**  
**MERCED TO FRESNO**  
HYBRID  
AVENUE 21  
TYPICAL SECTIONS  
SHEET 3 OF 3

CONTRACT NO.  
**HSR08-05**  
DRAWING NO.  
**TJ3903**  
SCALE  
**1" = 10'**  
SHEET NO.



7/20/2011 3:31:25 PM i:\chsr\60022962\Task-02\_merced-fresno\cadd\civil\sheet\trackwork\deir\typical\_sections\WF-T-3000-A.dgn

ShieldsA

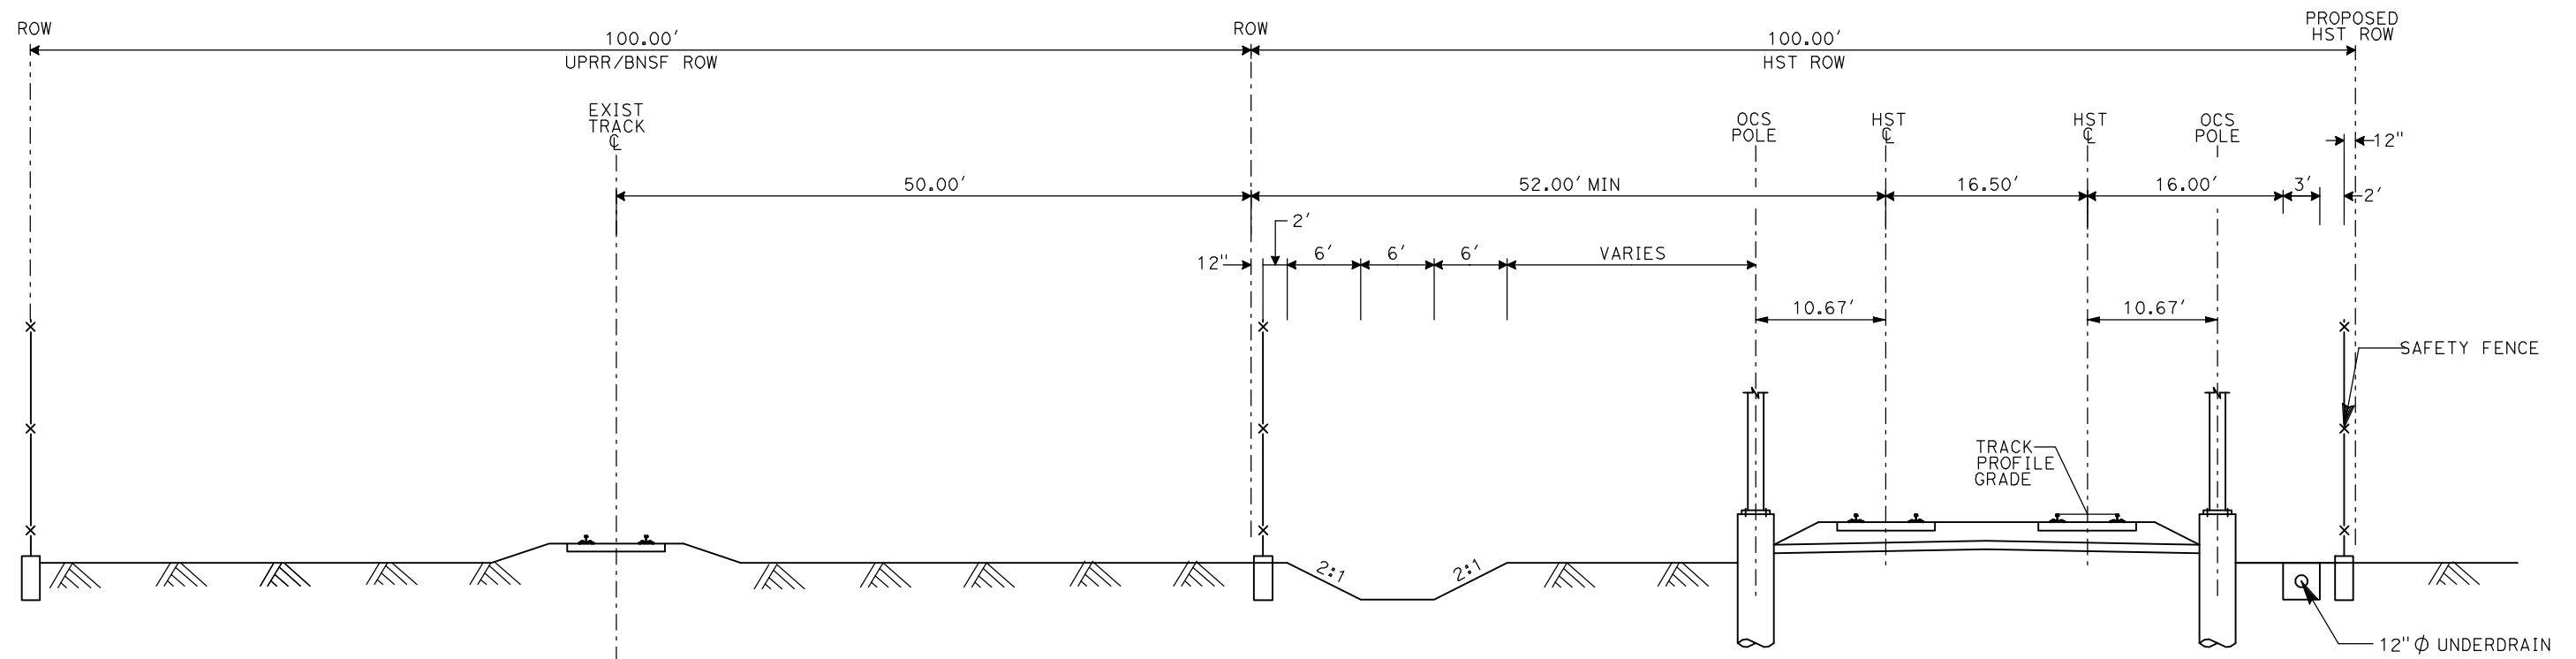
ALTERNATIVE HYBRID AVENUE 24			
ALIGNMENT	BEGIN STATION	END STATION	SECTION
HYBRID 24	892+90	926+80	AG2
	926+80	1020+00	WYE1
	1020+00	1185+00	AG2
	1185+00	1230+00	WYE1
	1230+00	1360+00	AG2
	1360+00	1375+00	RF2
	1375+00	1435+00	EL1
	1435+00	1443+00	RF2
	1443+00	2681+00	AG2
	2681+00	2695+00	RF2
	2695+00	2731+50	EL1
	2731+50	2740+55	EL5
HYBRID-FR	1713+98	1737+00	EL6
	1737+00	1764+78	EL7
	1764+78	1767+00	EL8
	1767+00	1788+84	RF3
	1788+84	1843+35	AG6
UPRR/SR 99 WCD0/HYBRID MC SB	5061+66	5015+00	WYE1
	5015+00	5235+00	AG4
	5235+00	5285+00	WYE 1
	5288+00	5556+91	AG2
UPRR/SR 99 WCD0/HYBRID MC NB	5058+80	5110+00	WYE1
	5110+00	5121+00	EL2
	5121+00	5127+00	RF2
	5127+00	5235+00	AG4
	5235+00	5285+00	WYE1
UPRR/SR 99-21MC	5285+00	5597+00	AG2
	5556+98	5910+00	AG1
	5910+00	5916+50	TR2
	5916+50	5917+60	CC1
	5917+60	5925+00	TR2
	5925+00	5977+70	AG1
	5977+70	5989+20	TR2
	5989+20	5990+20	CC1
	5990+20	6003+00	TR2
	6003+00	6022+00	AG1
	6022+00	6040+60	TR2
	6040+60	6042+90	CC1
	6042+90	6052+50	TR1
	6052+50	6066+20	AG5
UPRR/SR 99 WCD0/HYBRID WC NB	148+82	205+00	WYE1
	205+00	211+00	EL2
	211+00	219+00	RF2
	219+00	313+50	AG4
	313+50	320+00	RF2
	320+00	330+00	EL2
	330+00	382+25	WYE1
UPRR/SR 99 WCD0/HYBRID WC SB	524+67	570+00	WYE1
	570+00	695+00	AG4
	695+00	738+88	WYE1

ALTERNATIVE HYBRID AVENUE 21			
ALIGNMENT	BEGIN STATION	END STATION	SECTION
HYBRID 21	892+90	330+00	AG2
	330+00	430+00	WYE1
	430+00	565+00	AG2
	565+00	580+00	RF2
	580+00	630+00	EL1
	630+00	640+00	RF2
	640+00	680+00	WYE1
	680+00	868+87=	AG2
	1865+00	2681+00	AG2
	2681+00	2695+00	RF2
	2695+00	2731+50	EL1
	2731+50	2740+55	EL5
HYBRID-FR	1713+98	1737+00	EL6
	1737+00	1764+78	EL7
	1764+78	1767+00	EL8
	1767+00	1788+84	RF3
	1788+84	1843+35	AG6
HYBRID MC SB - 21	1843+35	1893+95	RF3
	1893+95	1958+00	AG6
	1958+00	2072+36	AG7
HYBRID MC NB - 21	200+20	250+00	WYE1
	250+00	290+00	EL2
	290+00	377+99	EL1
UPRR/SR 99-21MC	500+00	550+00	WYE1
	550+00	590+00	EL2
	590+00	677+40	EL1
UPRR/SR 99-21WC NB	4907+27	4975+00	EL1
	4975+00	5045+00	WYE2
	5045+00	5385+00	EL1
	5385+00	5425+00	RF2
	5425+00	5910+00	AG1
	5910+00	5915+50	TR2
	5915+50	5916+60	CC1
	5916+60	5924+00	TR2
	5924+00	5977+70	AG1
	5977+70	5989+30	TR2
	5989+30	5990+40	CC1
	5990+40	6003+00	TR2
	6003+00	6022+00	AG1
	6022+00	6040+60	TR2
	6040+60	6042+90	CC1
UPRR/SR 99-21WC SB	6042+90	6052+50	TR1
	6052+50	6066+20	AG5
	505+00	610+00	WYE1
	610+00	619+50	EL2
	619+50	628+35	RF1
	628+35	714+80	AG4
	714+80	724+20	RF1
UPRR/SR 99-21WC SB	724+20	780+00	EL2
	780+00	846+94	WYE2
UPRR/SR 99-21WC SB	105+00	180+00	WYE1
	180+00	298+80	AG4
	298+80	313+21	RF1
	313+21	340+00	EL2
	340+00	397+52	WYE2

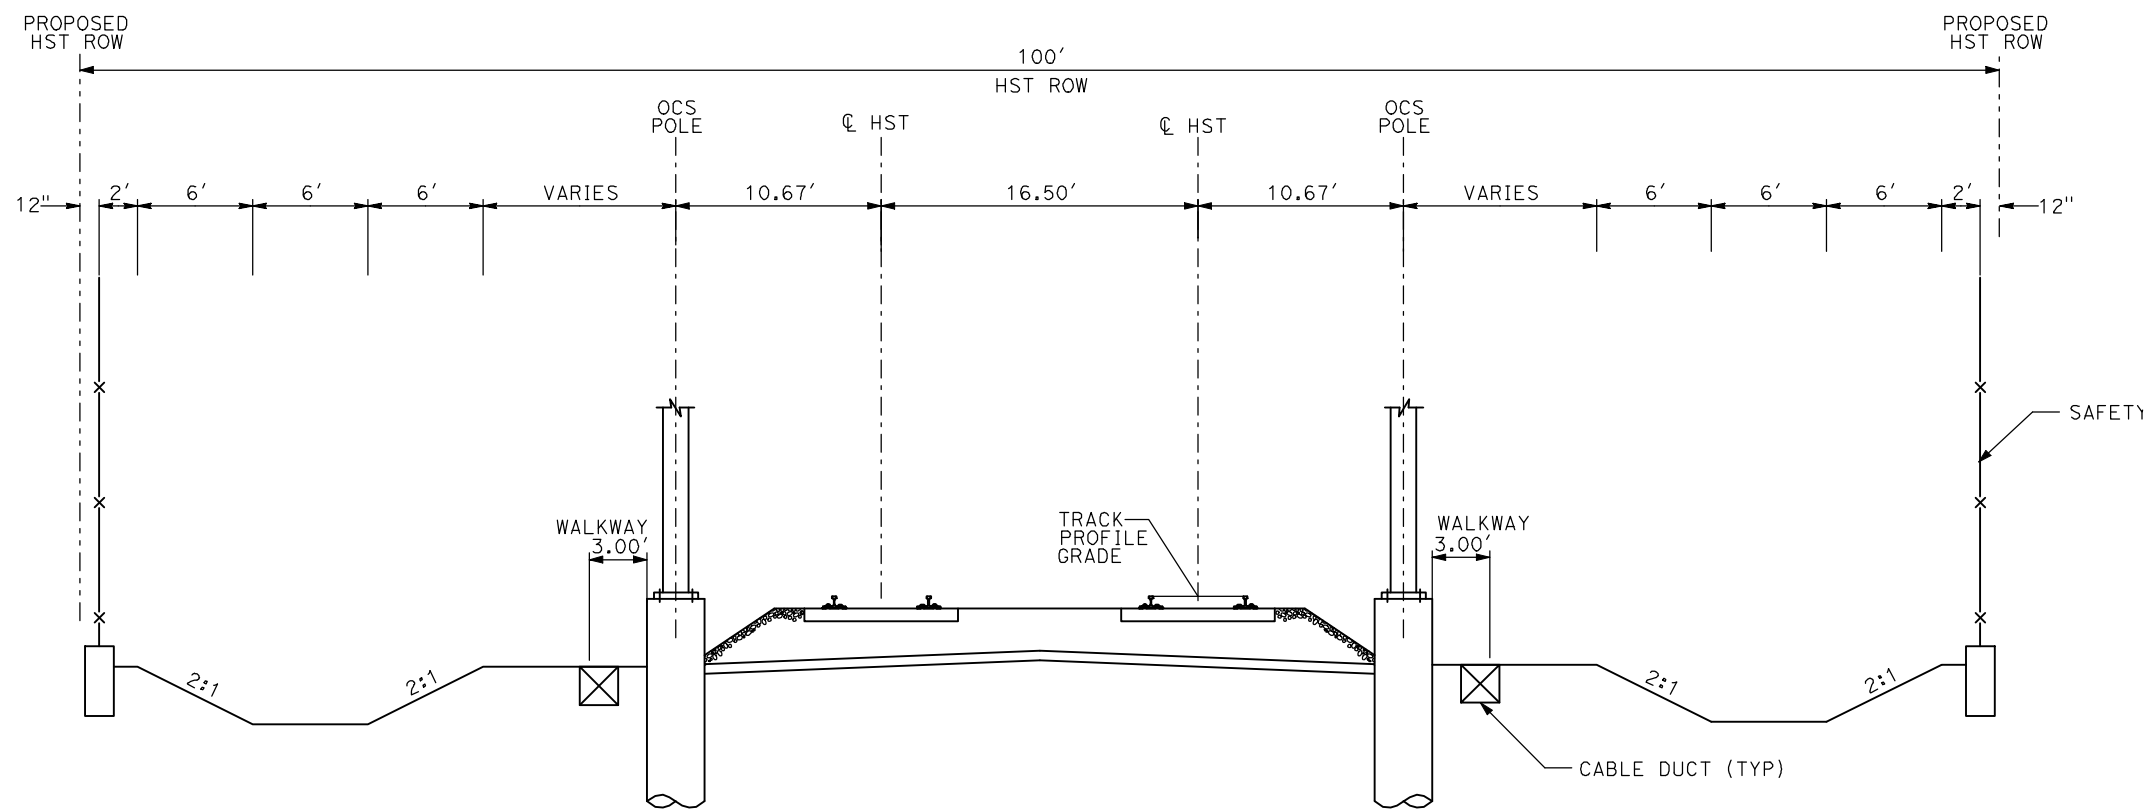
ALTERNATIVE BNSF AVENUE 21			
ALIGNMENT	BEGIN STATION	END STATION	SECTION
BNSF-21ML	267+41	562+00	AG2
	562+00	582+61	RF2
	582+61	634+76	EL1
	634+76	665+80	RF2
	665+80	859+40	AG2
	859+40	881+05	RF2
	881+05	925+00	EL1
	925+00	985+00	WYE1
	985+00	1042+75	EL1
	1042+75	1060+00	RF2
	1060+00	1305+00	AG1
	1305+00	1685+00	AG2
	1685+00	1696+00	RF2
	1667+59	1731+50	EL1
	1731+50	1741+00	EL5
BNSF-FR			
	1713+98	1737+00	EL6
	1737+00	1764+78	EL7
	1764+78	1767+00	EL8
	1767+00	1788+84	RF3
	1788+84	1843+35	AG6
	1843+35	1893+95	RF3
BNSF-21WC NB	1893+95	1958+00	AG6
	1958+00	2072+36	AG7
	105+85	205+00	WYE2
	205+00	220+66	EL2
BNSF-21WC SB	220+66	230+00	RF1
	230+00	357+00	AG4
	357+00	371+02	RF1
	371+02	383+00	EL2
	383+00	474+09	WYE1
BNSF-21WC SB			
	500+00	550+00	WYE2
	550+00	720+00	AG4
BNSF-MC	720+00	765+39	WYE1
	4302+03	4345+02	EL2
BNSF-MC	4345+02	4351+00	RF1
	4351+00	4405+00	WYE1
	4405+00	5296+45	AG1
	5269+45	5266+88	RF2
	5266+88	5352+88	EL3
	5352+88	5371+50	RF2
	5371+50	5850+85	AG1
	5850+85	5866+57	RF2
	5866+57	5960+00	EL1
	5960+00	5967+00	RF2
	5967+00	5977+70	AG1
	5977+70	5989+20	TR2
	5989+20	5990+20	CC1
	5990+20	6003+00	TR2
	6003+00	6022+00	AG1
	6022+00	6040+60	TR2
	6040+60	6042+90	CC1
	6042+90	6052+50	TR1
	6052+50	6066+20	AG5



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AG1- DOUBLE TRACK AT GRADE ADJACENT TO UPRR/BNSF



AG2 - DOUBLE TRACK AT GRADE

- NOTES:
1. TRACK, OCS POLES AND FOUNDATIONS, CABLE DUCTS AND DRAINAGE ARE SCHEMATIC AND DO NOT REPRESENT DESIGN.
  2. RIGHT-OF-WAY REQUIRED FOR THE HIGH-SPEED RAIL GUIDEWAY WILL DEPEND UPON CONDITIONS ALONG THE ALIGNMENT, INCLUDING TERRAIN, WHERE CUT/FILL SLOPES, RETAINING STRUCTURES, AND ACCESS ARE REQUIRED.
  3. POTENTIAL SOUND BARRIERS NOT SHOWN IN CROSS SECTIONS. FOR THE EXTENT OF POTENTIAL SOUND BARRIERS, SEE ALIGNMENT PLAN AND PROFILE SHEETS.

REV	DATE	BY	CHK	APP	DESCRIPTION

DESIGNED BY  
A. SHIELDS  
DRAWN BY  
C. VALADAO  
CHECKED BY  
A. BOONE  
IN CHARGE  
A. BOONE  
DATE  
07/20/2011

RECORD SET  
15% DESIGN  
SUBMITTAL

NOT FOR  
CONSTRUCTION

**AECOM**  
Technical Services, Inc.  
2020 L Street, Suite 300  
Sacramento, CA 95811  
**CH2M HILL**



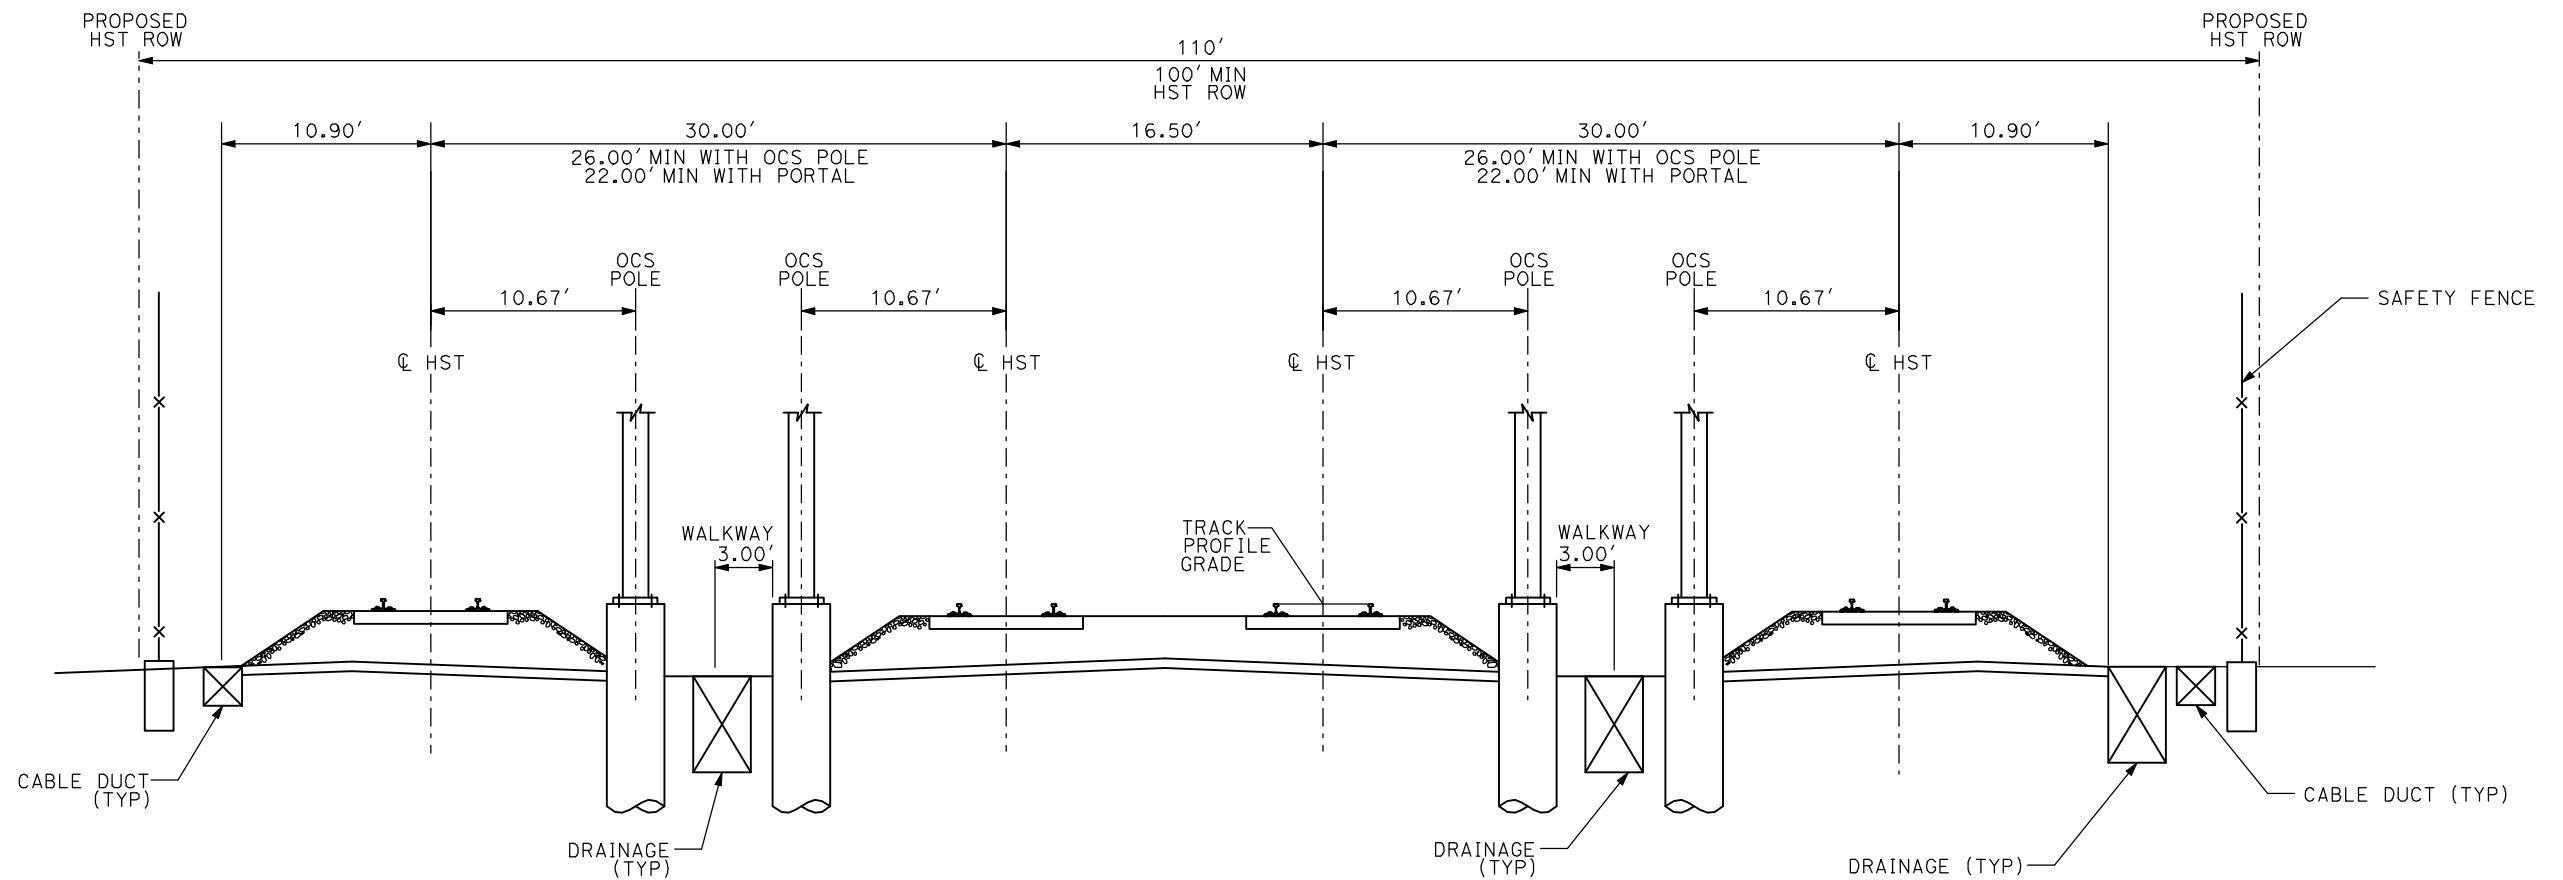
**CALIFORNIA HIGH-SPEED TRAIN PROJECT  
MERCED TO FRESNO**

TYPICAL SECTIONS  
SHEET 1 OF 17

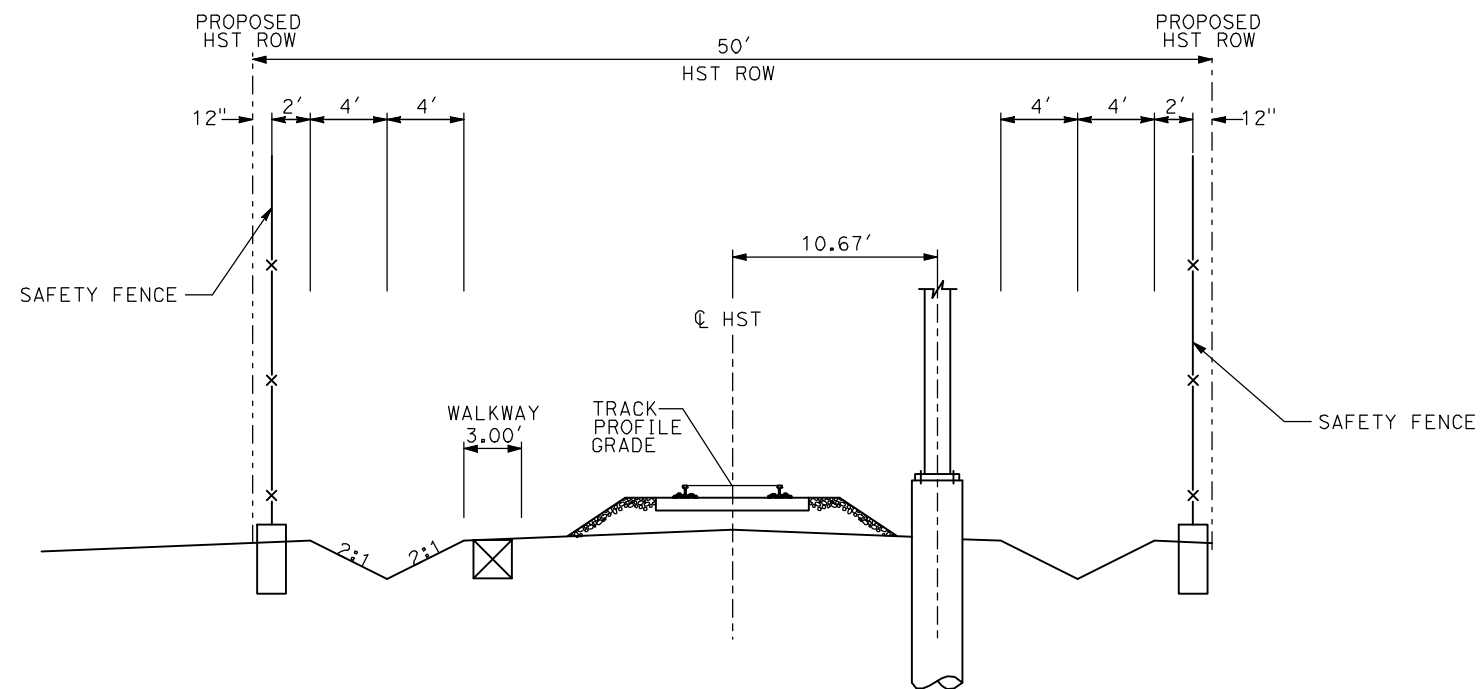
CONTRACT NO.  
HSR06-007  
DRAWING NO.  
T3001-A  
SCALE  
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SHEET NO.  
OF ###



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ShieldsA



AG3 - 4 TRACK AT GRADE



AG4 - SINGLE TRACK AT GRADE

- NOTES:
1. TRACK, OCS POLES AND FOUNDATIONS, CABLE DUCTS AND DRAINAGE ARE SCHEMATIC AND DO NOT REPRESENT DESIGN.
  2. RIGHT-OF-WAY REQUIRED FOR THE HIGH-SPEED RAIL GUIDEWAY WILL DEPEND UPON CONDITIONS ALONG THE ALIGNMENT, INCLUDING TERRAIN, WHERE CUT/FILL SLOPES, RETAINING STRUCTURES, AND ACCESS ARE REQUIRED.
  3. POTENTIAL SOUND BARRIERS NOT SHOWN IN CROSS SECTIONS. FOR THE EXTENT OF POTENTIAL SOUND BARRIERS, SEE ALIGNMENT PLAN AND PROFILE SHEETS.

REV	DATE	BY	CHK	APP	DESCRIPTION

DESIGNED BY  
A. SHIELDS  
DRAWN BY  
C. VALADAO  
CHECKED BY  
A. BOONE  
IN CHARGE  
A. BOONE  
DATE  
07/20/2011

**RECORD SET**  
**15% DESIGN**  
**SUBMITTAL**

**NOT FOR**  
**CONSTRUCTION**

**AECOM**  
Technical Services, Inc.  
2020 L Street, Suite 300  
Sacramento, CA 95811  
**CH2M HILL**

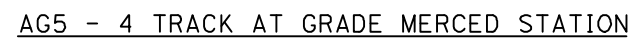


**CALIFORNIA HIGH-SPEED TRAIN PROJECT**  
**MERCED TO FRESNO**

TYPICAL SECTIONS  
SHEET 2 OF 17

CONTRACT NO.	HSR06-007
DRAWING NO.	T3002-A
SCALE	NO SCALE
SHEET NO.	OF ###





- ## CALIFORNIA HIGH-SPEED TRAIN PROJECT MERCED TO FRESNO

CONTRACT NO.	HSR06-007
DRAWING NO.	T3003-A
SCALE	NO SCALE
SHEET NO.	OF ###

						DESIGNED BY A. SHIELDS
						DRAWN BY C. VALADAO
						CHECKED BY A. BOONE
						IN CHARGE A. BOONE
						DATE 07/20/2011
REV	DATE	BY	CHK	APP	DESCRIPTION	

**NOT FOR  
CONSTRUCTION**

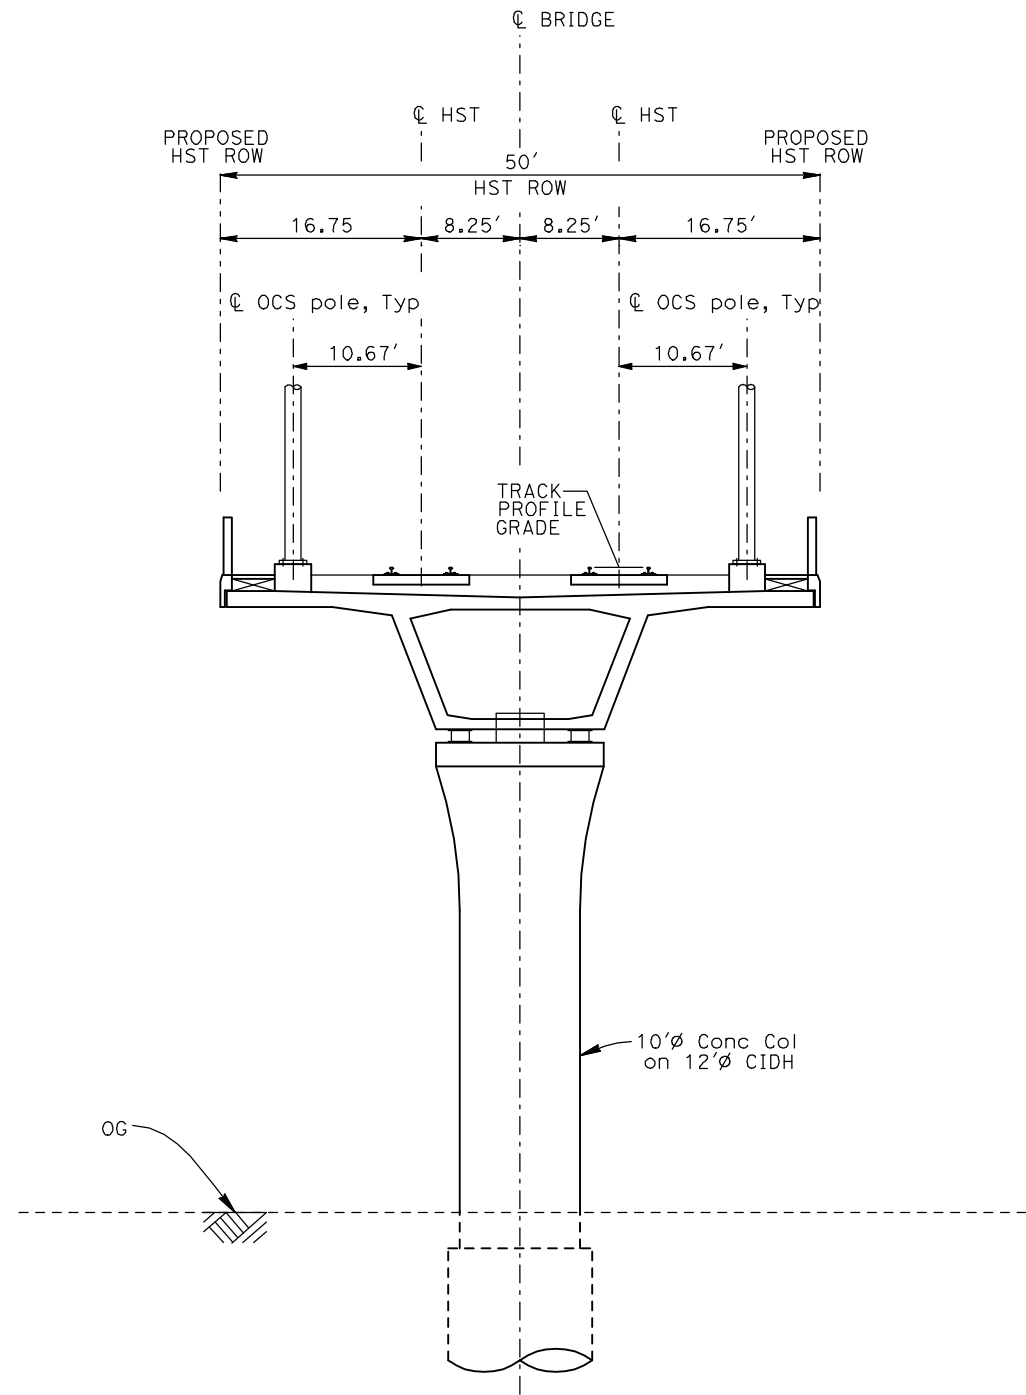
**AECOM**  
Technical Services, Inc.  
2020 L Street, Suite 300  
Sacramento, CA 95811

**CH2MHILL**

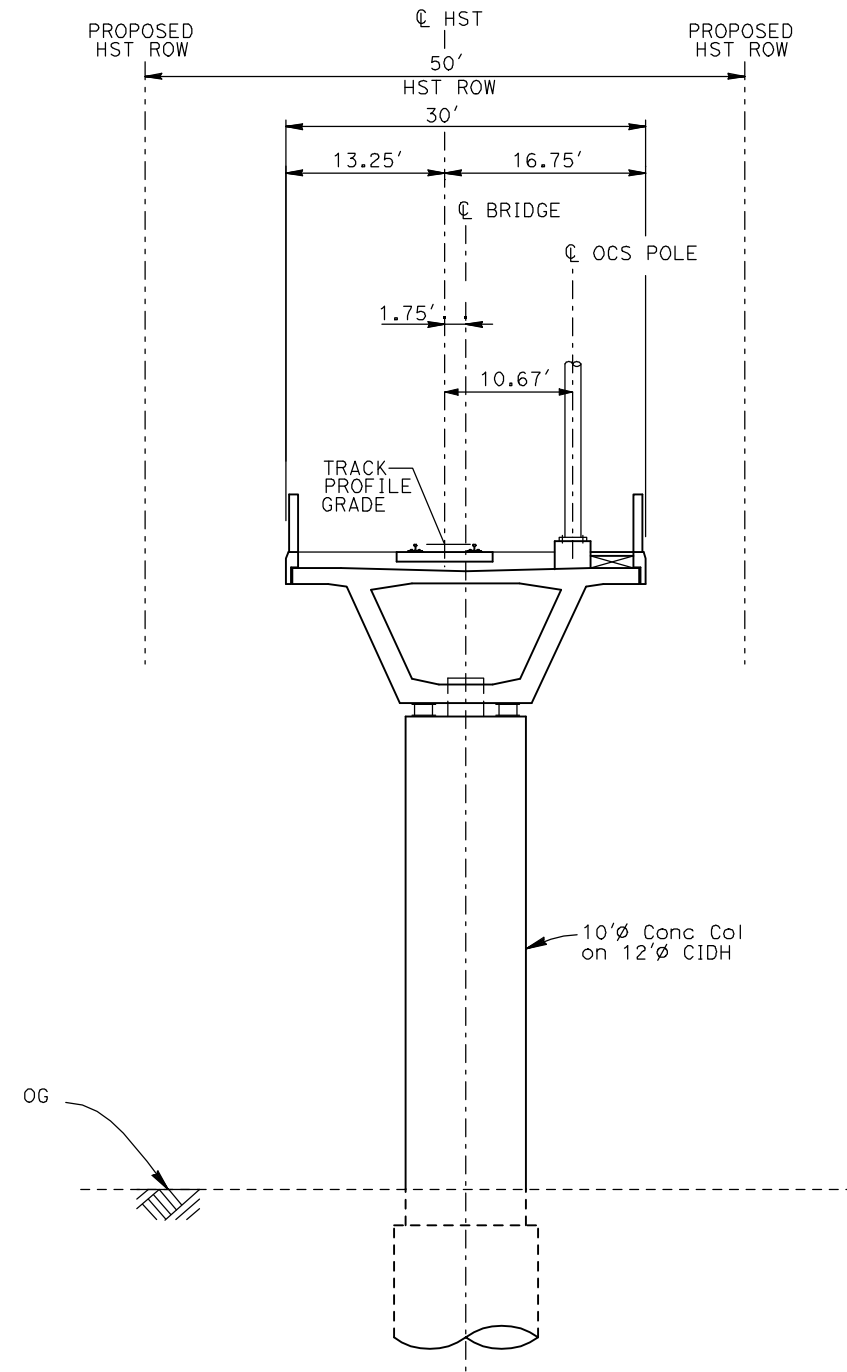




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ShieldsA



EL1 - DOUBLE TRACK ELEVATED



EL2 - SINGLE TRACK ELEVATED

- NOTES:
1. TRACK, OCS POLES AND FOUNDATIONS, CABLE DUCTS AND DRAINAGE ARE SCHEMATIC AND DO NOT REPRESENT DESIGN.
  2. BACK-TO-BACK CANTILEVERS ON A SINGLE POLE MAY BE PERMITTED AT PASSENGER STATIONS.
  3. RIGHT-OF-WAY REQUIRED FOR THE HIGH-SPEED RAIL GUIDEWAY WILL DEPEND UPON CONDITIONS ALONG THE ALIGNMENT, INCLUDING TERRAIN, WHERE CUT/FILL SLOPES, RETAINING STRUCTURES, AND ACCESS ARE REQUIRED.
  4. POTENTIAL SOUND BARRIERS NOT SHOWN IN CROSS SECTIONS. FOR THE EXTENT OF POTENTIAL SOUND BARRIERS, SEE ALIGNMENT PLAN AND PROFILE SHEETS.

REV	DATE	BY	CHK	APP	DESCRIPTION

DESIGNED BY A. SHIELDS
DRAWN BY C. VALADAO
CHECKED BY A. BOONE
IN CHARGE A. BOONE
DATE 07/20/2011

**RECORD SET**  
**15% DESIGN**  
**SUBMITTAL**

**NOT FOR**  
**CONSTRUCTION**

**AECOM**  
Technical Services, Inc.  
2020 L Street, Suite 300  
Sacramento, CA 95811

**CH2M HILL**



**CALIFORNIA HIGH-SPEED TRAIN PROJECT**  
**MERCED TO FRESNO**

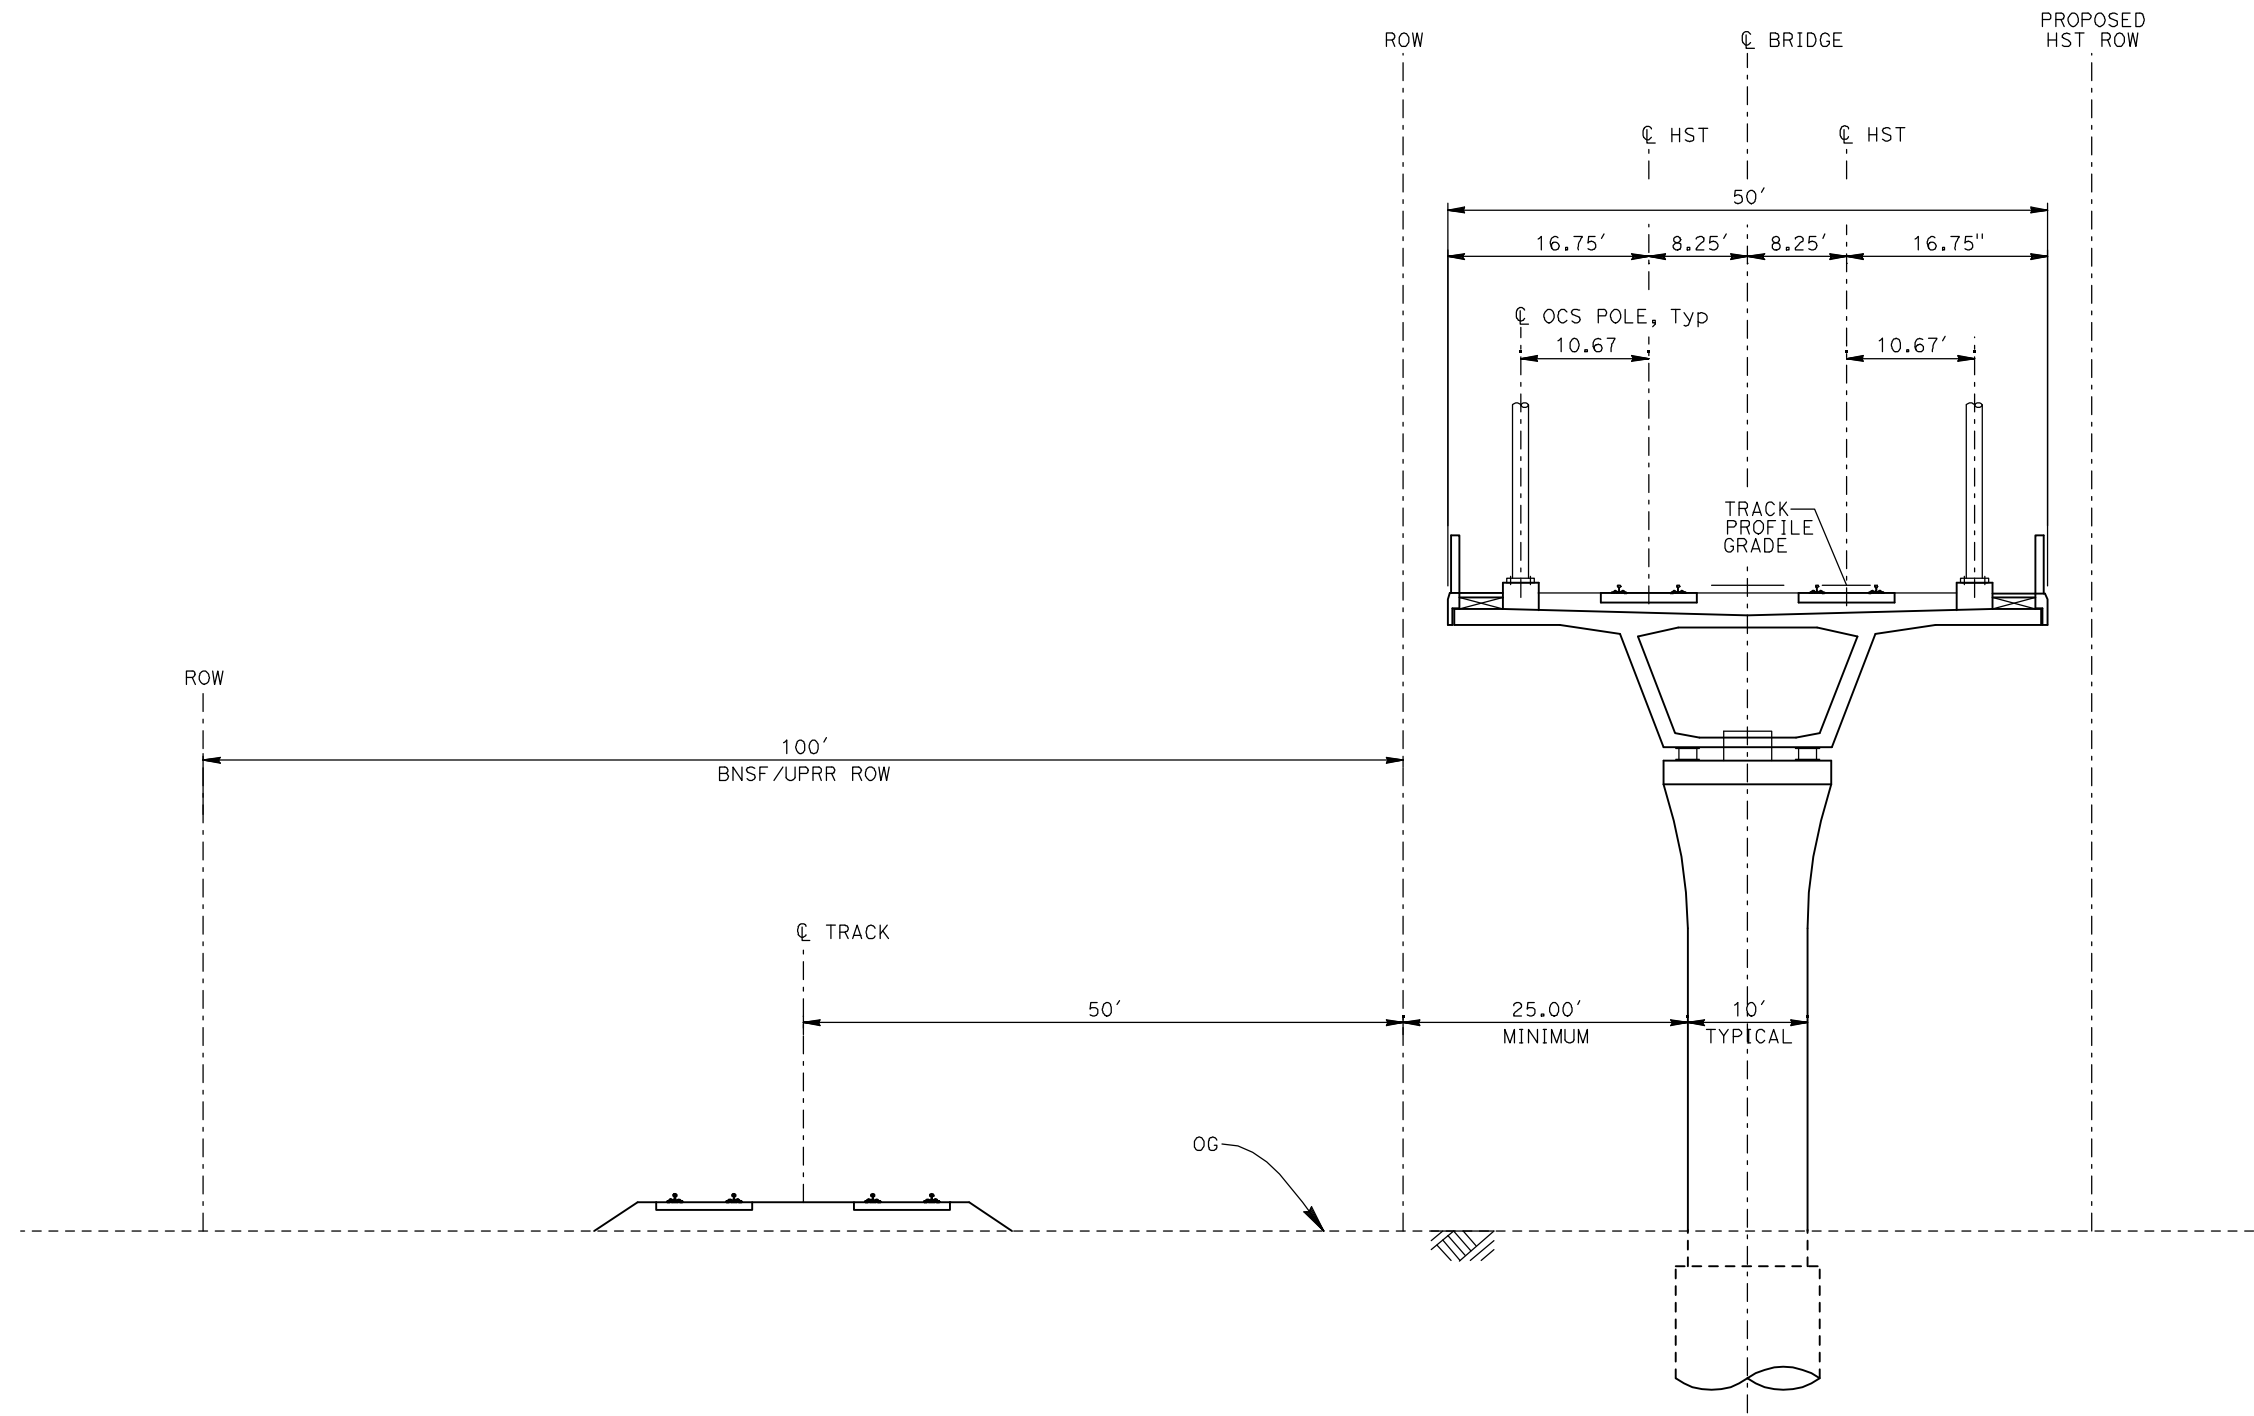
TYPICAL SECTIONS  
SHEET 4 OF 17

CONTRACT NO. HSR06-007
DRAWING NO. T3004-A
SCALE NO SCALE
SHEET NO. OF ###



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ShieldsA



EL3 - DOUBLE TRACK ELEVATED ADJACENT TO UPRR/BNSF

- NOTES:
1. TRACK, OCS POLES AND FOUNDATIONS, CABLE DUCTS AND DRAINAGE ARE SCHEMATIC AND DO NOT REPRESENT DESIGN.
  2. RIGHT-OF-WAY REQUIRED FOR THE HIGH-SPEED RAIL GUIDEWAY WILL DEPEND UPON CONDITIONS ALONG THE ALIGNMENT, INCLUDING TERRAIN, WHERE CUT/FILL SLOPES, RETAINING STRUCTURES, AND ACCESS ARE REQUIRED.
  3. POTENTIAL SOUND BARRIERS NOT SHOWN IN CROSS SECTIONS. FOR THE EXTENT OF POTENTIAL SOUND BARRIERS, SEE ALIGNMENT PLAN AND PROFILE SHEETS.

REV	DATE	BY	CHK	APP	DESCRIPTION

DESIGNED BY  
A. SHIELDS  
DRAWN BY  
C. VALADAO  
CHECKED BY  
A. BOONE  
IN CHARGE  
A. BOONE  
DATE  
07/20/2011

**RECORD SET  
15% DESIGN  
SUBMITTAL**

**NOT FOR  
CONSTRUCTION**

**AECOM**  
Technical Services, Inc.  
2020 L Street, Suite 300  
Sacramento, CA 95811

**CH2M HILL**



**CALIFORNIA HIGH-SPEED TRAIN PROJECT  
MERCED TO FRESNO**

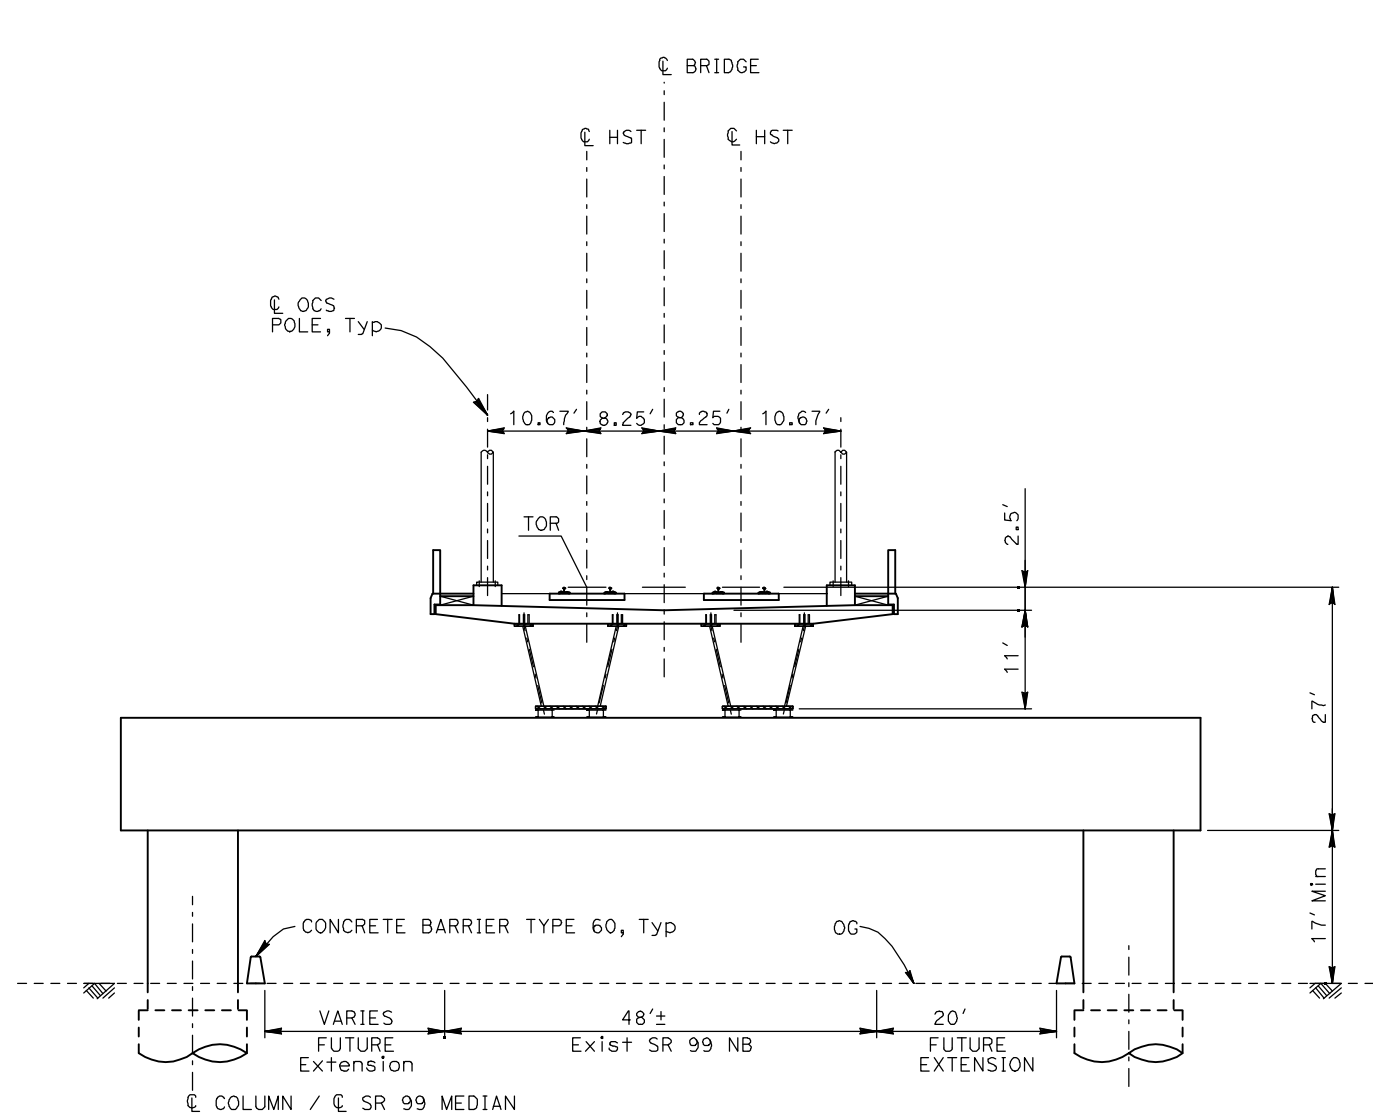
TYPICAL SECTIONS  
SHEET 5 OF 17

CONTRACT NO.  
HSR06-007  
DRAWING NO.  
T3005-A  
SCALE  
NO SCALE  
SHEET NO.  
OF ###

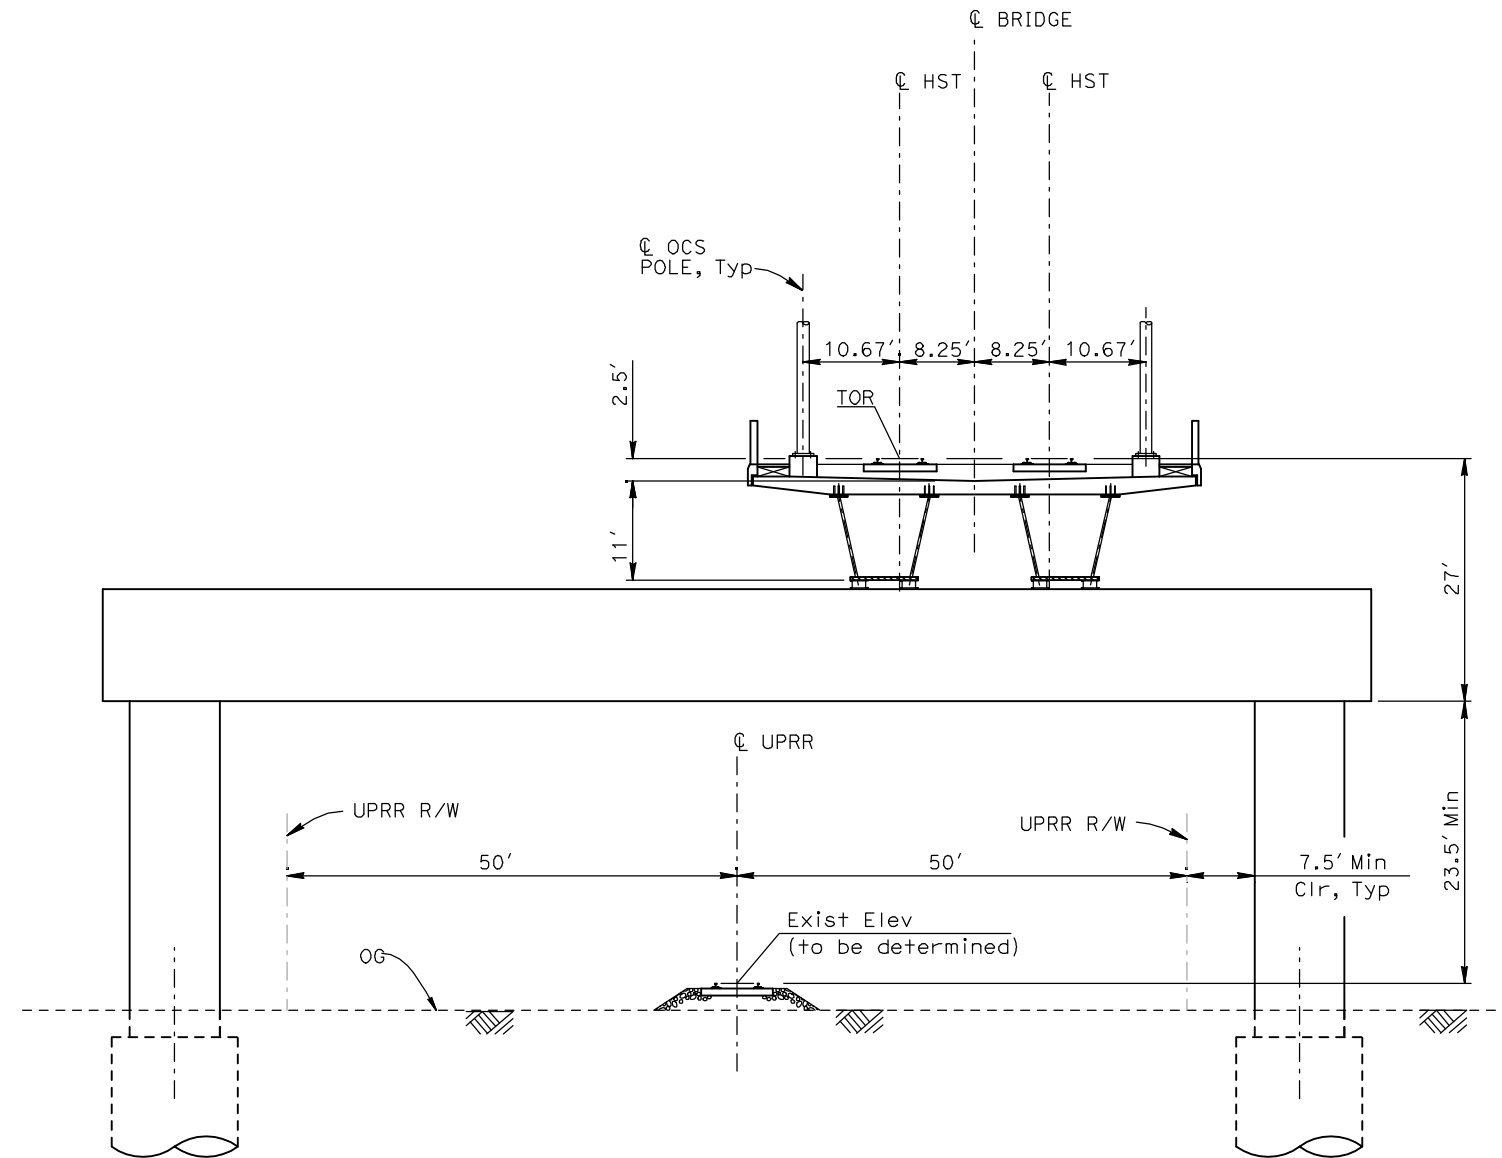


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ShieldsA



**EL4 - DOUBLE TRACK ELEVATED CROSSING SR99**



**EL5 - DOUBLE TRACK ELEVATED CROSSING UPRR/BNSF**

- NOTES:
1. TRACK, OCS POLES AND FOUNDATIONS, CABLE DUCTS AND DRAINAGE ARE SCHEMATIC AND DO NOT REPRESENT DESIGN.
  2. RIGHT-OF-WAY REQUIRED FOR THE HIGH-SPEED RAIL GUIDEWAY WILL DEPEND UPON CONDITIONS ALONG THE ALIGNMENT, INCLUDING TERRAIN, WHERE CUT/FILL SLOPES, RETAINING STRUCTURES, AND ACCESS ARE REQUIRED.
  3. POTENTIAL SOUND BARRIERS NOT SHOWN IN CROSS SECTIONS. FOR THE EXTENT OF POTENTIAL SOUND BARRIERS, SEE ALIGNMENT PLAN AND PROFILE SHEETS.

REV	DATE	BY	CHK	APP	DESCRIPTION

DESIGNED BY A. SHIELDS
DRAWN BY C. VALADAO
CHECKED BY A. BOONE
IN CHARGE A. BOONE
DATE 07/20/2011

**RECORD SET  
15% DESIGN  
SUBMITTAL**

**NOT FOR  
CONSTRUCTION**



**CALIFORNIA  
HIGH-SPEED RAIL AUTHORITY**

**CALIFORNIA HIGH-SPEED TRAIN PROJECT  
MERCED TO FRESNO**

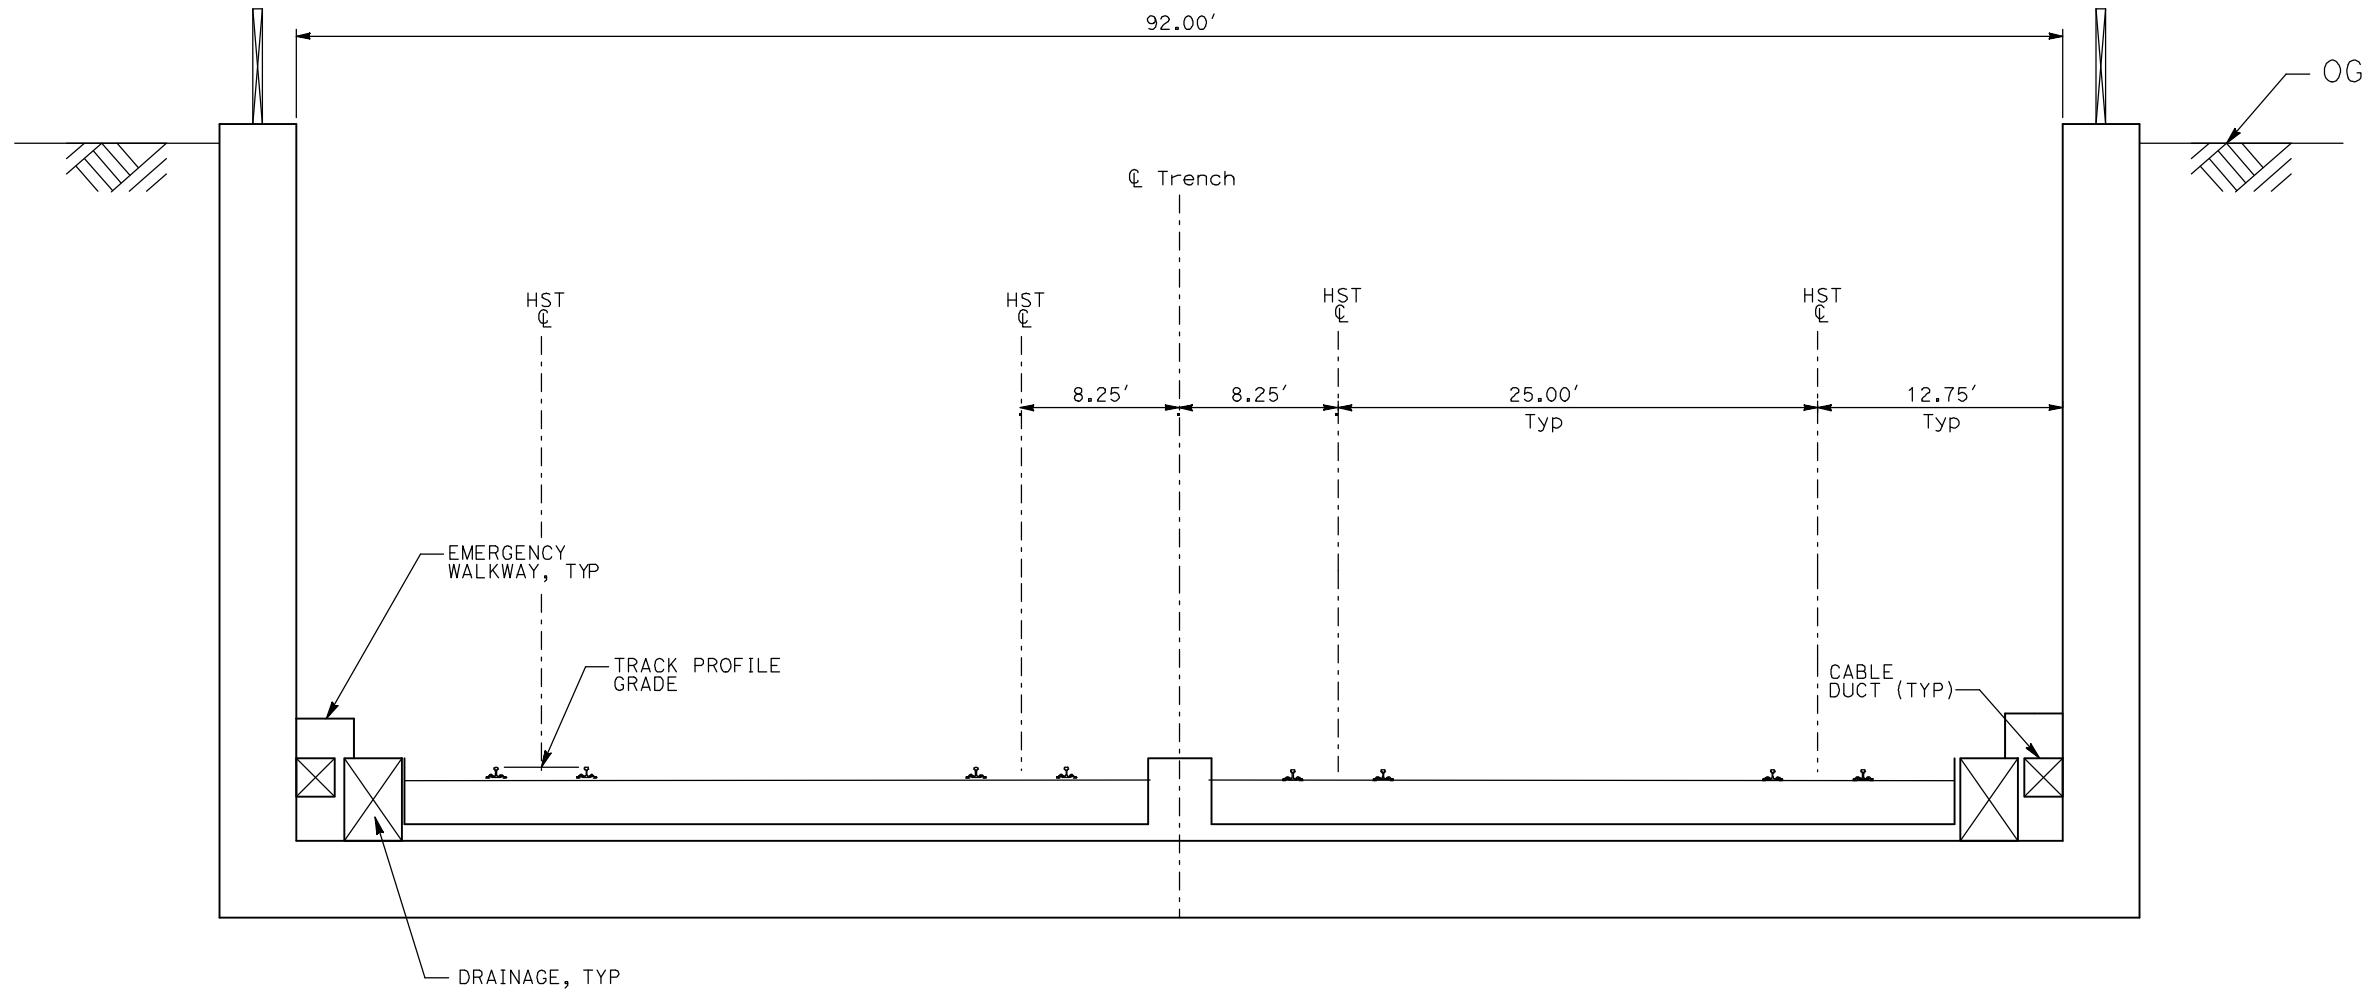
TYPICAL SECTIONS  
SHEET 6 OF 17

CONTRACT NO. HSR06-007
DRAWING NO. T3006-A
SCALE NO SCALE
SHEET NO. OF ###



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ShieldsA



TR1 - 4 TRACK TRENCH STATION APPROACH

- NOTES:
1. TRACK, OCS POLES AND FOUNDATIONS, CABLE DUCTS AND DRAINAGE ARE SCHEMATIC AND DO NOT REPRESENT DESIGN.
  2. RIGHT-OF-WAY REQUIRED FOR THE HIGH-SPEED RAIL GUIDEWAY WILL DEPEND UPON CONDITIONS ALONG THE ALIGNMENT, INCLUDING TERRAIN, WHERE CUT/FILL SLOPES, RETAINING STRUCTURES, AND ACCESS ARE REQUIRED.
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REV	DATE	BY	CHK	APP	DESCRIPTION

DESIGNED BY  
A. SHIELDS  
DRAWN BY  
C. VALADAO  
CHECKED BY  
A. BOONE  
IN CHARGE  
A. BOONE  
DATE  
07/20/2011

RECORD SET  
15% DESIGN  
SUBMITTAL

NOT FOR  
CONSTRUCTION

**AECOM**  
Technical Services, Inc.  
2020 L Street, Suite 300  
Sacramento, CA 95811  
**CH2MHILL**



**CALIFORNIA HIGH-SPEED TRAIN PROJECT  
MERCED TO FRESNO**

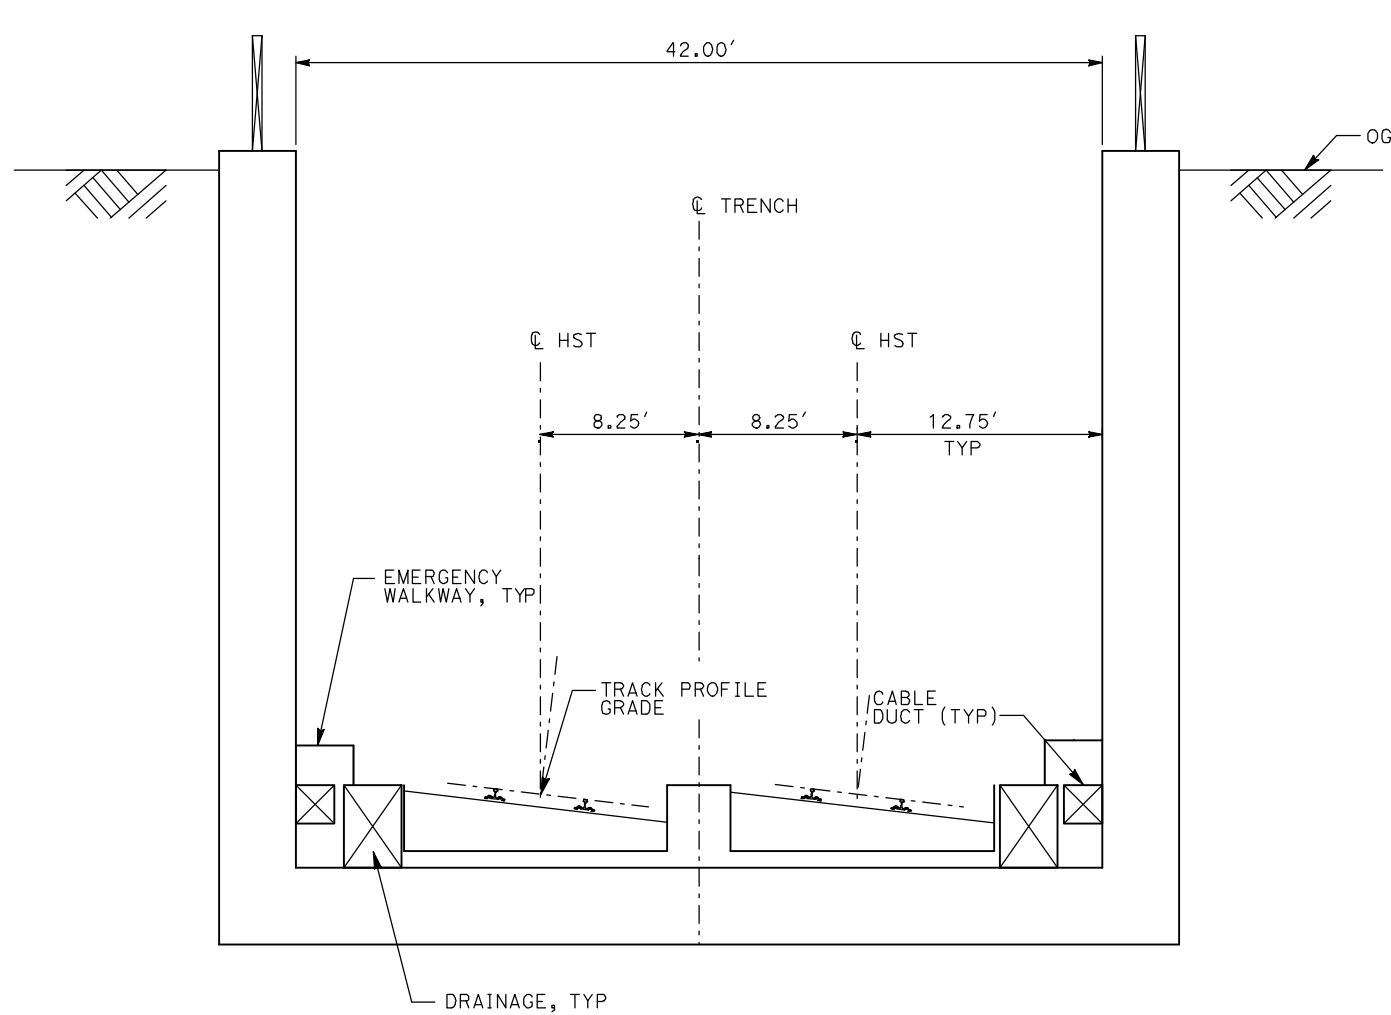
TYPICAL SECTIONS  
SHEET 7 OF 17

CONTRACT NO.  
HSR06-007  
DRAWING NO.  
T3007-A  
SCALE  
NO SCALE  
SHEET NO.  
OF ###

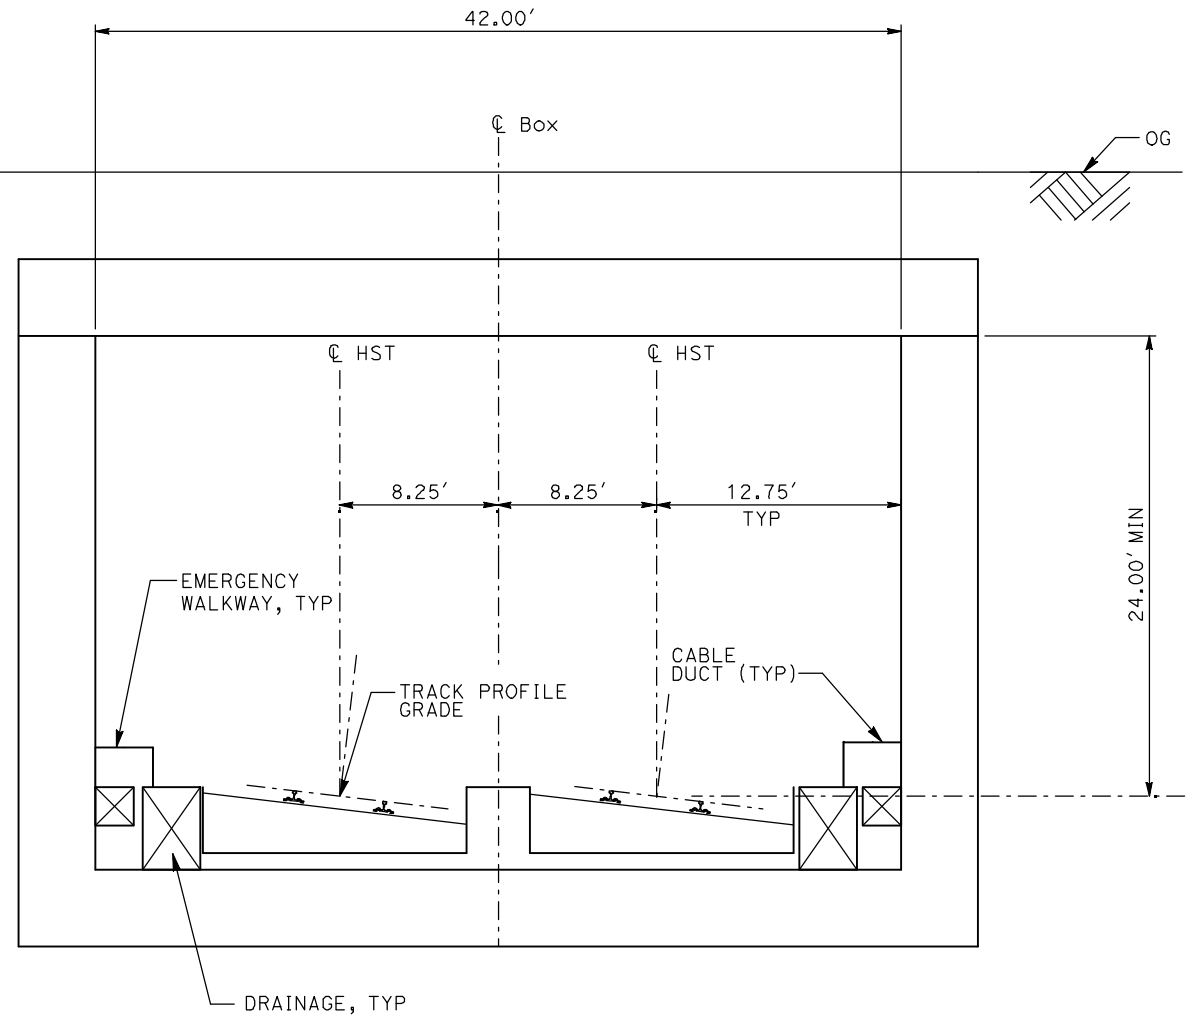


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ShieldsA



TR2 - 2 TRACK TRENCH



CC1 - 2 TRACK CUT AND COVER CLOSED BOX

- NOTES:
1. TRACK, OCS POLES AND FOUNDATIONS, CABLE DUCTS AND DRAINAGE ARE SCHEMATIC AND DO NOT REPRESENT DESIGN.
  2. RIGHT-OF-WAY REQUIRED FOR THE HIGH-SPEED RAIL GUIDEWAY WILL DEPEND UPON CONDITIONS ALONG THE ALIGNMENT, INCLUDING TERRAIN, WHERE CUT/FILL SLOPES, RETAINING STRUCTURES, AND ACCESS ARE REQUIRED.
  3. POTENTIAL SOUND BARRIERS NOT SHOWN IN CROSS SECTIONS. FOR THE EXTENT OF POTENTIAL SOUND BARRIERS, SEE ALIGNMENT PLAN AND PROFILE SHEETS.

REV	DATE	BY	CHK	APP	DESCRIPTION

DESIGNED BY A. SHIELDS
DRAWN BY C. VALADAO
CHECKED BY A. BOONE
IN CHARGE A. BOONE
DATE 07/20/2011

**RECORD SET**  
**15% DESIGN**  
**SUBMITTAL**

**NOT FOR**  
**CONSTRUCTION**

**AECOM**  
Technical Services, Inc.  
2020 L Street, Suite 300  
Sacramento, CA 95811

**CH2M HILL**



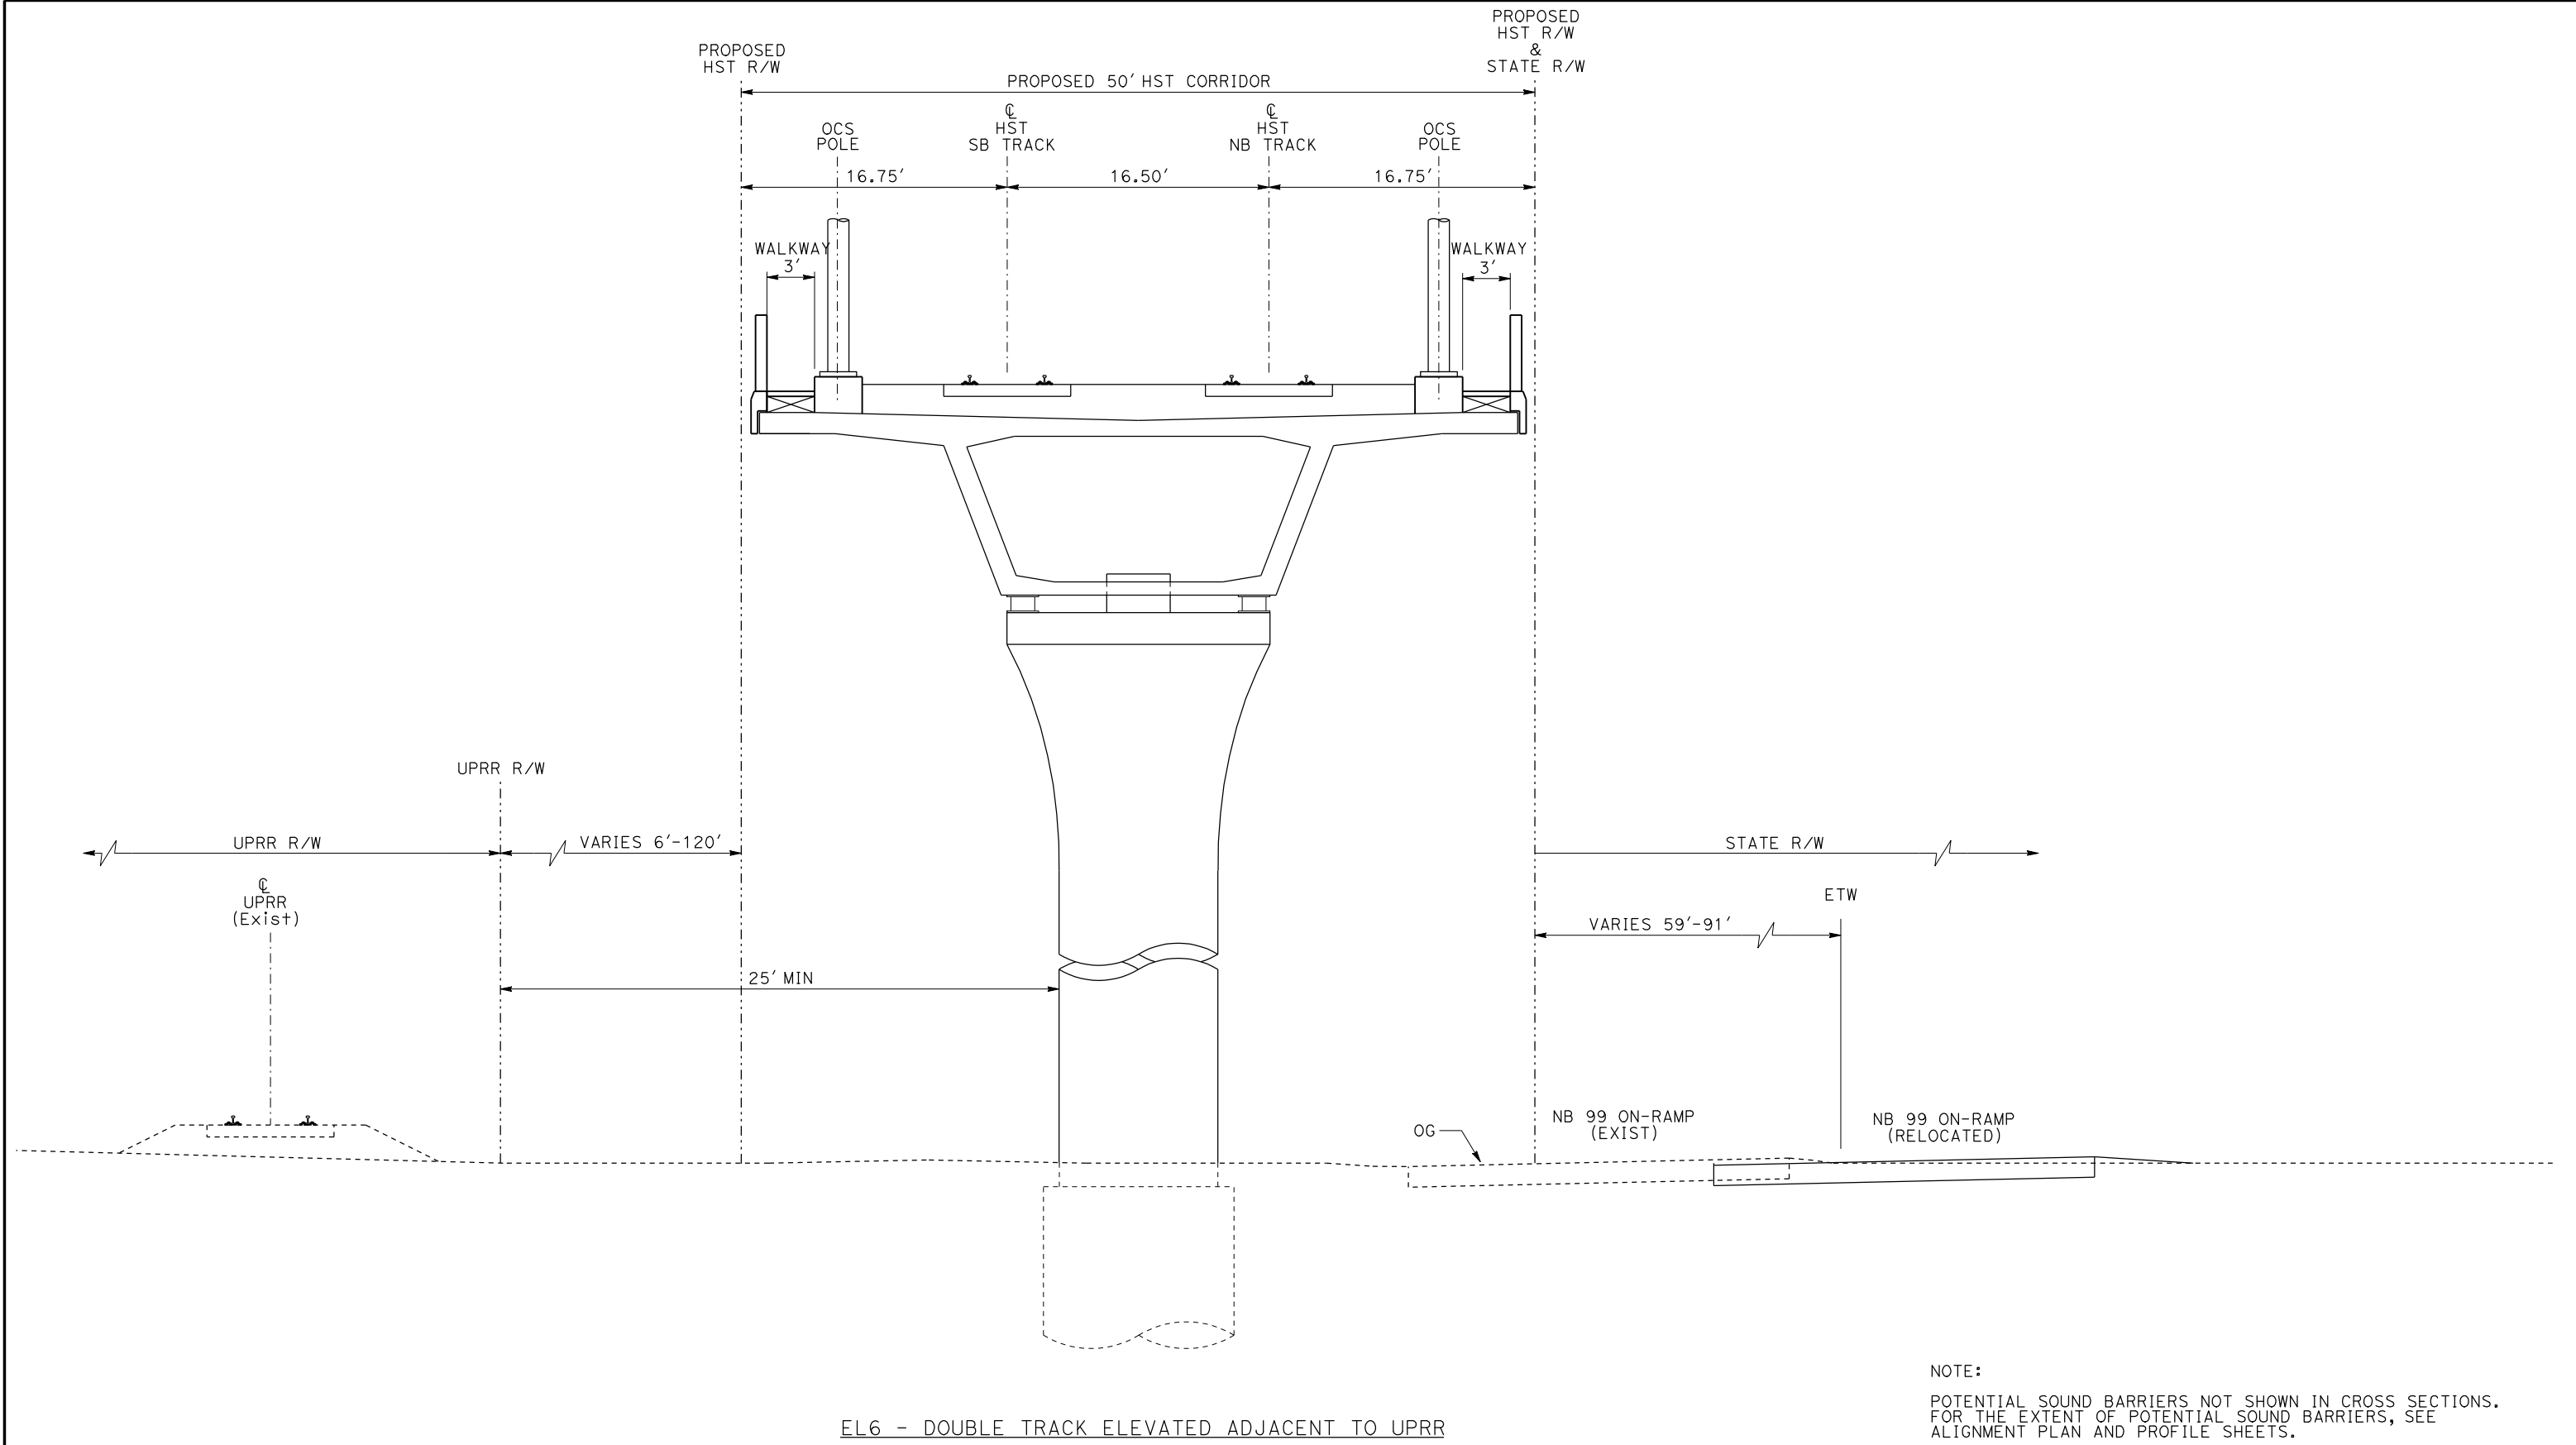
**CALIFORNIA**  
HIGH-SPEED RAIL AUTHORITY

**CALIFORNIA HIGH-SPEED TRAIN PROJECT**  
**MERCED TO FRESNO**

TYPICAL SECTIONS  
SHEET 8 OF 17

CONTRACT NO. HSR06-007
DRAWING NO. T3008-A
SCALE NO SCALE
SHEET NO. OF ###





EL6 - DOUBLE TRACK ELEVATED ADJACENT TO UPRR

NOTE:  
POTENTIAL SOUND BARRIERS NOT SHOWN IN CROSS SECTIONS.  
FOR THE EXTENT OF POTENTIAL SOUND BARRIERS, SEE  
ALIGNMENT PLAN AND PROFILE SHEETS.

REV	DATE	BY	CHK	APP	DESCRIPTION

DESIGNED BY L. PROCTOR
DRAWN BY S. LEONG
CHECKED BY V. CHIO
IN CHARGE J. VALSECCHI
DATE JULY 2011

RECORD SET  
15% DESIGN  
SUBMITTAL  
  
NOT FOR  
CONSTRUCTION

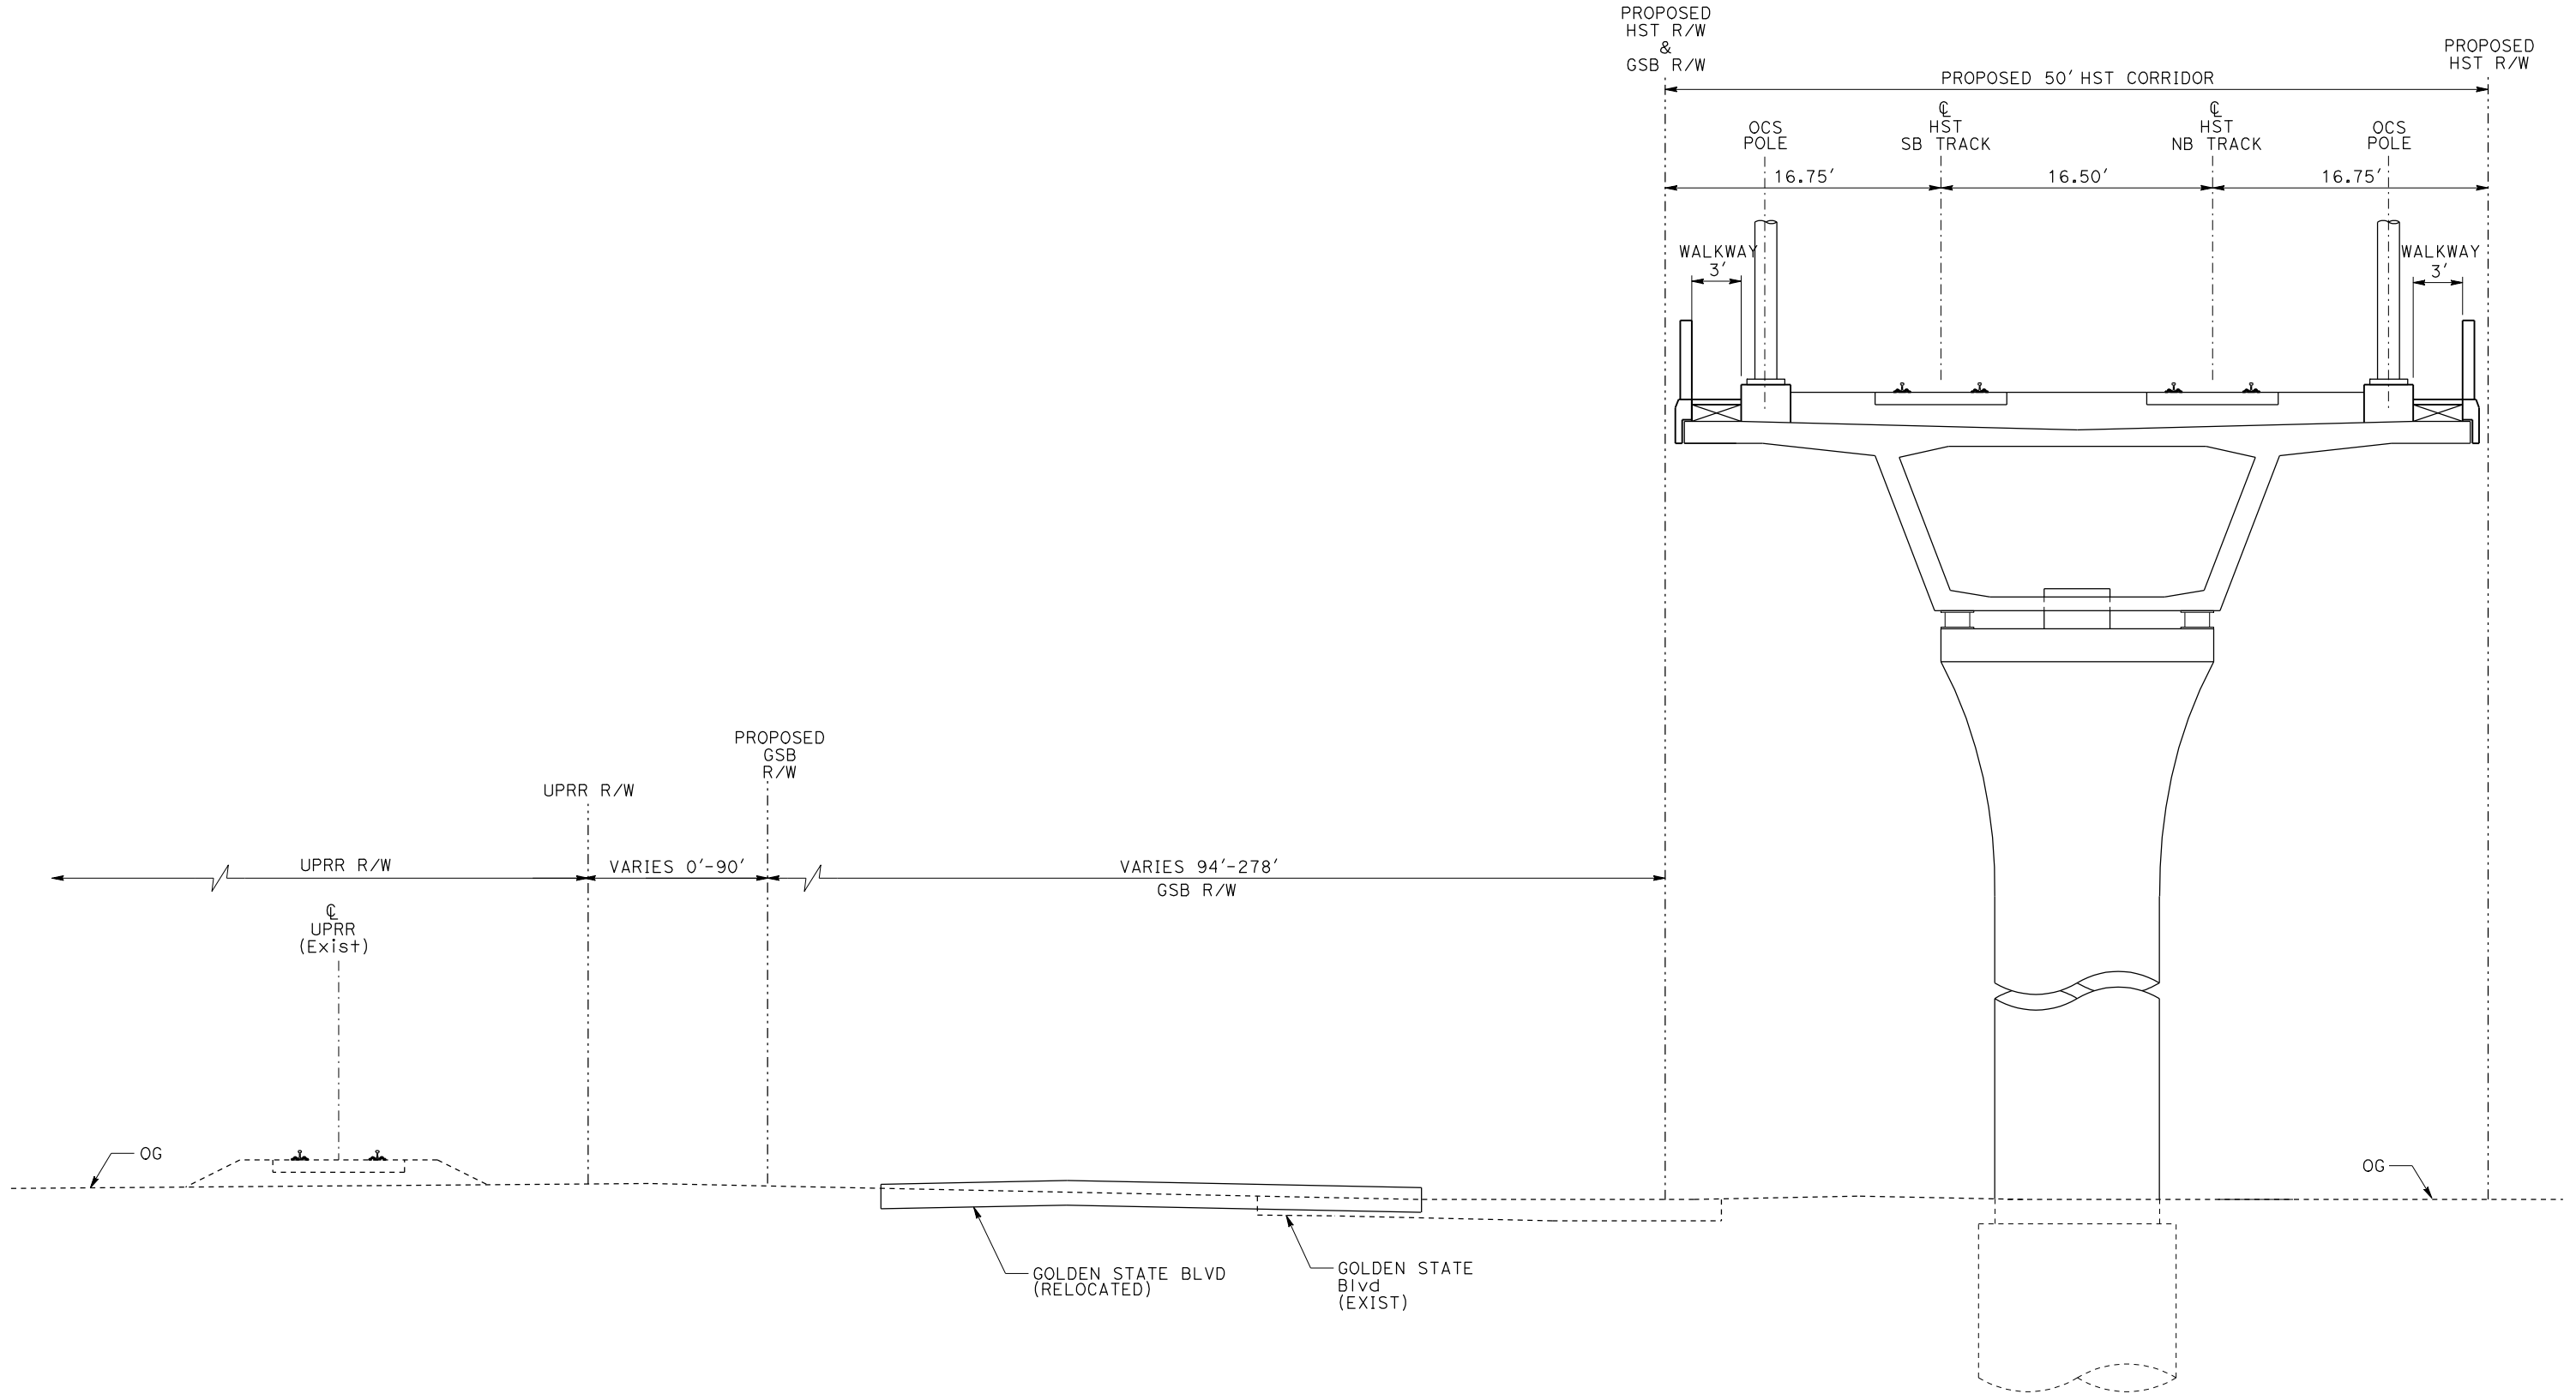


CALIFORNIA HIGH-SPEED TRAIN PROJECT  
MERCED TO FRESNO

TYPICAL SECTIONS  
SHEET 9 OF 17

CONTRACT NO. HSR06-007
DRAWING NO. T3009-A
SCALE NO SCALE
SHEET NO.





EL7 - DOUBLE TRACK ELEVATED ADJACENT TO GOLDEN STATE BOULEVARD

NOTE:  
POTENTIAL SOUND BARRIERS NOT SHOWN IN CROSS SECTIONS.  
FOR THE EXTENT OF POTENTIAL SOUND BARRIERS, SEE  
ALIGNMENT PLAN AND PROFILE SHEETS.

REV	DATE	BY	CHK	APP	DESCRIPTION

DESIGNED BY L. PROCTOR
DRAWN BY S. LEONG
CHECKED BY V. CHIO
IN CHARGE J. VALSECCHI
DATE JULY 2011

RECORD SET  
15% DESIGN  
SUBMITTAL

NOT FOR  
CONSTRUCTION

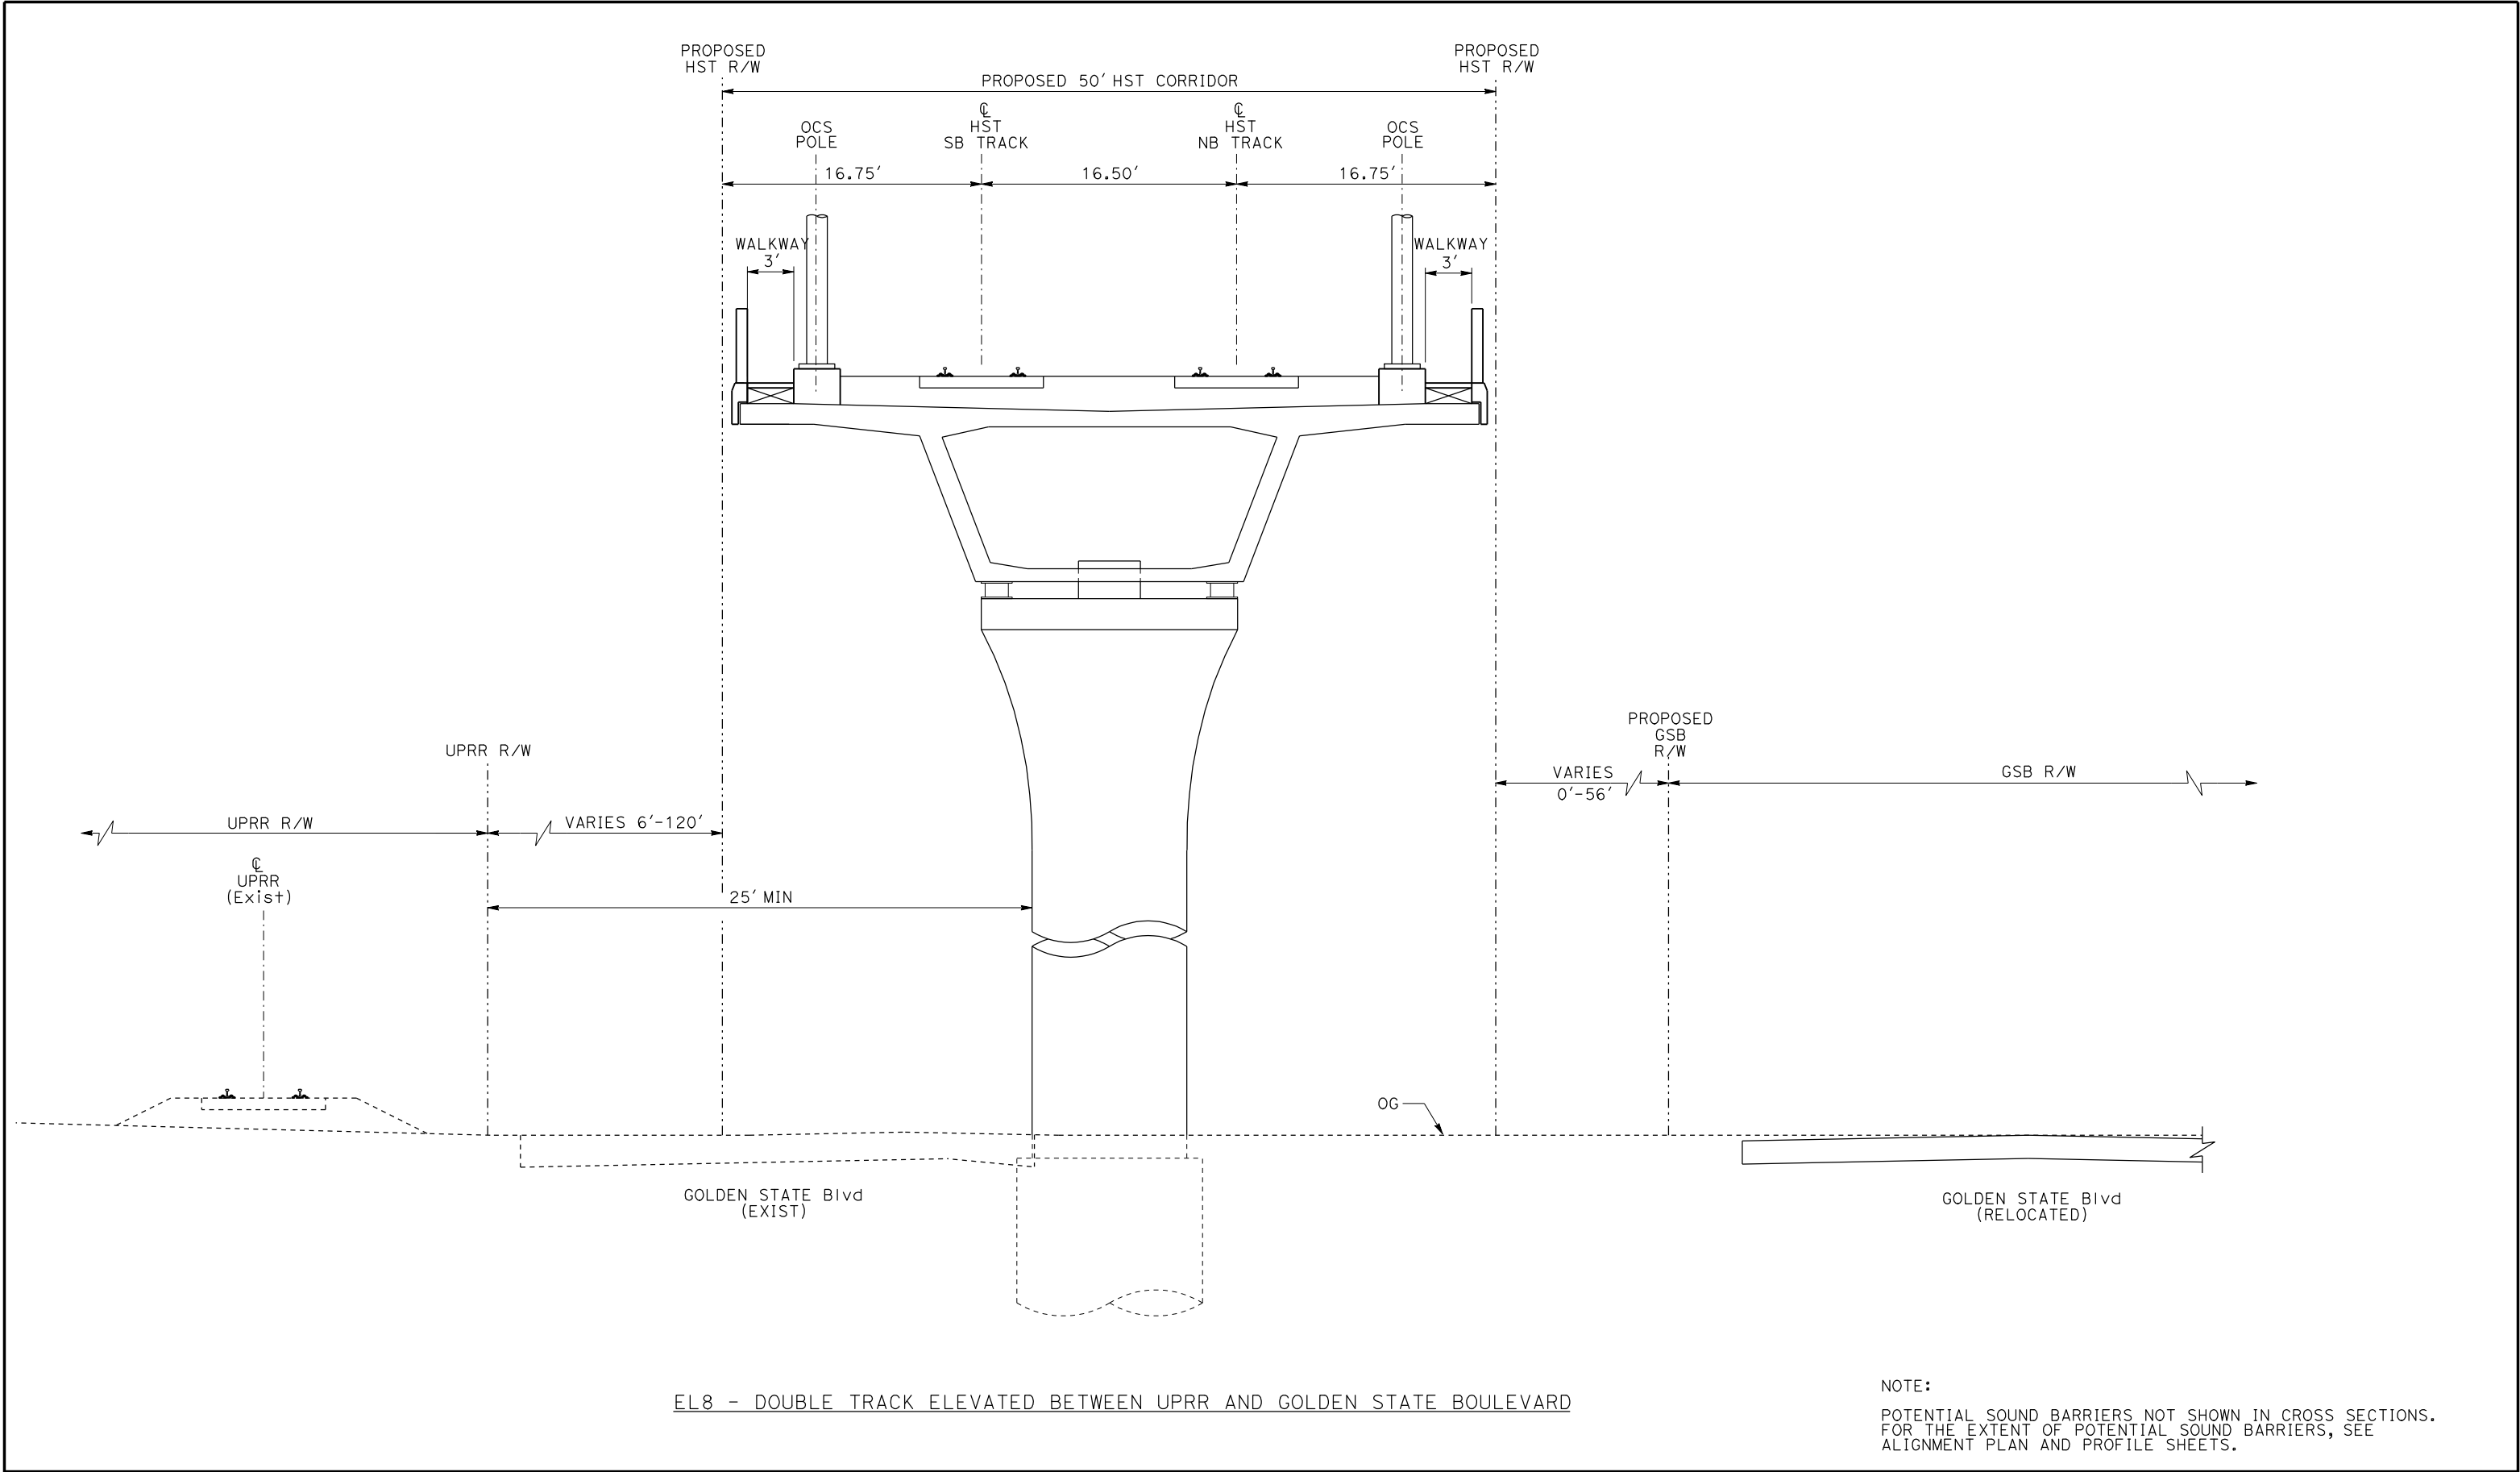



CALIFORNIA HIGH-SPEED TRAIN PROJECT  
MERCED TO FRESNO

TYPICAL SECTIONS  
SHEET 10 OF 17

CONTRACT NO. HSR06-007
DRAWING NO. T3010-A
SCALE NO SCALE
SHEET NO.





					DESIGNED BY L. PROCTOR	<b>RECORD SET 15% DESIGN SUBMITTAL</b>	<b>AECOM</b> Technical Services, Inc. 2020 L Street, Suite 300 Sacramento, CA 95811		<b>CALIFORNIA HIGH-SPEED TRAIN PROJECT MERCED TO FRESNO</b>	CONTRACT NO. HSR06-007
					DRAWN BY S. LEONG					DRAWING NO. T3011-A
					CHECKED BY V. CHIO					SCALE NO SCALE
					IN CHARGE J. VALSECCHI					SHEET NO.
REV	DATE	BY	CHK	APP	DESCRIPTION	DATE JULY 2011	<b>NOT FOR CONSTRUCTION</b>	<b>CH2MHILL</b>		

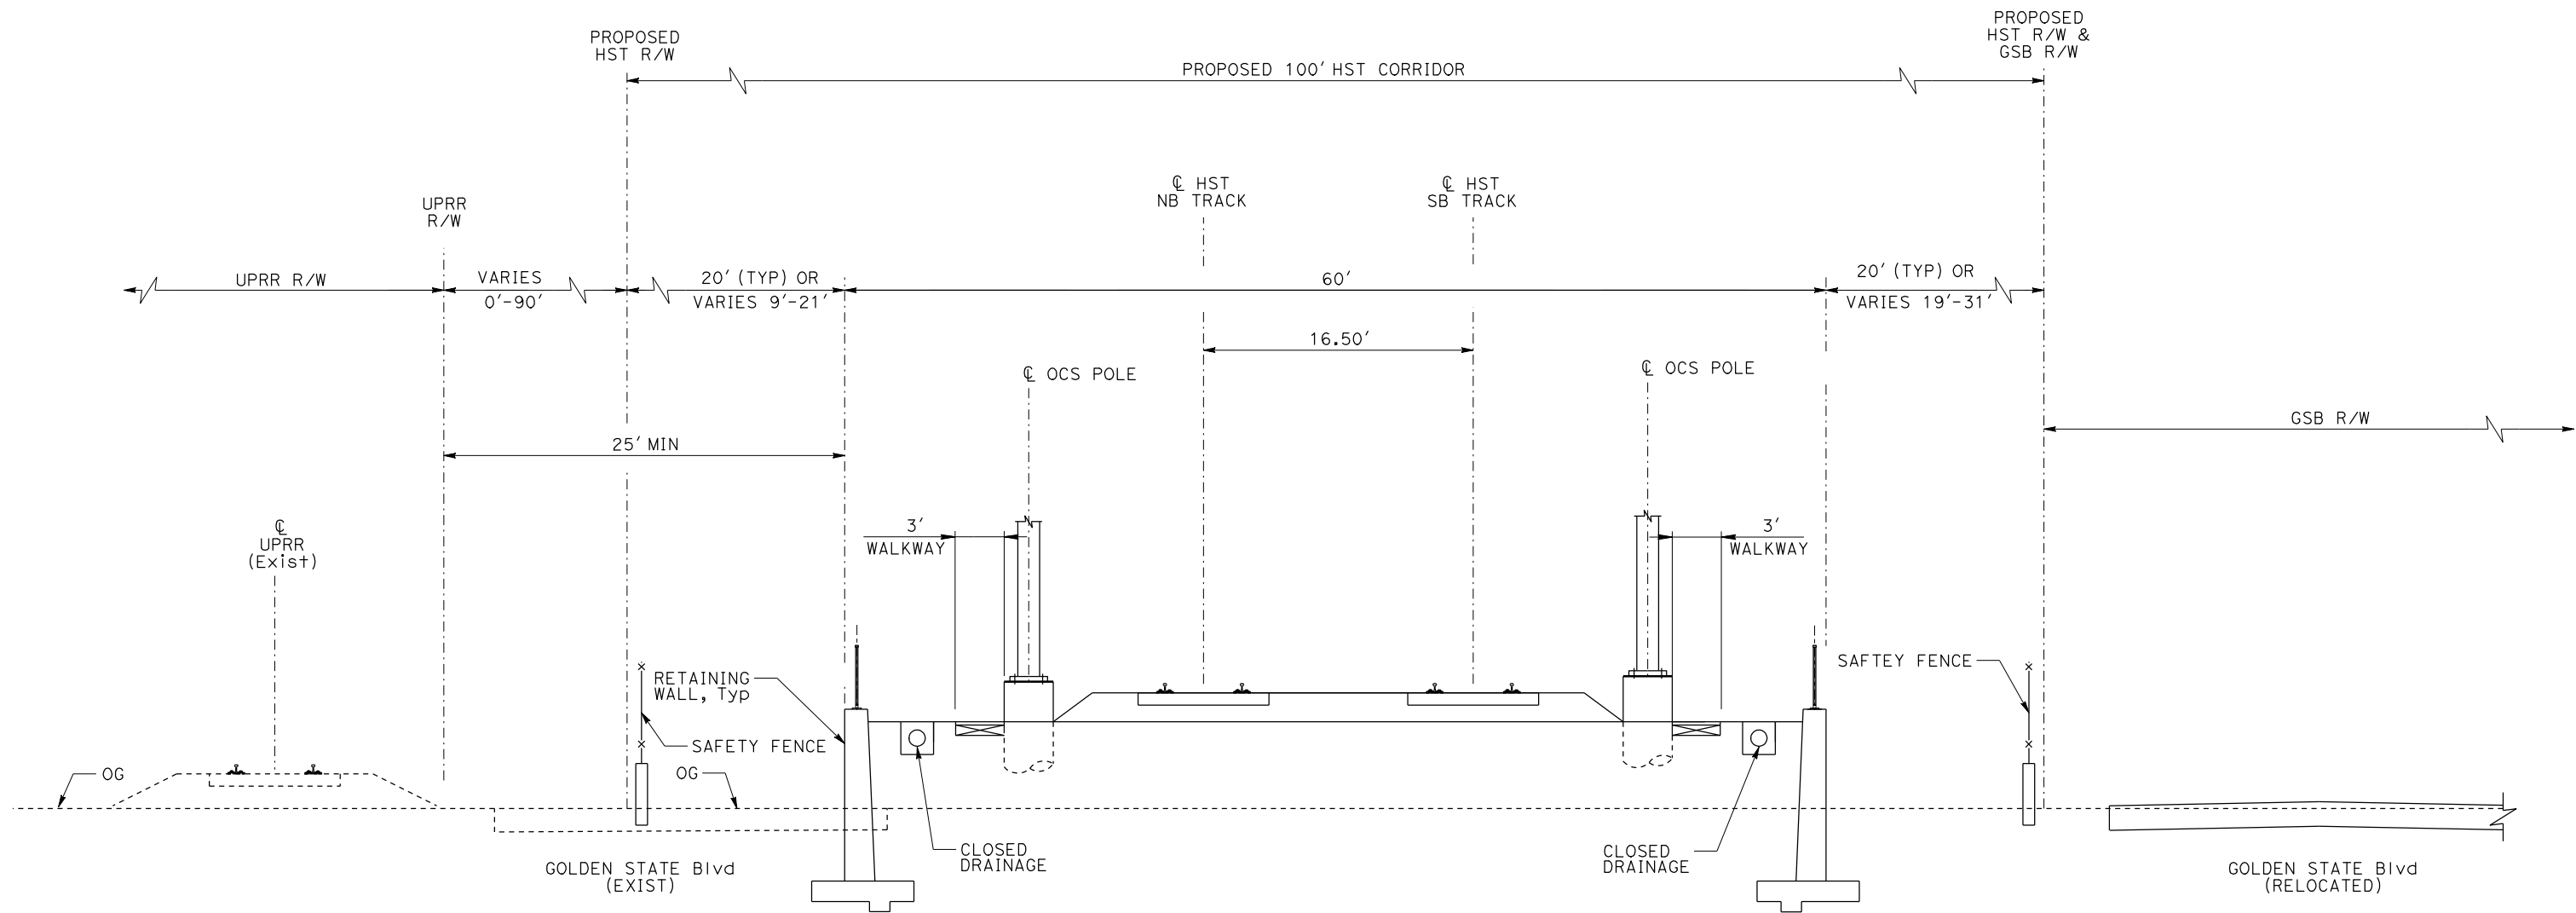
NOTE:  
POTENTIAL SOUND BARRIERS NOT SHOWN IN CROSS SECTIONS.  
FOR THE EXTENT OF POTENTIAL SOUND BARRIERS, SEE  
ALIGNMENT PLAN AND PROFILE SHEETS.

TYPICAL SECTIONS  
SHEET 11 OF 17

USERNAME => lwebster  
DGN FILE => MF-T-3011-A1-E1R.dgn

DATE PLOTTED => 21-JUL-2011  
TIME PLOTTED => 12:45





RF3 - DOUBLE TRACK BETWEEN UPRR AND GOLDEN STATE BOULEVARD

NOTE:  
POTENTIAL SOUND BARRIERS NOT SHOWN IN CROSS SECTIONS.  
FOR THE EXTENT OF POTENTIAL SOUND BARRIERS, SEE  
ALIGNMENT PLAN AND PROFILE SHEETS.

REV	DATE	BY	CHK	APP	DESCRIPTION

DESIGNED BY L. PROCTOR
DRAWN BY S. LEONG
CHECKED BY V. CHIO
IN CHARGE J. VALSECCHI
DATE JULY 2011

RECORD SET  
15% DESIGN  
SUBMITTAL  
  
NOT FOR  
CONSTRUCTION



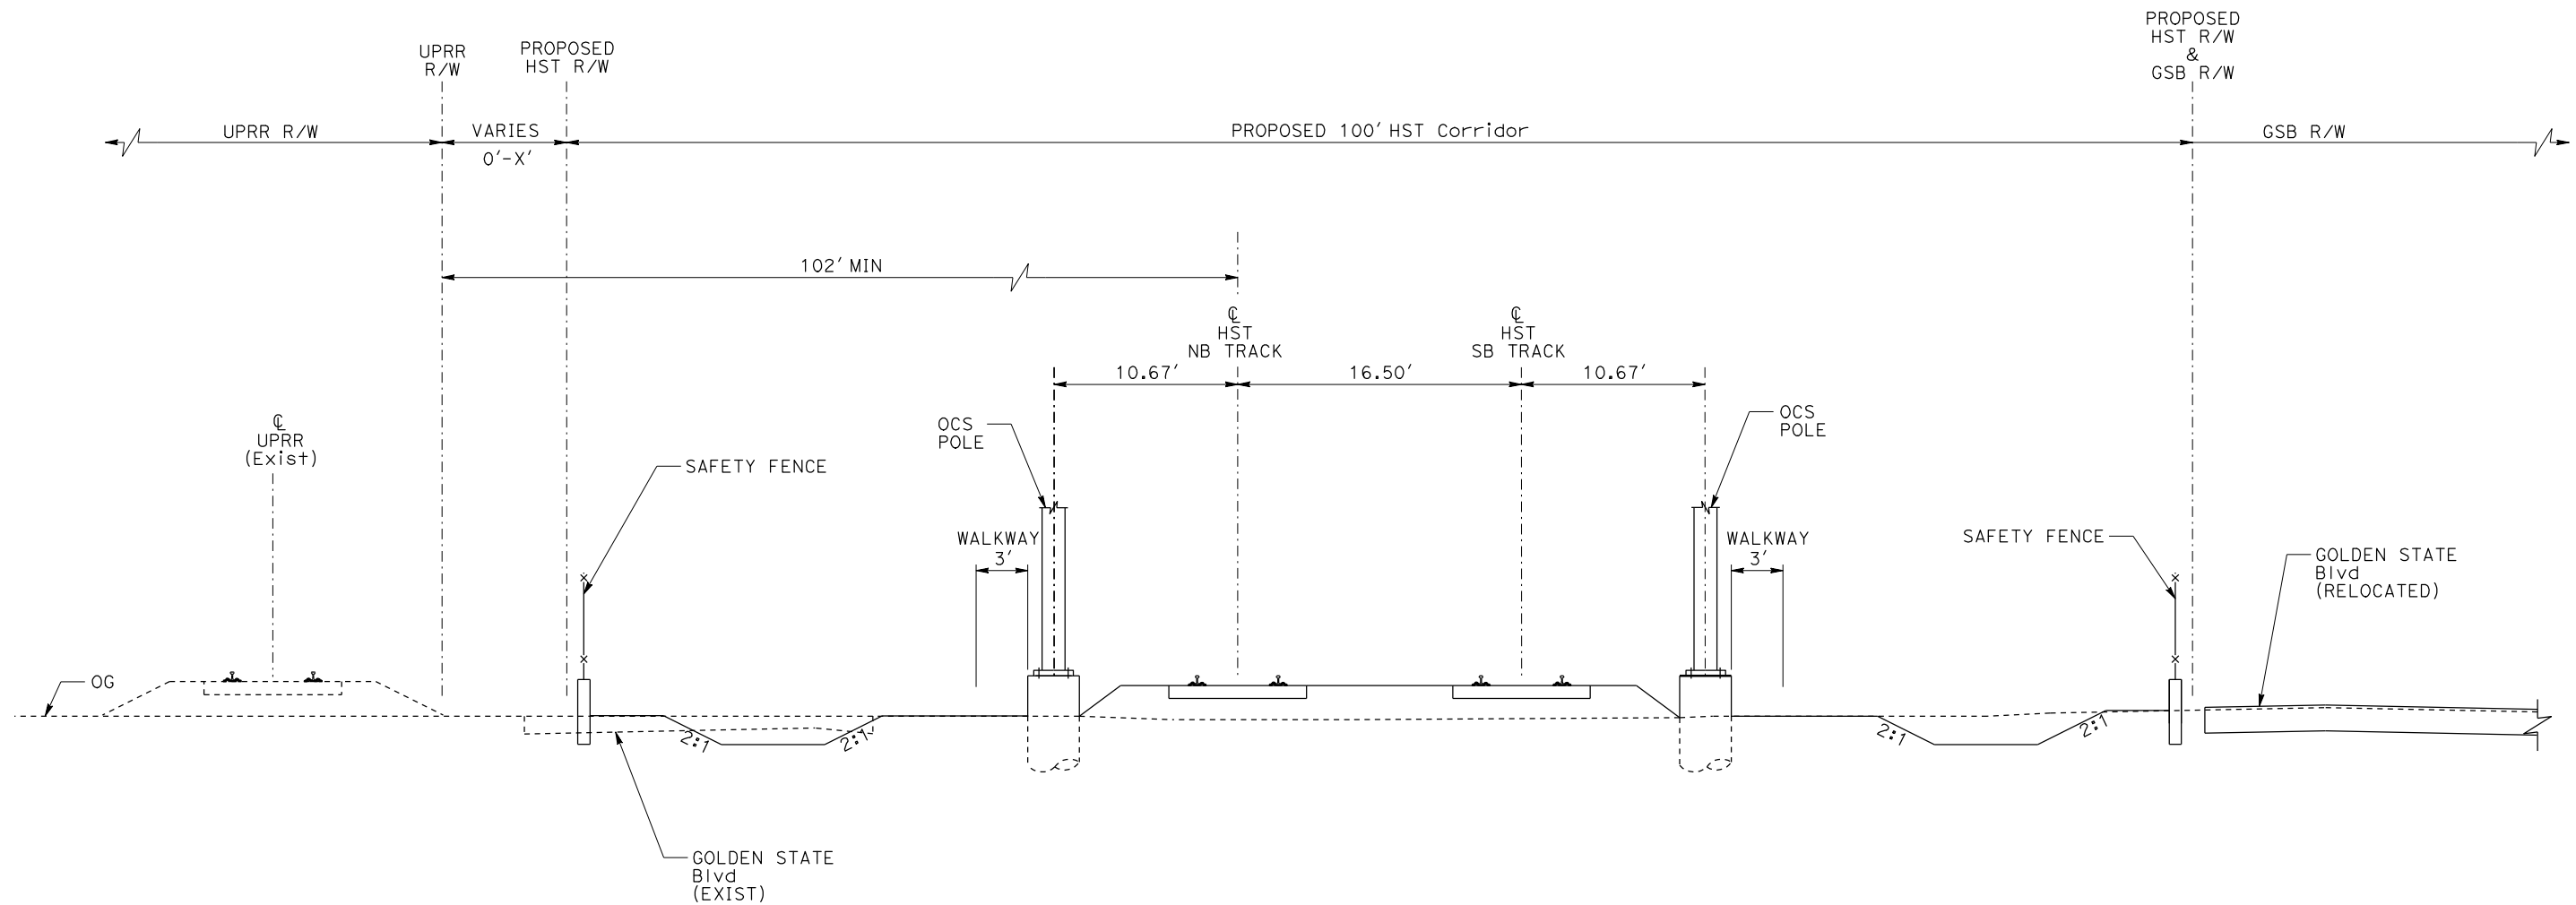
CALIFORNIA  
HIGH-SPEED RAIL AUTHORITY

CALIFORNIA HIGH-SPEED TRAIN PROJECT  
MERCED TO FRESNO

TYPICAL SECTION  
SHEET 12 OF 17

CONTRACT NO. HSR06-007
DRAWING NO. T3012-A
SCALE NO SCALE
SHEET NO.





AG6 - DOUBLE TRACK BETWEEN UPRR AND GOLDEN STATE BOULEVARD

NOTE:

POTENTIAL SOUND BARRIERS NOT SHOWN IN CROSS SECTIONS.  
FOR THE EXTENT OF POTENTIAL SOUND BARRIERS, SEE  
ALIGNMENT PLAN AND PROFILE SHEETS.

REV	DATE	BY	CHK	APP	DESCRIPTION

DESIGNED BY L. PROCTOR
DRAWN BY S. LEONG
CHECKED BY V. CHIO
IN CHARGE J. VALSECCHI
DATE JULY 2011

**RECORD SET**  
**15% DESIGN**  
**SUBMITTAL**

**NOT FOR**  
**CONSTRUCTION**



**CALIFORNIA HIGH-SPEED TRAIN PROJECT**  
**MERCED TO FRESNO**

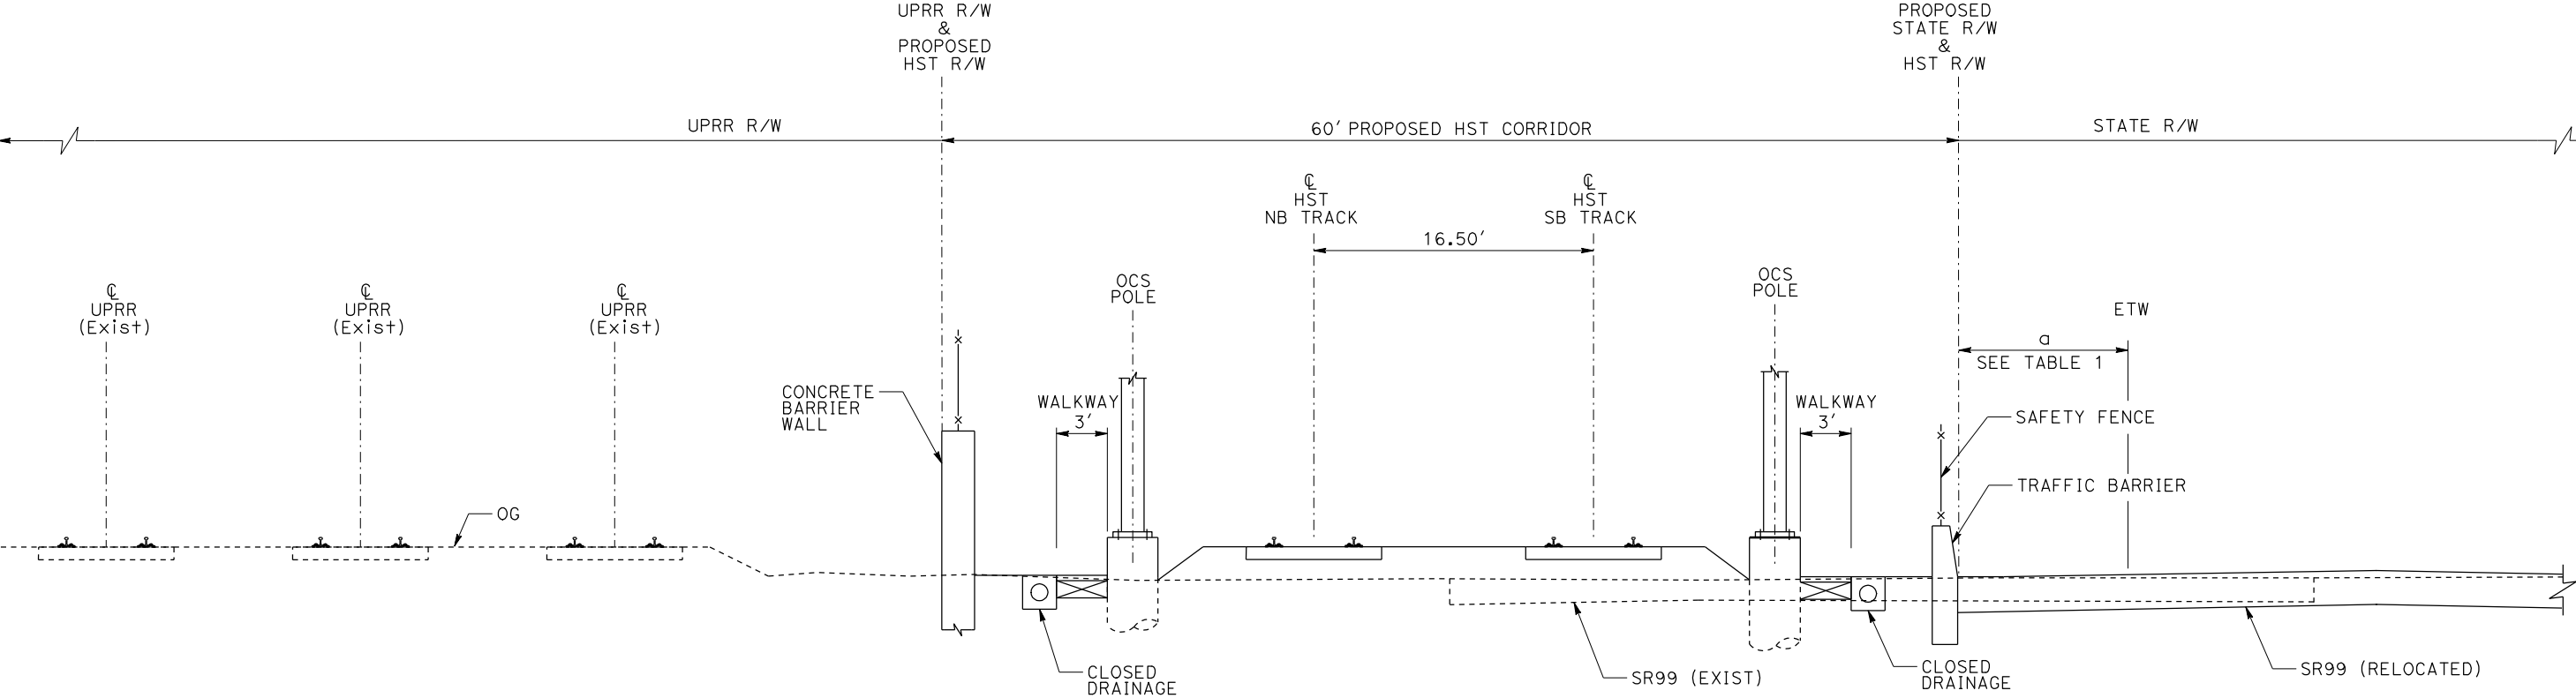
TYPICAL SECTION  
SHEET 13 OF 17

CONTRACT NO. HSR06-007
DRAWING NO. T3013-A
SCALE NO SCALE
SHEET NO.




TABLE 1

a > 30'	NO TRAFFIC BARRIER
4' < a < 30'	TRAFFIC BARRIER



AG7 - DOUBLE TRACK BETWEEN UPRR AND STATE ROUTE 99

NOTE:  
POTENTIAL SOUND BARRIERS NOT SHOWN IN CROSS SECTIONS.  
FOR THE EXTENT OF POTENTIAL SOUND BARRIERS, SEE  
ALIGNMENT PLAN AND PROFILE SHEETS.

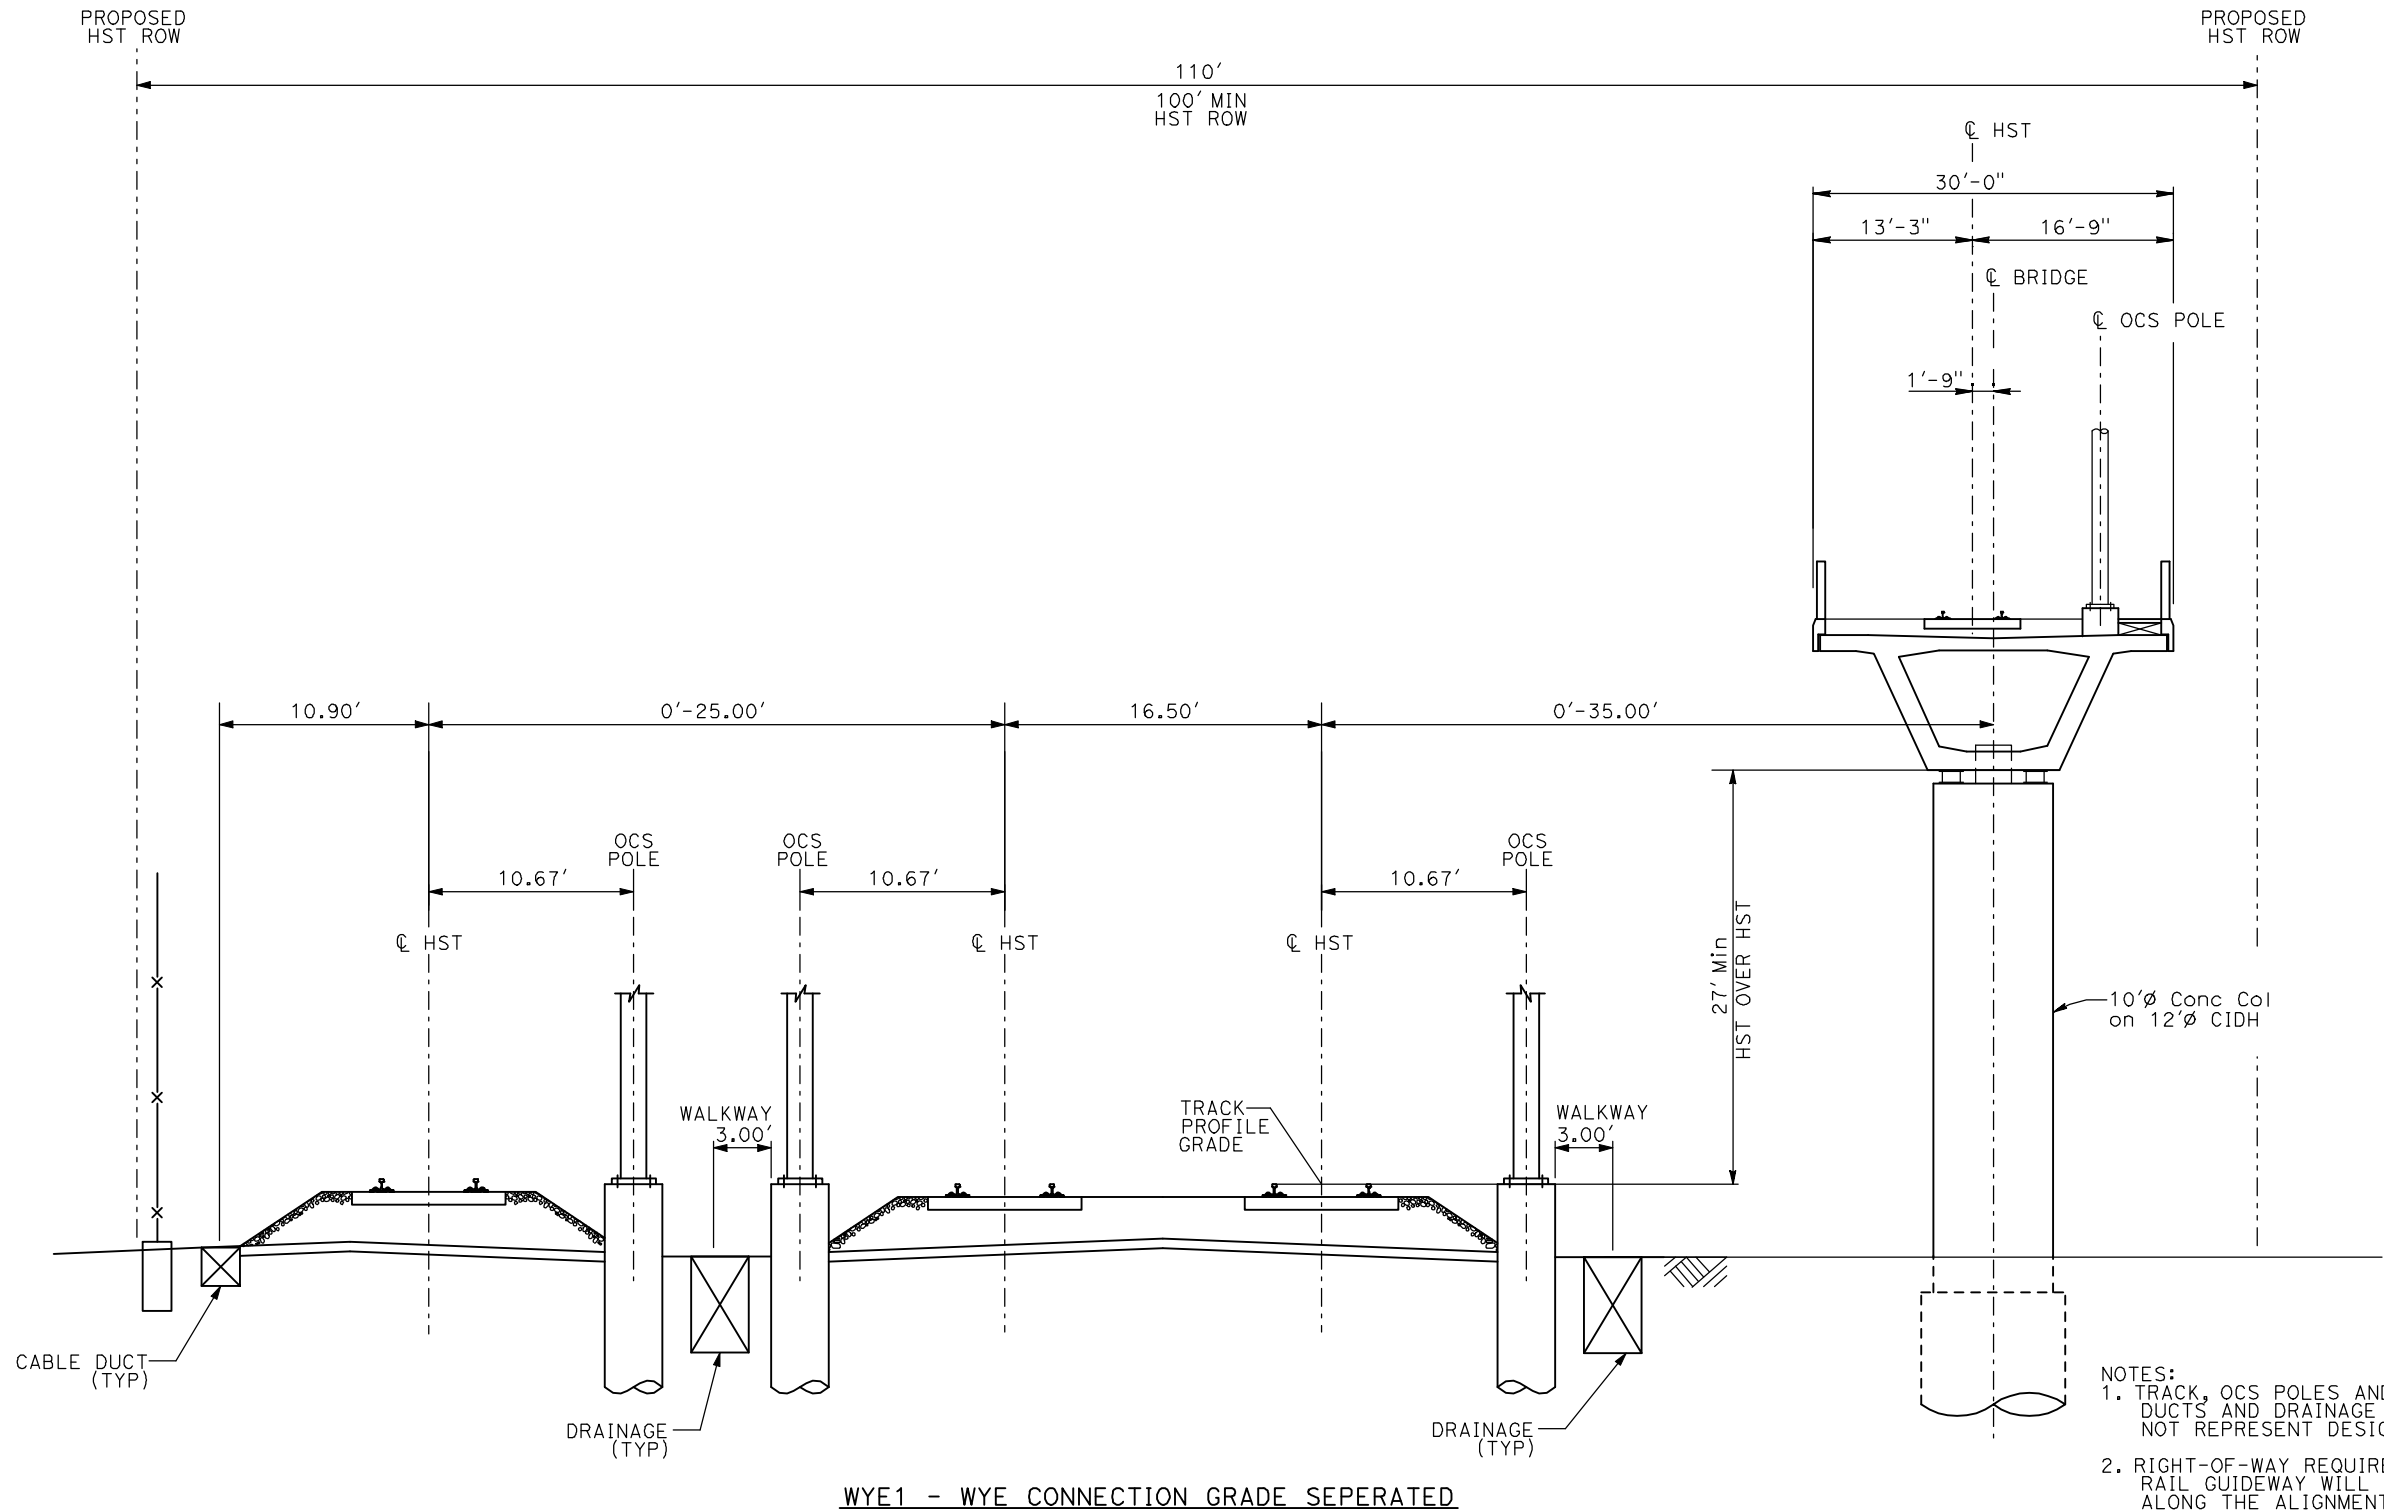
					DESIGNED BY L. PROCTOR	<b>RECORD SET 15% DESIGN SUBMITTAL</b>	<b>AECOM</b> Technical Services, Inc. 2020 L Street, Suite 300 Sacramento, CA 95811		<b>CALIFORNIA HIGH-SPEED TRAIN PROJECT MERCED TO FRESNO</b>	CONTRACT NO. HSR06-007
					DRAWN BY S. LEONG					DRAWING NO. T3014-A
					CHECKED BY V. CHIO					SCALE NO SCALE
					IN CHARGE J. VALSECCHI					SHEET NO.
REV	DATE	BY	CHK	APP	DESCRIPTION	DATE JULY 2011				USERNAME => lwebster DGN FILE => MF-T-3014-A1-E1R.dgn

DATE PLOTTED => 21-JUL-2011  
TIME PLOTTED => 12:56



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ShieldsA



- NOTES:
1. TRACK, OCS POLES AND FOUNDATIONS, CABLE DUCTS AND DRAINAGE ARE SCHEMATIC AND DO NOT REPRESENT DESIGN.
  2. RIGHT-OF-WAY REQUIRED FOR THE HIGH-SPEED RAIL GUIDEWAY WILL DEPEND UPON CONDITIONS ALONG THE ALIGNMENT, INCLUDING TERRAIN, WHERE CUT/FILL SLOPES, RETAINING STRUCTURES, AND ACCESS ARE REQUIRED.
  3. POTENTIAL SOUND BARRIERS NOT SHOWN IN CROSS SECTIONS. FOR THE EXTENT OF POTENTIAL SOUND BARRIERS, SEE ALIGNMENT PLAN AND PROFILE SHEETS.

REV	DATE	BY	CHK	APP	DESCRIPTION

DESIGNED BY  
A. SHIELDS  
DRAWN BY  
C. VALADAO  
CHECKED BY  
A. BOONE  
IN CHARGE  
A. BOONE  
DATE  
07/20/2011

**RECORD SET**  
**15% DESIGN**  
**SUBMITTAL**

**NOT FOR**  
**CONSTRUCTION**

**AECOM**  
Technical Services, Inc.  
2020 L Street, Suite 300  
Sacramento, CA 95811

**CH2M HILL**



**CALIFORNIA HIGH-SPEED TRAIN PROJECT**  
**MERCED TO FRESNO**

TYPICAL SECTIONS  
SHEET 15 OF 17

CONTRACT NO.  
HSR06-007

DRAWING NO.  
T3015-A

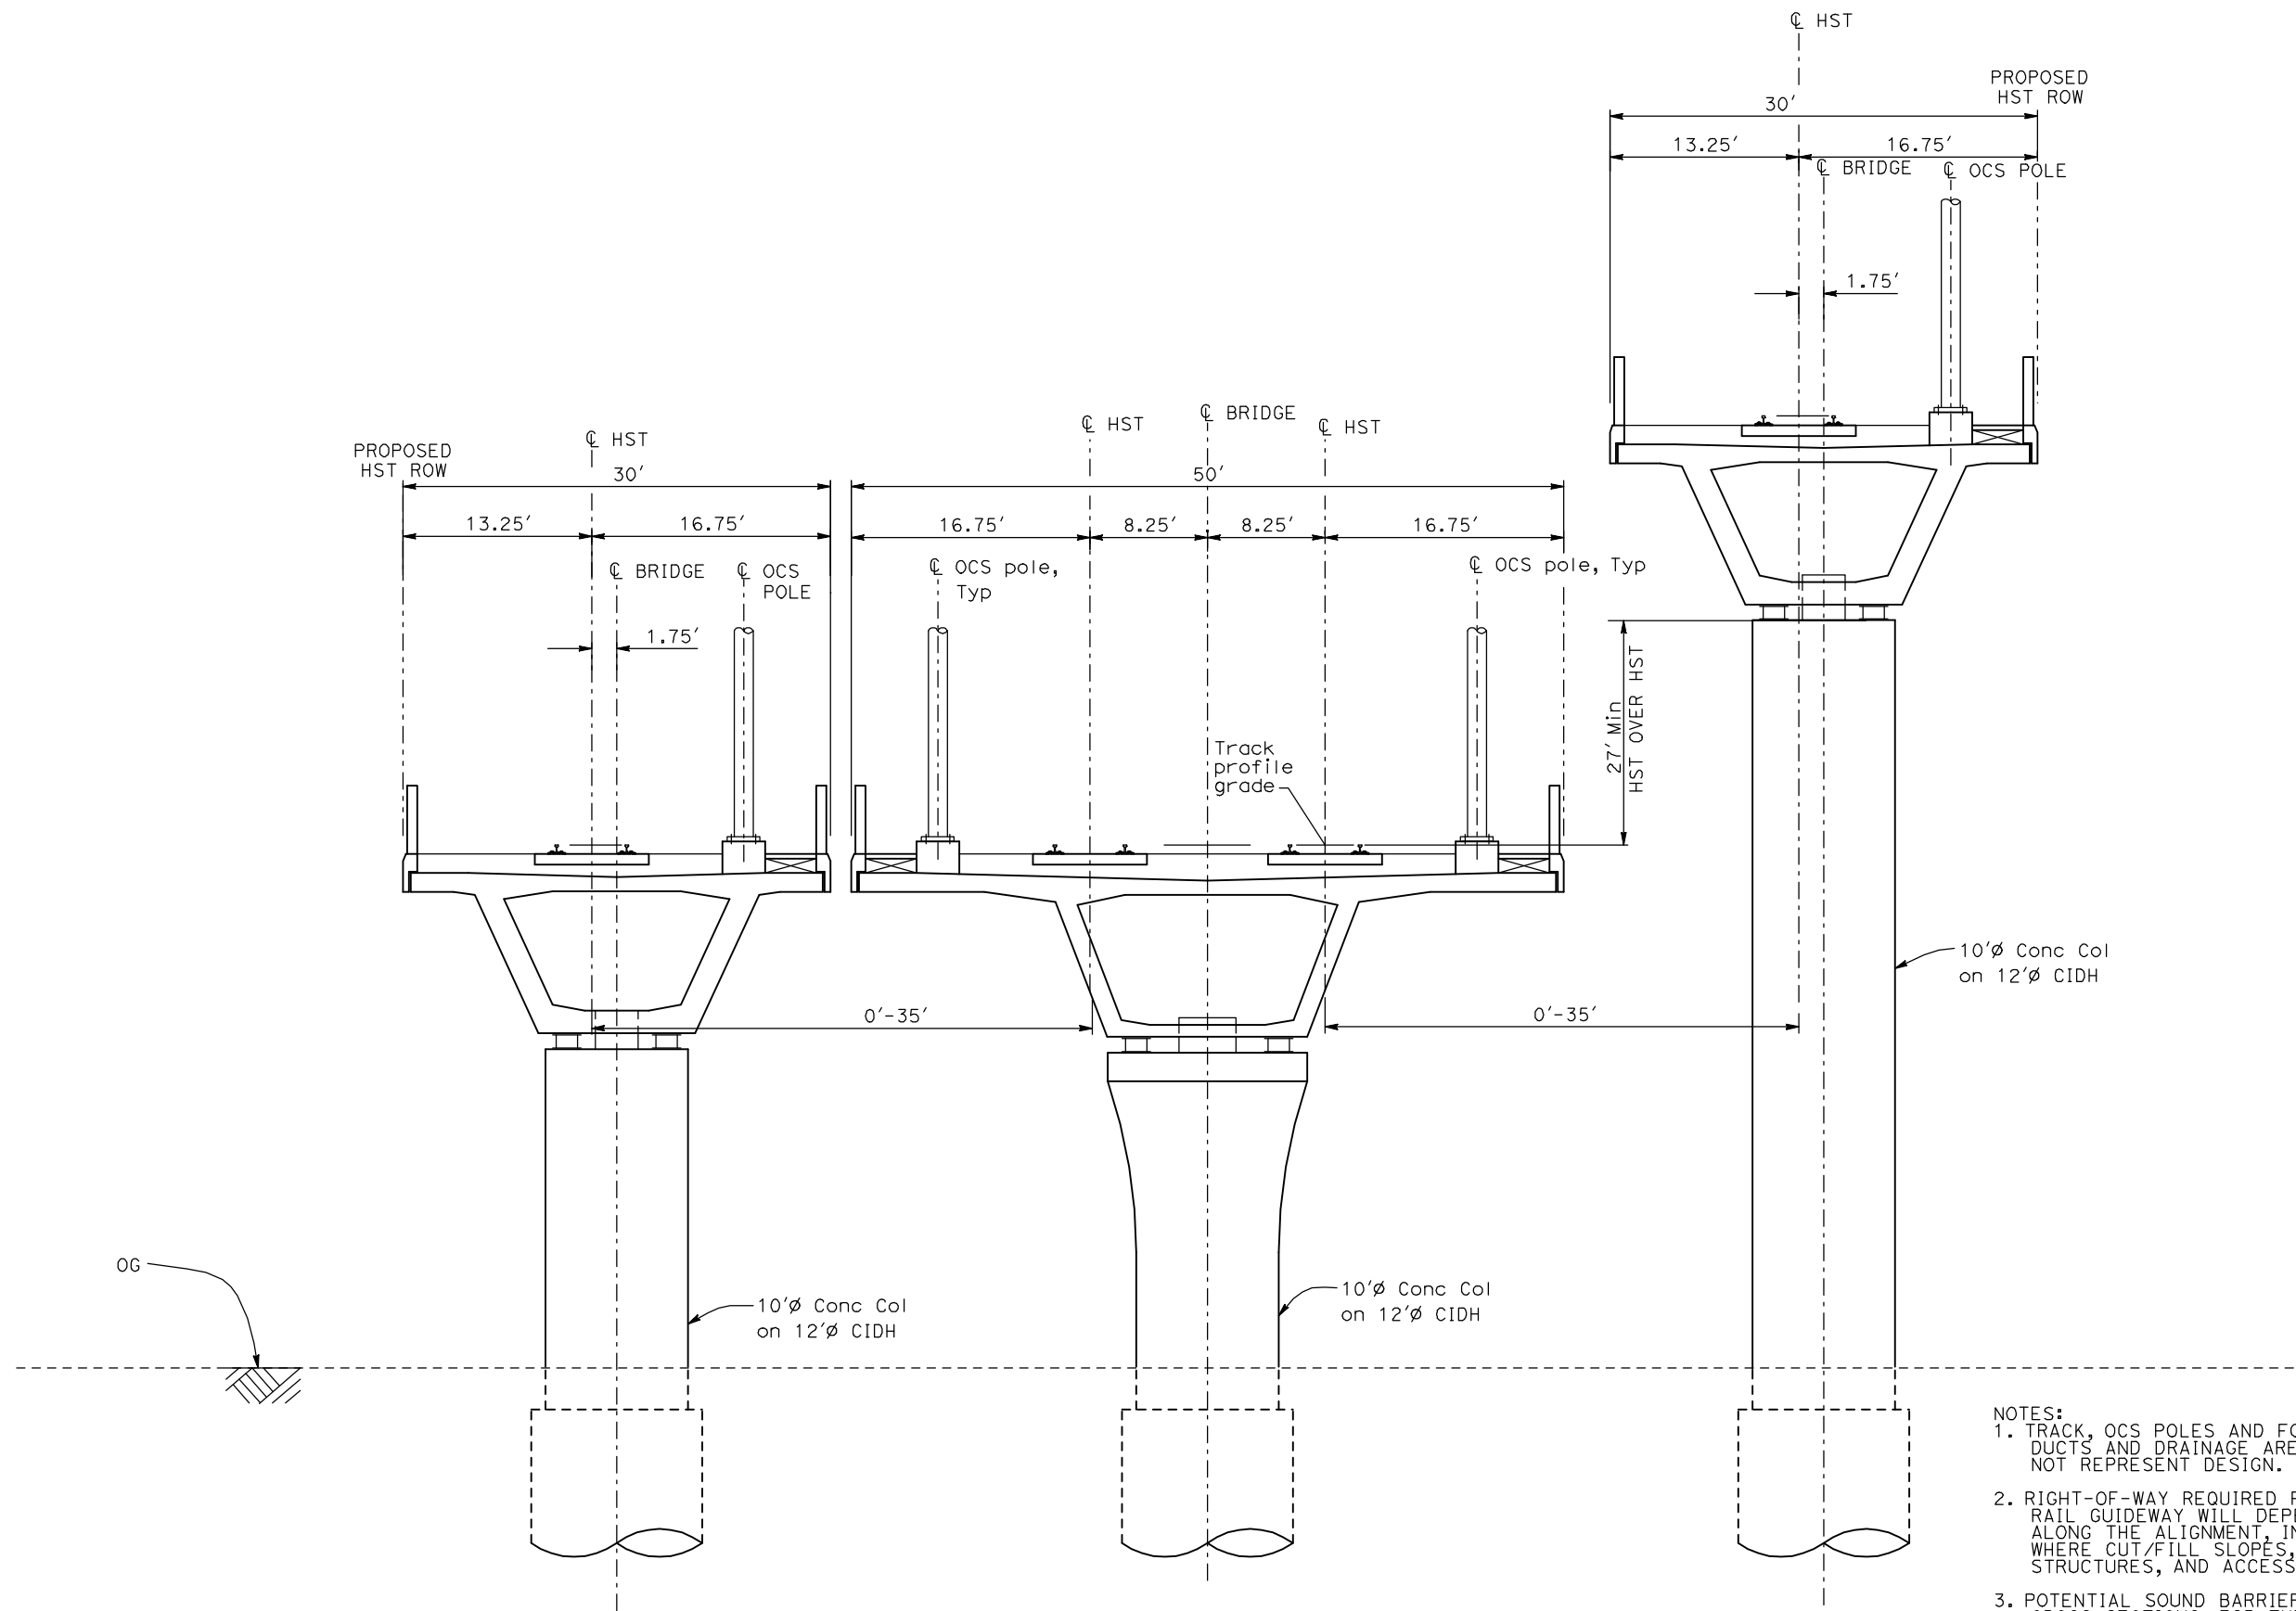
SCALE  
NO SCALE

SHEET NO.  
OF ###



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ShieldsA



WYE2 - WYE CONNECTION GRADE SEPERATED

- NOTES:
1. TRACK, OCS POLES AND FOUNDATIONS, CABLE DUCTS AND DRAINAGE ARE SCHEMATIC AND DO NOT REPRESENT DESIGN.
  2. RIGHT-OF-WAY REQUIRED FOR THE HIGH-SPEED RAIL GUIDEWAY WILL DEPEND UPON CONDITIONS ALONG THE ALIGNMENT, INCLUDING TERRAIN, WHERE CUT/FILL SLOPES, RETAINING STRUCTURES, AND ACCESS ARE REQUIRED.
  3. POTENTIAL SOUND BARRIERS NOT SHOWN IN CROSS SECTIONS. FOR THE EXTENT OF POTENTIAL SOUND BARRIERS, SEE ALIGNMENT PLAN AND PROFILE SHEETS.

REV	DATE	BY	CHK	APP	DESCRIPTION

DESIGNED BY  
A. SHIELDS  
DRAWN BY  
C. VALADAO  
CHECKED BY  
A. BOONE  
IN CHARGE  
A. BOONE  
DATE  
07/20/2011

**RECORD SET**  
**15% DESIGN**  
**SUBMITTAL**

**NOT FOR**  
**CONSTRUCTION**

**AECOM**  
Technical Services, Inc.  
2020 L Street, Suite 300  
Sacramento, CA 95811

**CH2M HILL**



**CALIFORNIA**  
HIGH-SPEED RAIL AUTHORITY

**CALIFORNIA HIGH-SPEED TRAIN PROJECT**  
**MERCED TO FRESNO**

TYPICAL SECTIONS  
SHEET 16 OF 17

CONTRACT NO.  
HSR06-007  
DRAWING NO.  
T3016-A  
SCALE  
NO SCALE  
SHEET NO.  
OF ###





- |  |                           |
|--|---------------------------|
| <h1> <b>4-SPEED TRAIN PROJECT</b> </h1> <h2> <b>ED TO FRESNO</b> </h2> | CONTRACT NO.<br>HSR06-007 |
|  | DRAWING NO.<br>T3017-A    |
|  | SCALE<br>NO SCALE         |
|  | SHEET NO.<br>OF ###       |

						DESIGNED BY A. SHIELDS
						DRAWN BY C. VALADAO
						CHECKED BY A. BOONE
						IN CHARGE A. BOONE
						DATE 07/20/2011
REV	DATE	BY	CHK	APP		DESCRIPTION

**NOT FOR  
CONSTRUCTION**

**AECOM**  
Technical Services, Inc.  
2020 L Street, Suite 300  
Sacramento, CA 95811

**CH2MHILL**



## CALIFORNIA HIGH-SPEED TRAIN PROJECT MERCED TO FRESNO

TYPICAL SECTIONS  
SHEET 17 OF 17

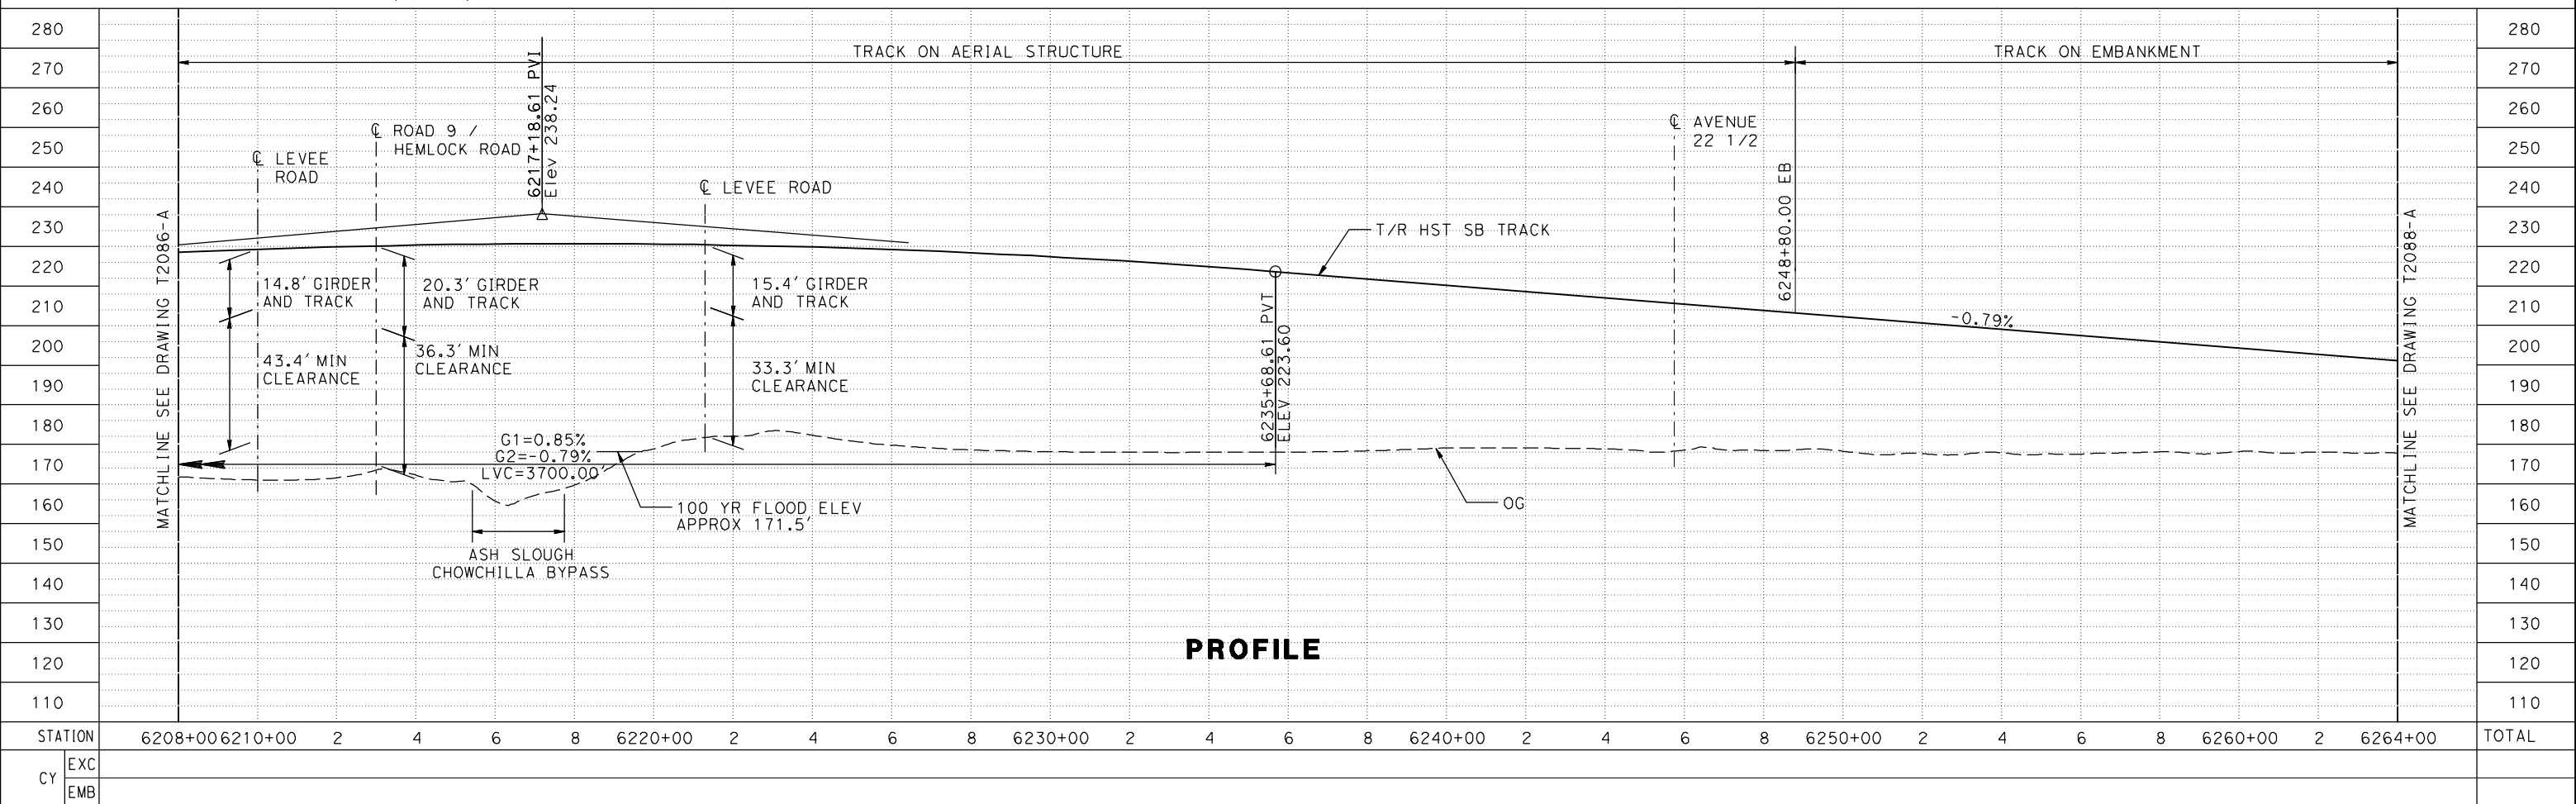
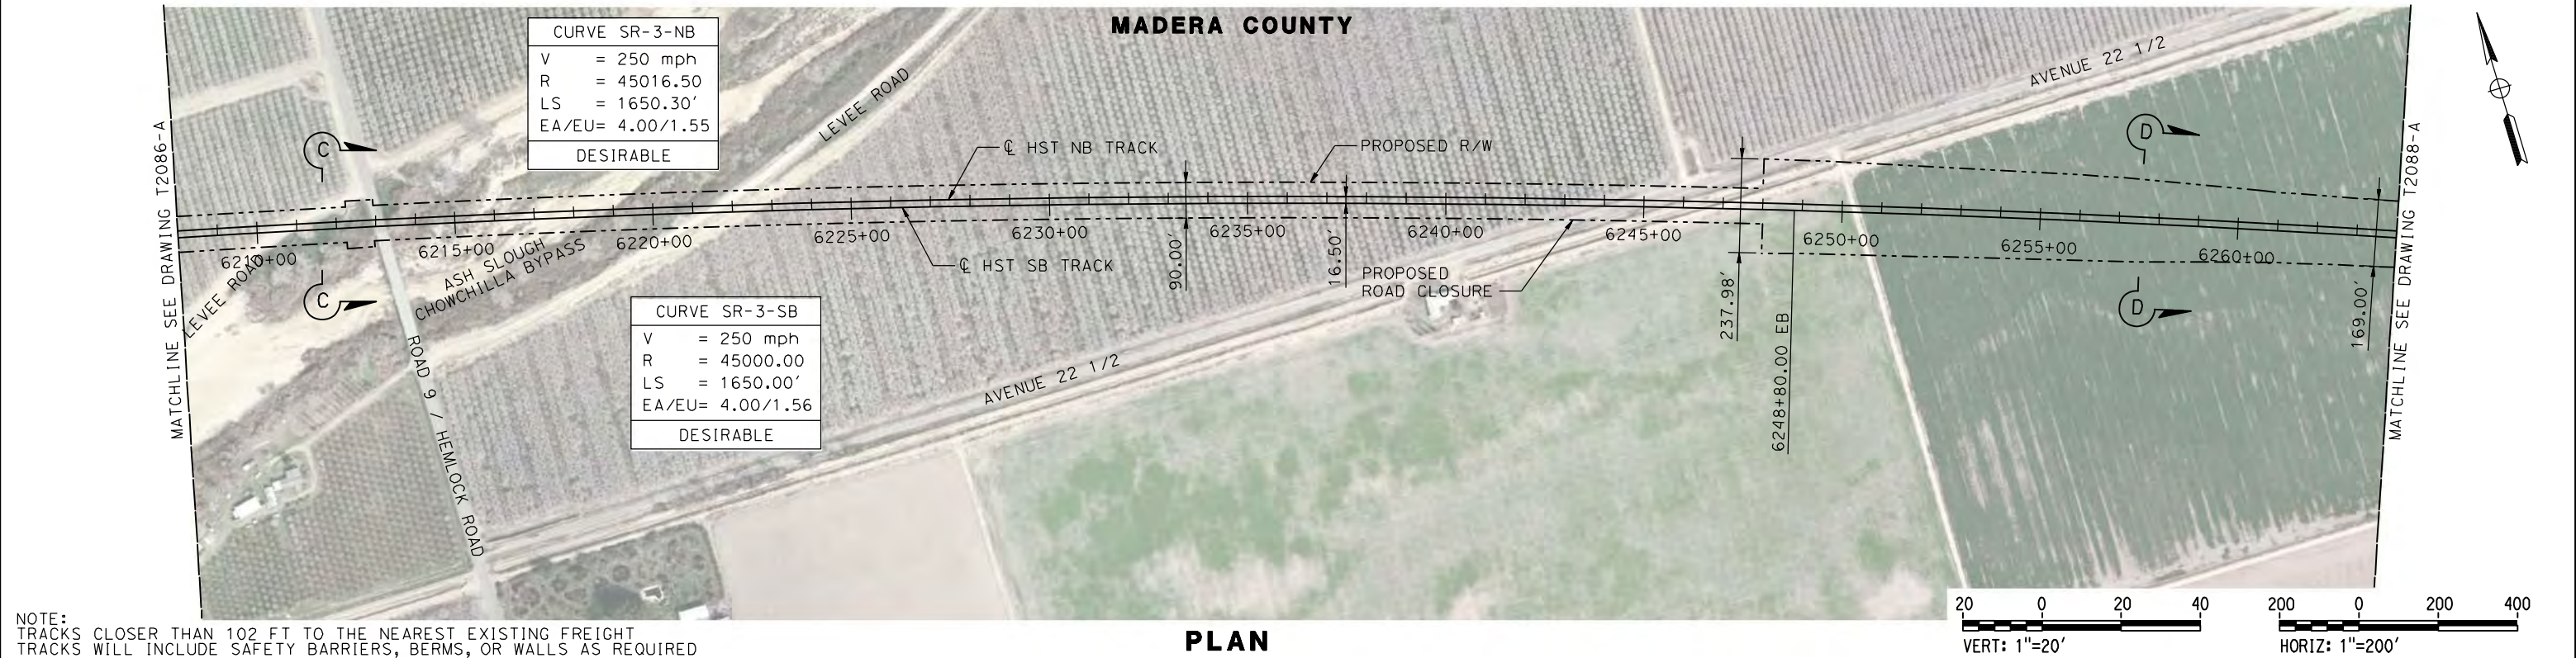






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P0037225



DESIGNED BY  
**P. JACOBY**  
DRAWN BY  
**ALBERT S.**  
CHECKED BY  
**RESHMA C.**  
IN CHARGE  
**D. WEMMER**  
DATE  
**4/15/2011**

**15% DRAFT  
SUBMITTAL  
FOR INTERNAL  
USE ONLY**

**NOT FOR  
CONSTRUCTION**



**CALIFORNIA HIGH-SPEED TRAIN PROJECT  
MERCED TO FRESNO**

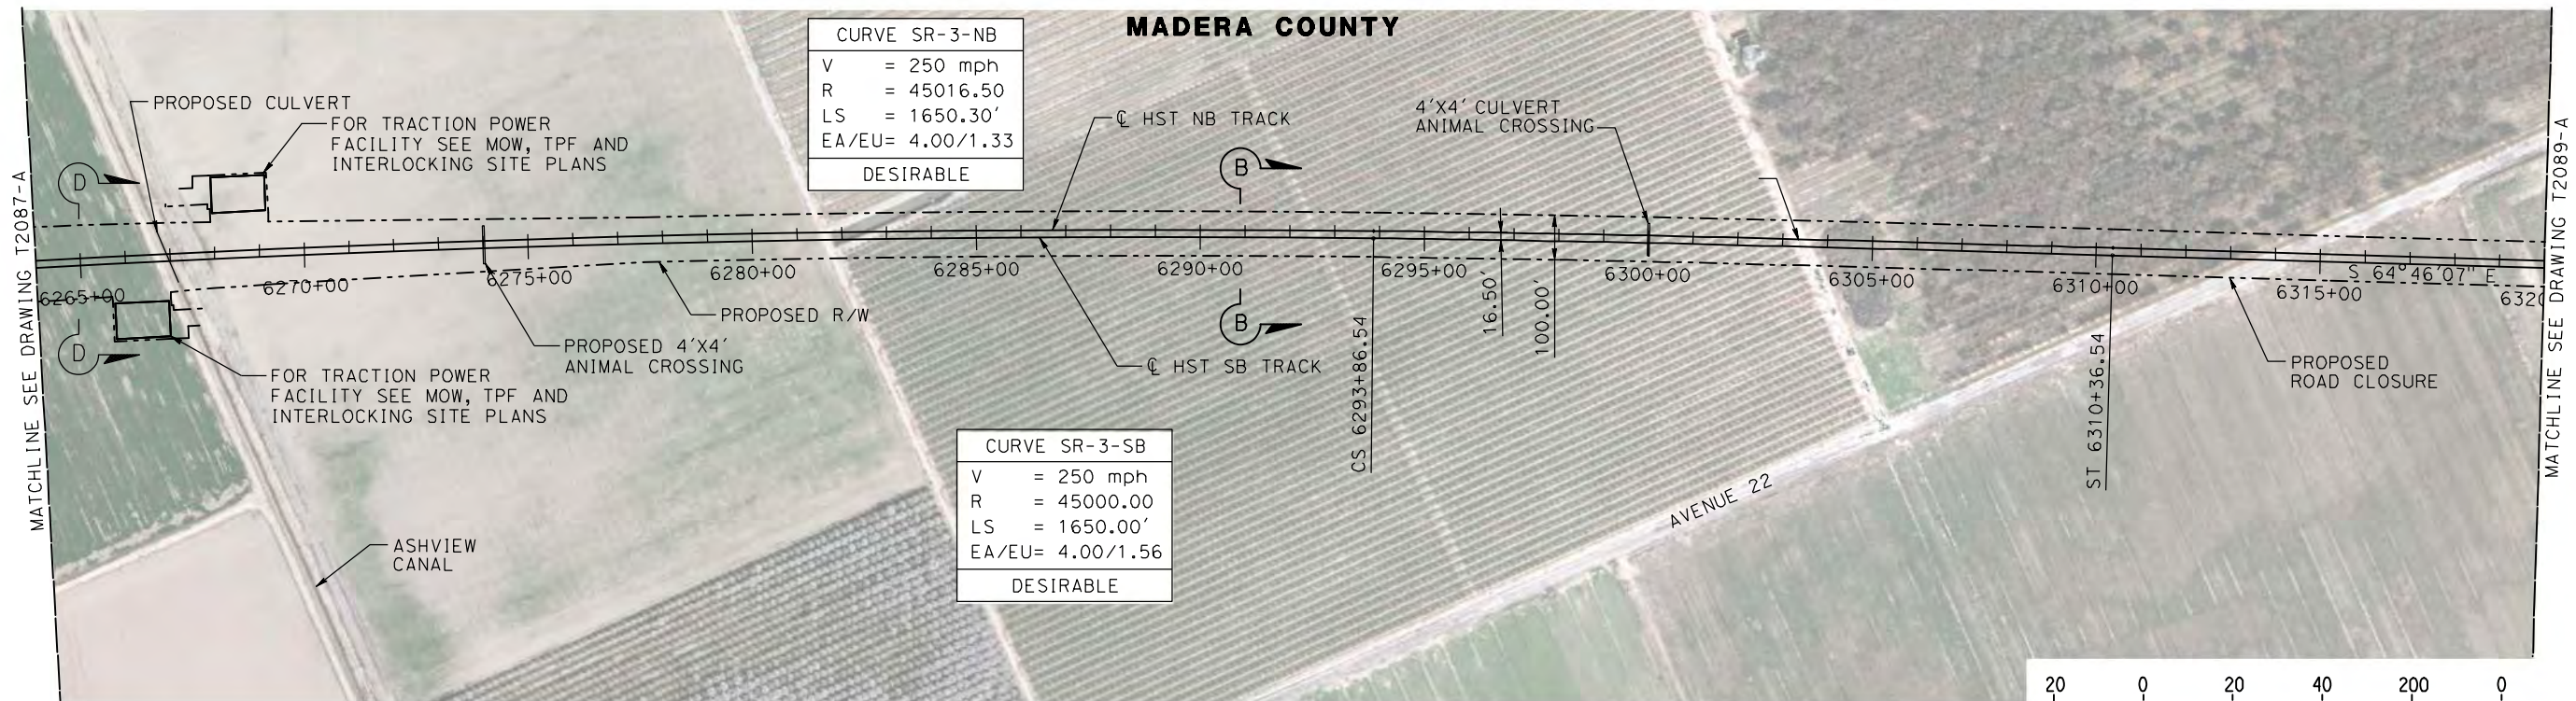
HYBRID  
AVENUE 24/SR152/AVENUE 21  
TRACK PLAN AND PROFILE  
STA 6208+00 TO STA 6264+00

CONTRACT NO.  
**HSR08-05**  
DRAWING NO.  
**T2087-A**  
SCALE  
**AS SHOWN**  
SHEET NO.

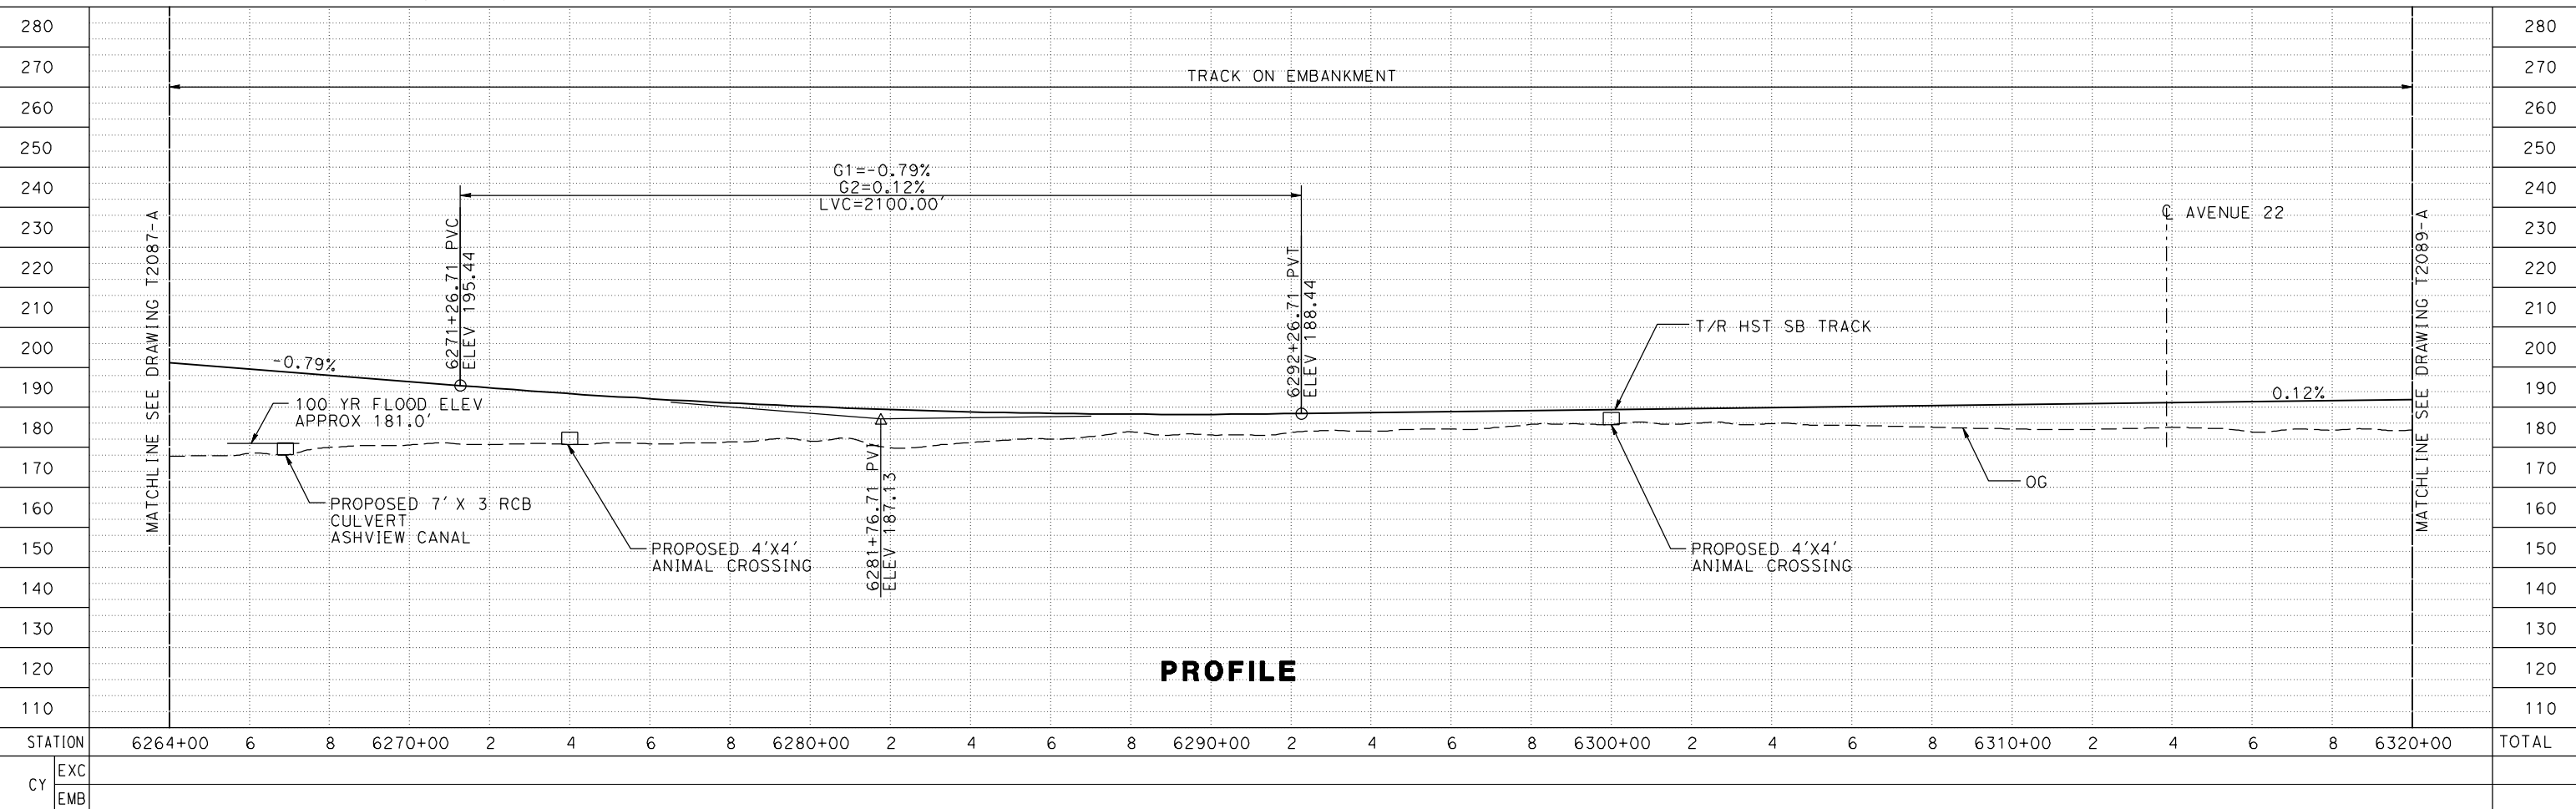


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P0037225



PLAN



PROFILE

DESIGNED BY  
P. JACOBY  
DRAWN BY  
ALBERT S.  
CHECKED BY  
RESHMA C.  
IN CHARGE  
D. WEMMER  
DATE  
4/15/2011

15% DRAFT  
SUBMITTAL  
FOR INTERNAL  
USE ONLY  
  
NOT FOR  
CONSTRUCTION



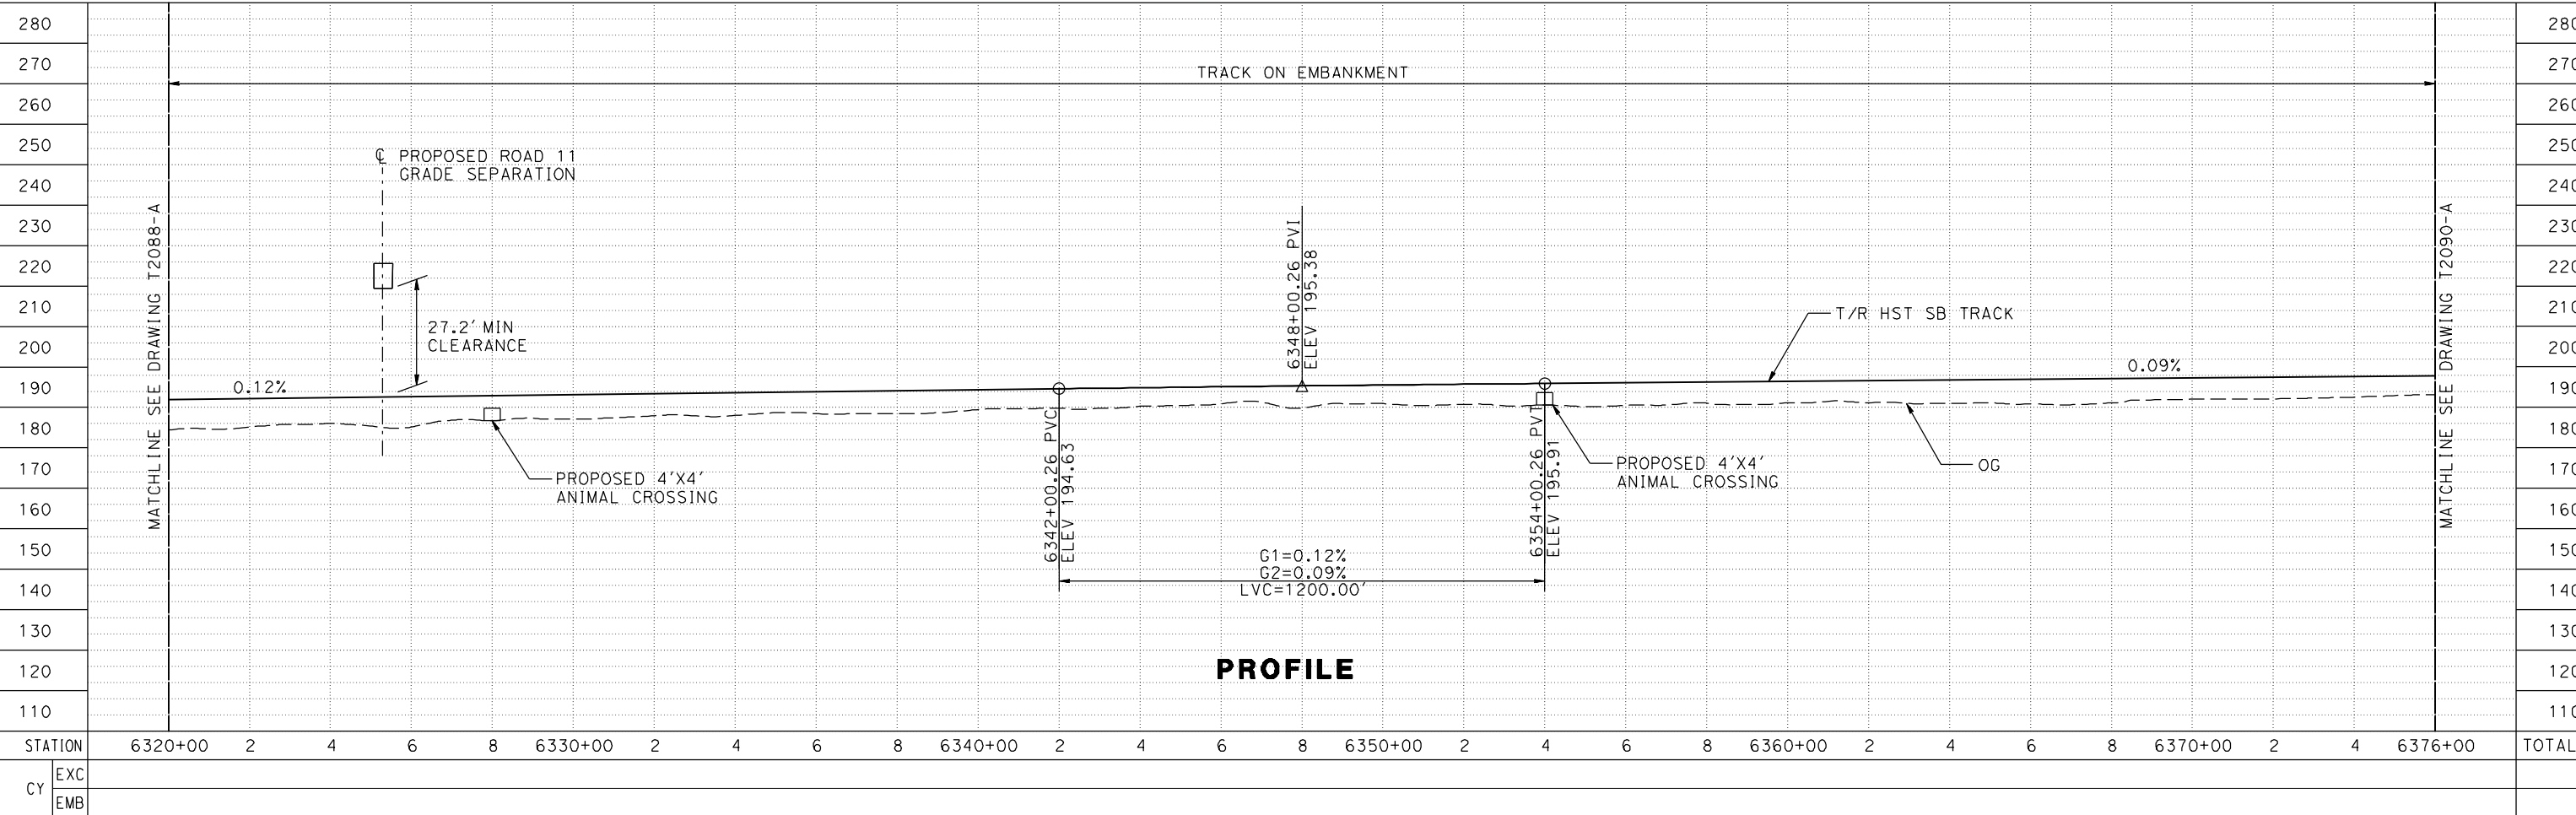
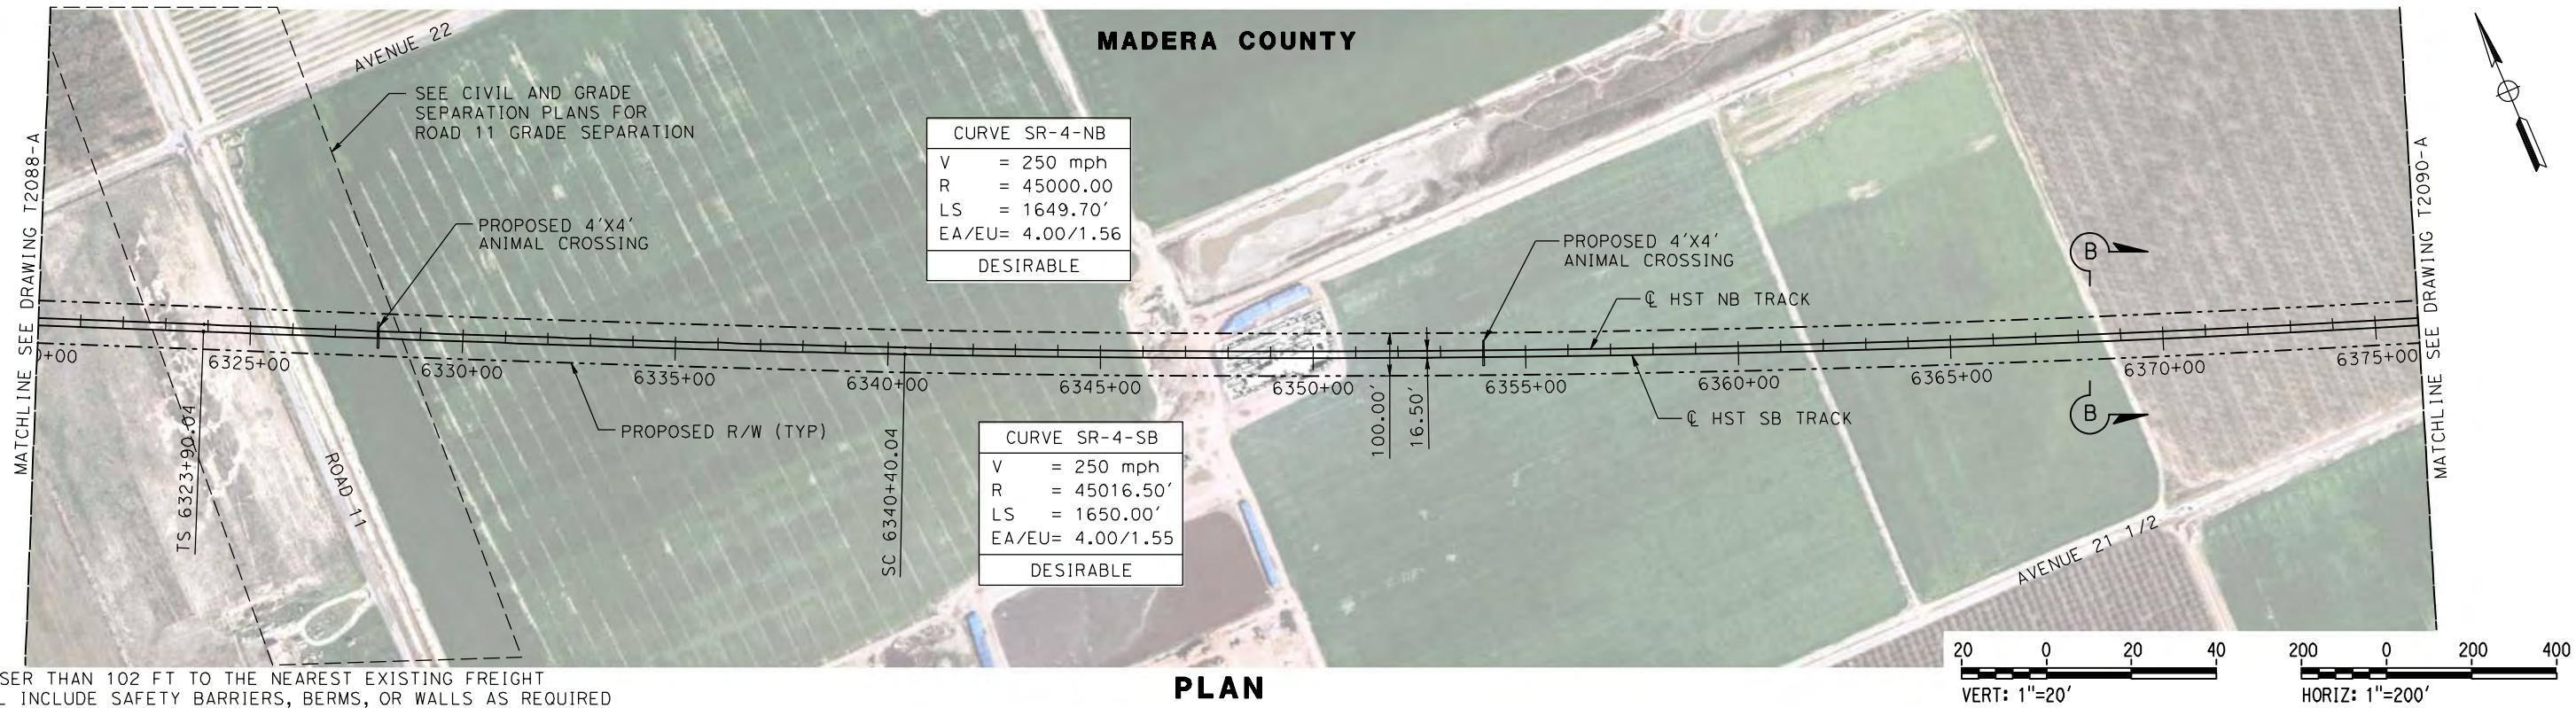
**CALIFORNIA HIGH-SPEED TRAIN PROJECT  
MERCED TO FRESNO**  
HYBRID  
AVENUE 24/SR152/AVENUE 21  
TRACK PLAN AND PROFILE  
STA 6264+00 TO STA 6320+00

CONTRACT NO.  
HSR08-05  
DRAWING NO.  
T2088-A  
SCALE  
AS SHOWN  
SHEET NO.



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P0037225



REV	DATE	BY	CHK	APP	DESCRIPTION

DESIGNED BY  
**P. JACOBY**

DRAWN BY  
**ALBERT S.**

CHECKED BY  
**RESHMA C.**

IN CHARGE  
**D. WEMMER**

DATE  
**4/15/2011**

**15% DRAFT  
SUBMITTAL  
FOR INTERNAL  
USE ONLY**

**NOT FOR  
CONSTRUCTION**



**CALIFORNIA HIGH-SPEED TRAIN PROJECT  
MERCED TO FRESNO**

HYBRID  
AVENUE 24/SR152/AVENUE 21  
TRACK PLAN AND PROFILE  
STA 6320+00 TO STA 6376+00

CONTRACT NO.  
**HSR08-05**

DRAWING NO.  
**T2089-A**

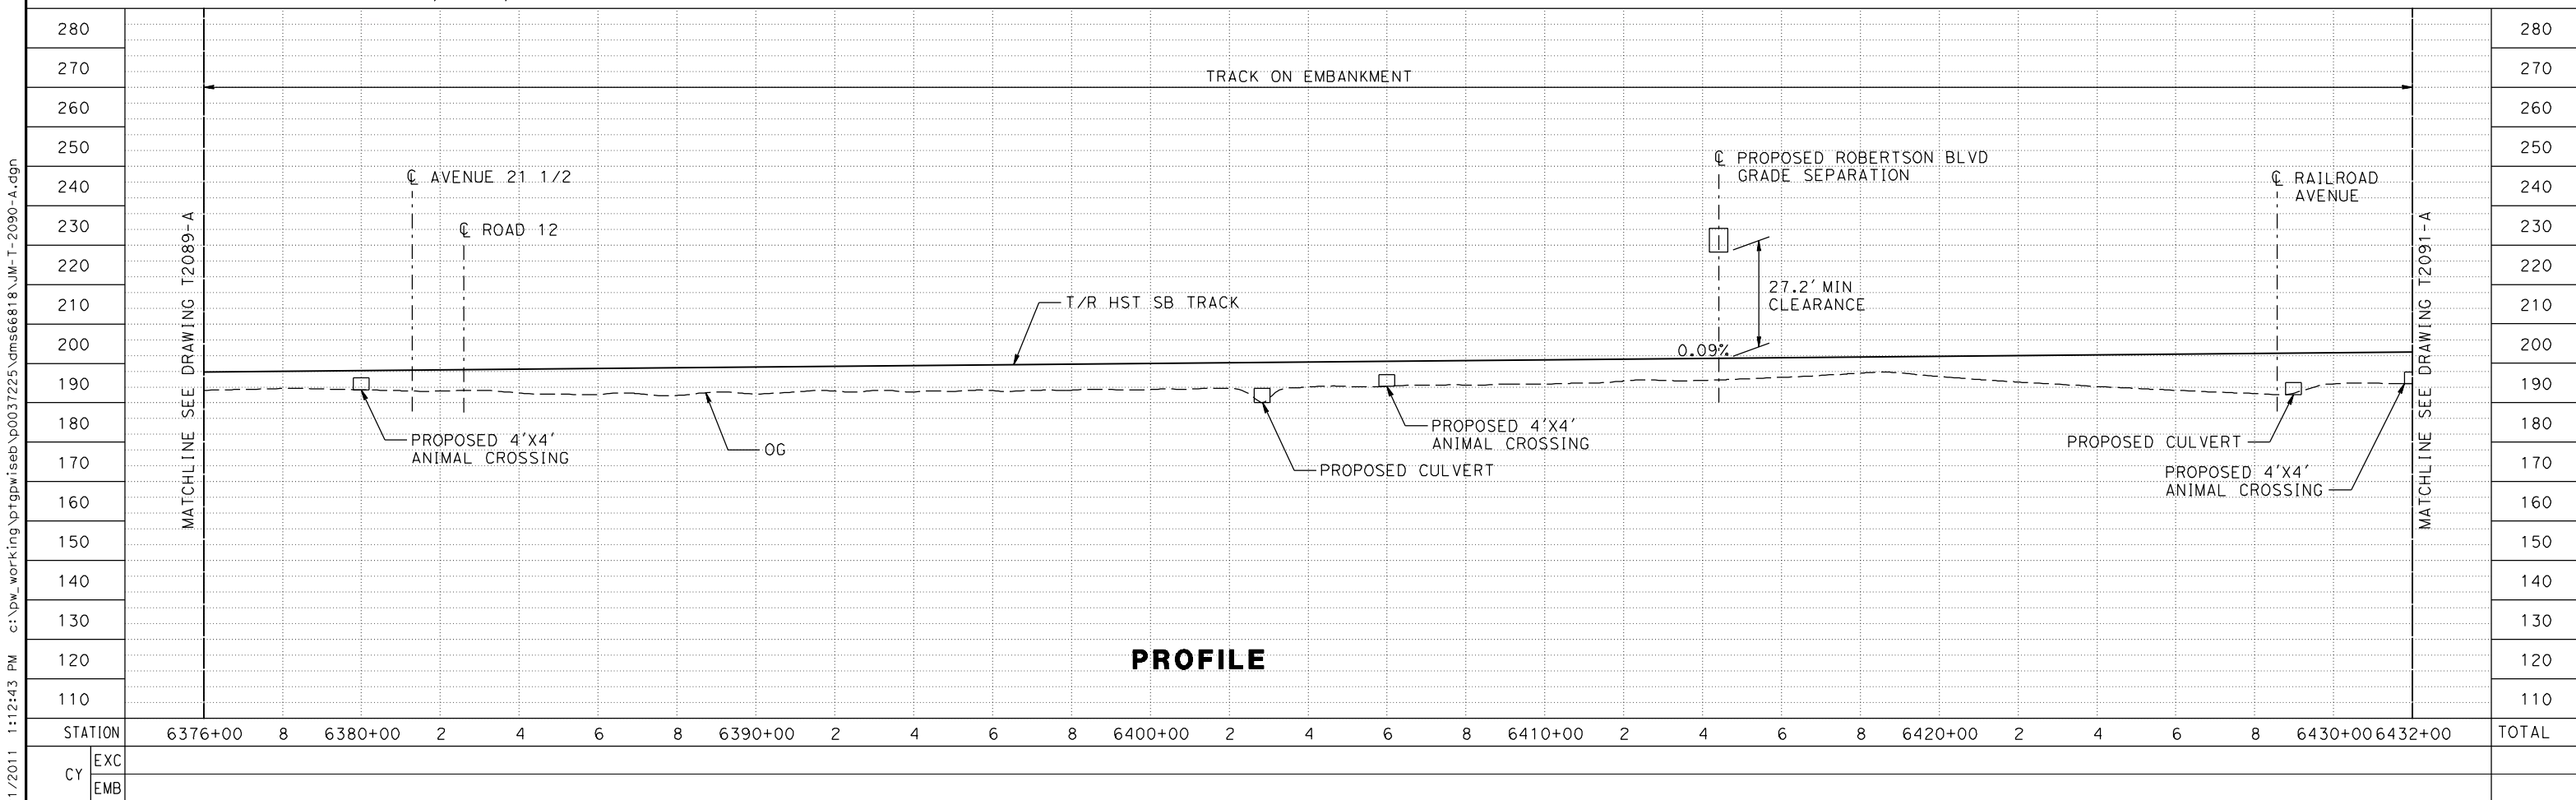
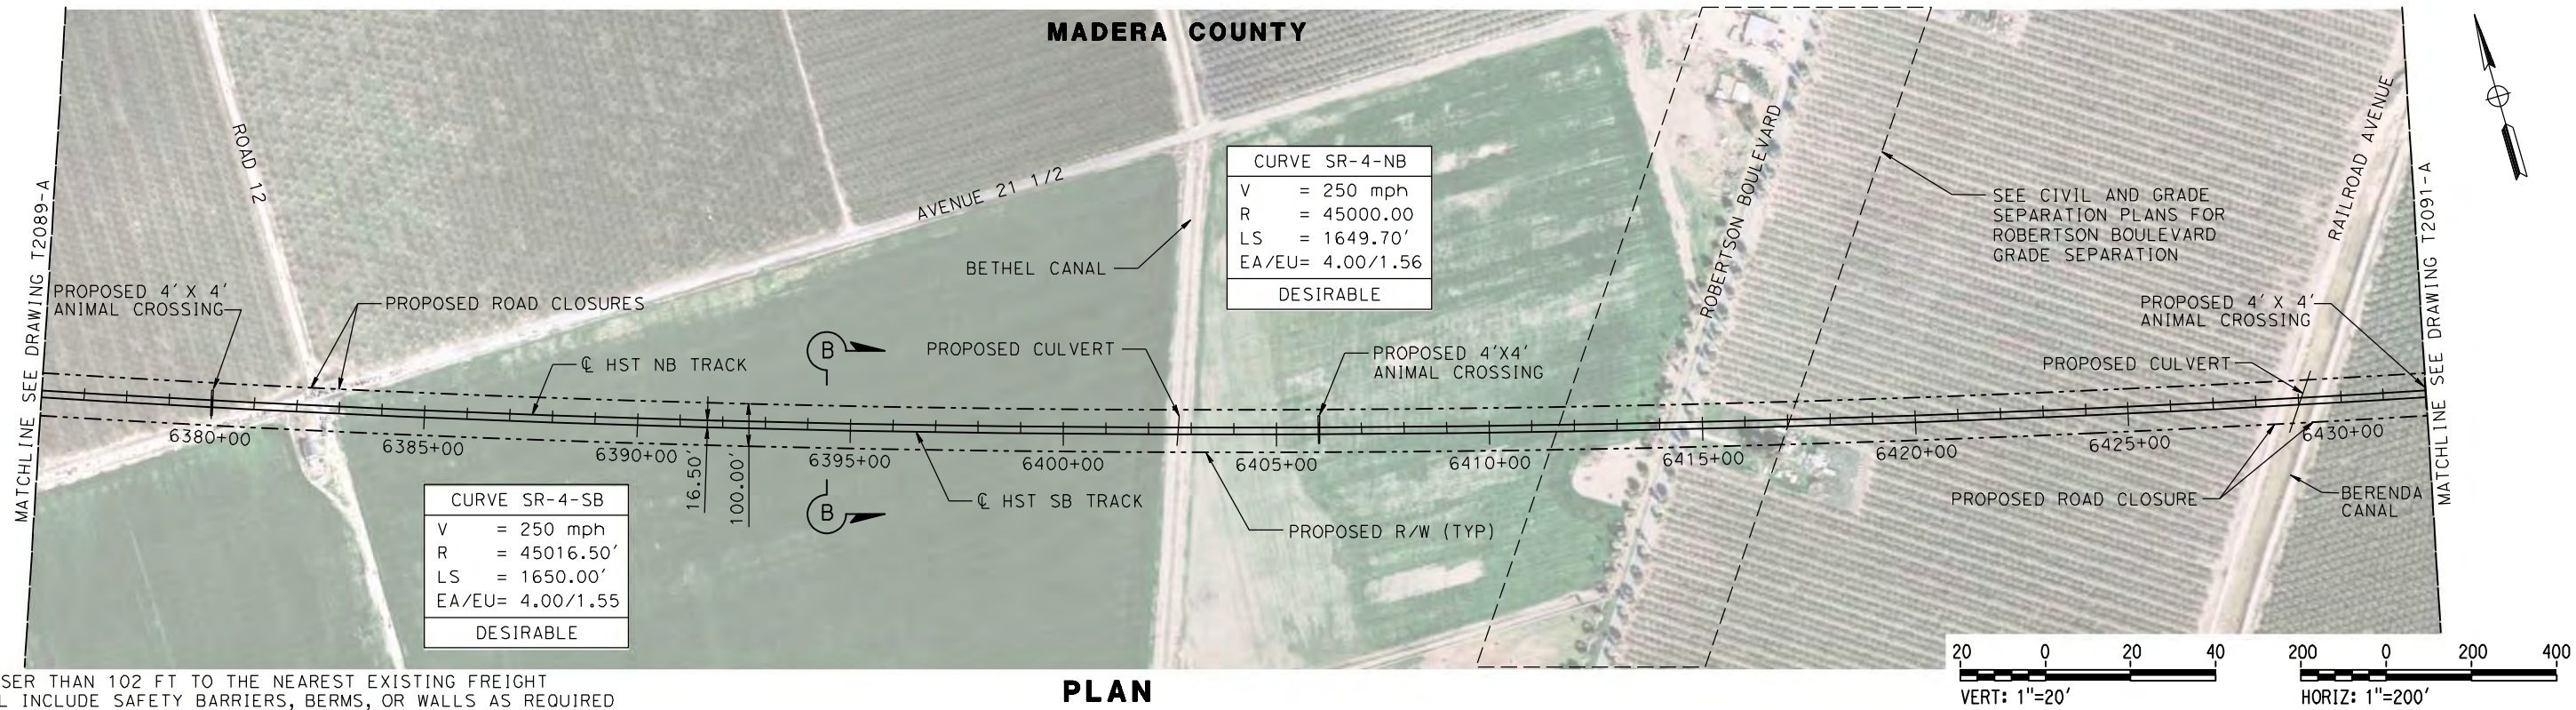
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

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P0037225

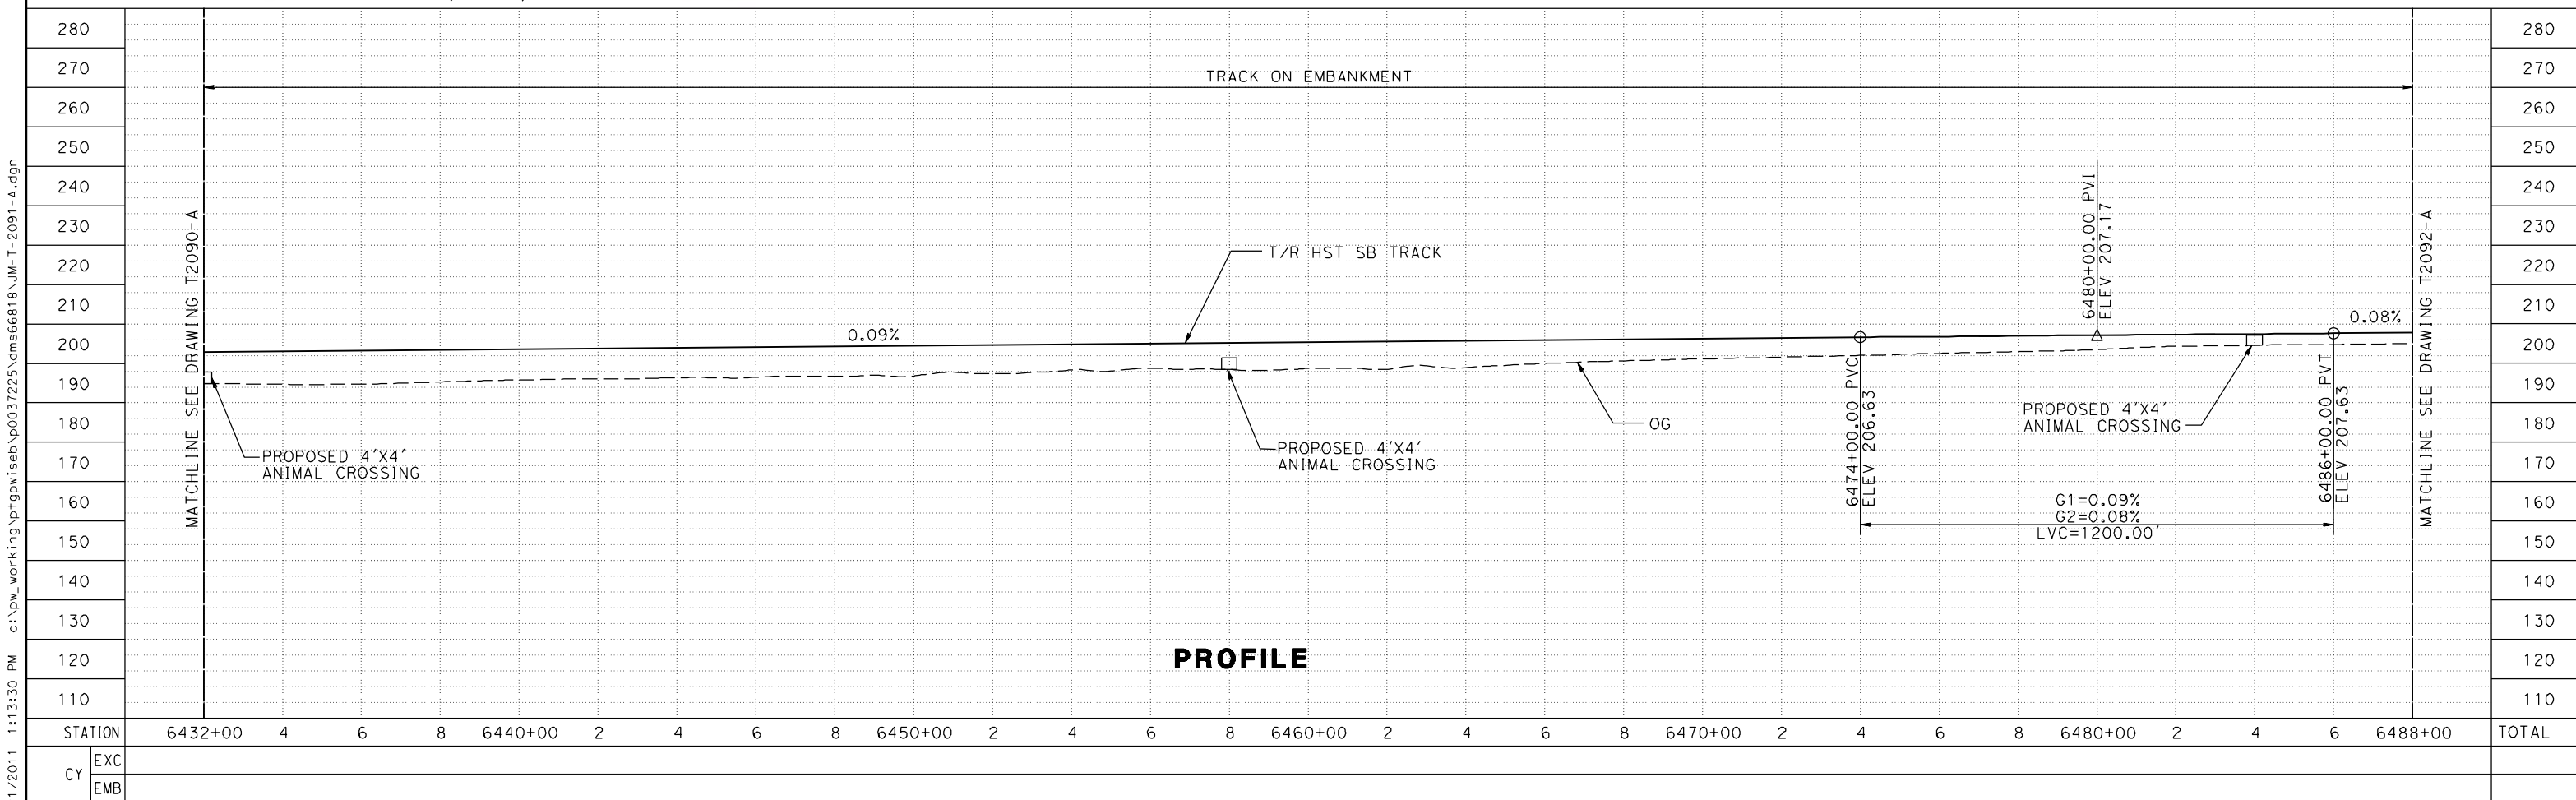
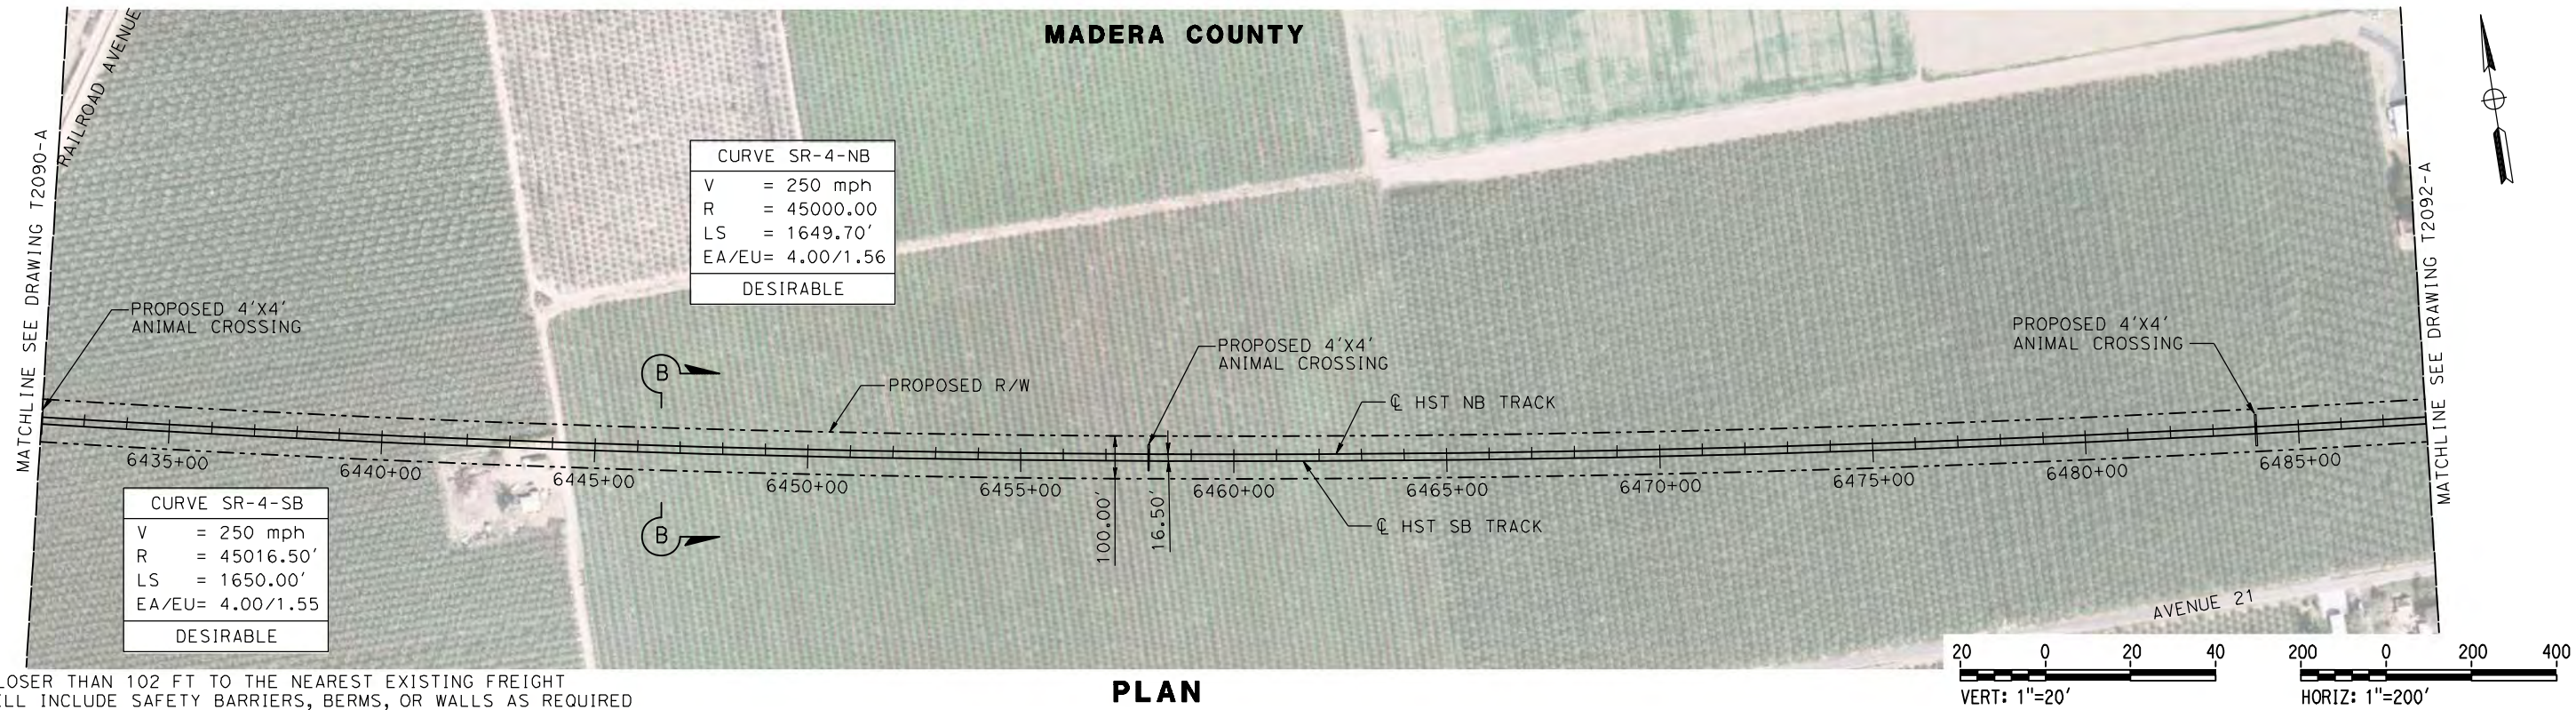




DESIGNED BY <b>P. JACOBY</b>	<b>15% DRAFT SUBMITTAL FOR INTERNAL USE ONLY</b>	<b>NOT FOR CONSTRUCTION</b>			<b>CALIFORNIA HIGH-SPEED TRAIN PROJECT MERCED TO FRESNO</b> HYBRID AVENUE 24/SR152/AVENUE 21 TRACK PLAN AND PROFILE STA 6376+00 TO STA 6432+00	CONTRACT NO. HSR08-05
DRAWN BY <b>ALBERT S.</b>						DRAWING NO. T2090-A
CHECKED BY <b>RESHMA C.</b>						SCALE AS SHOWN
IN CHARGE <b>D. WEMMER</b>						SHEET NO.
DATE <b>4/15/2011</b>						
REV	DATE	BY	CHK	APP	DESCRIPTION	



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P0037225



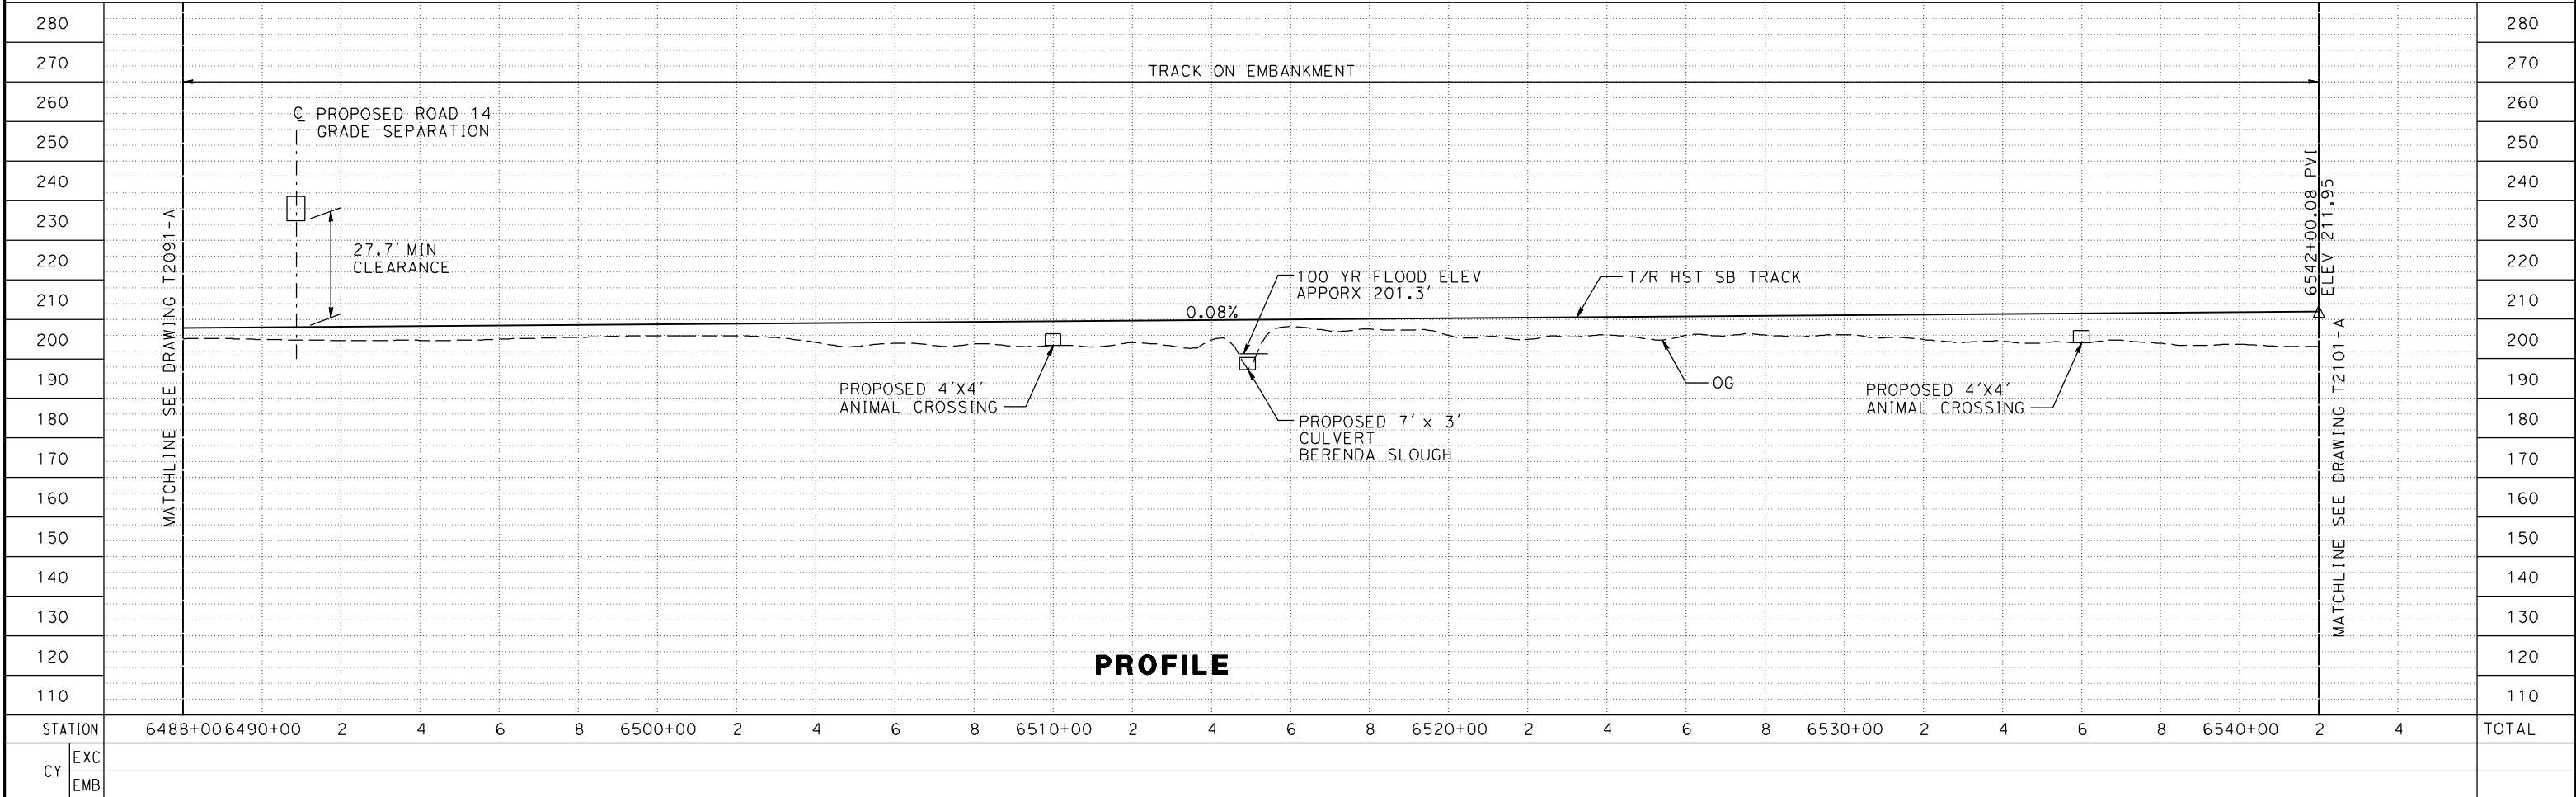
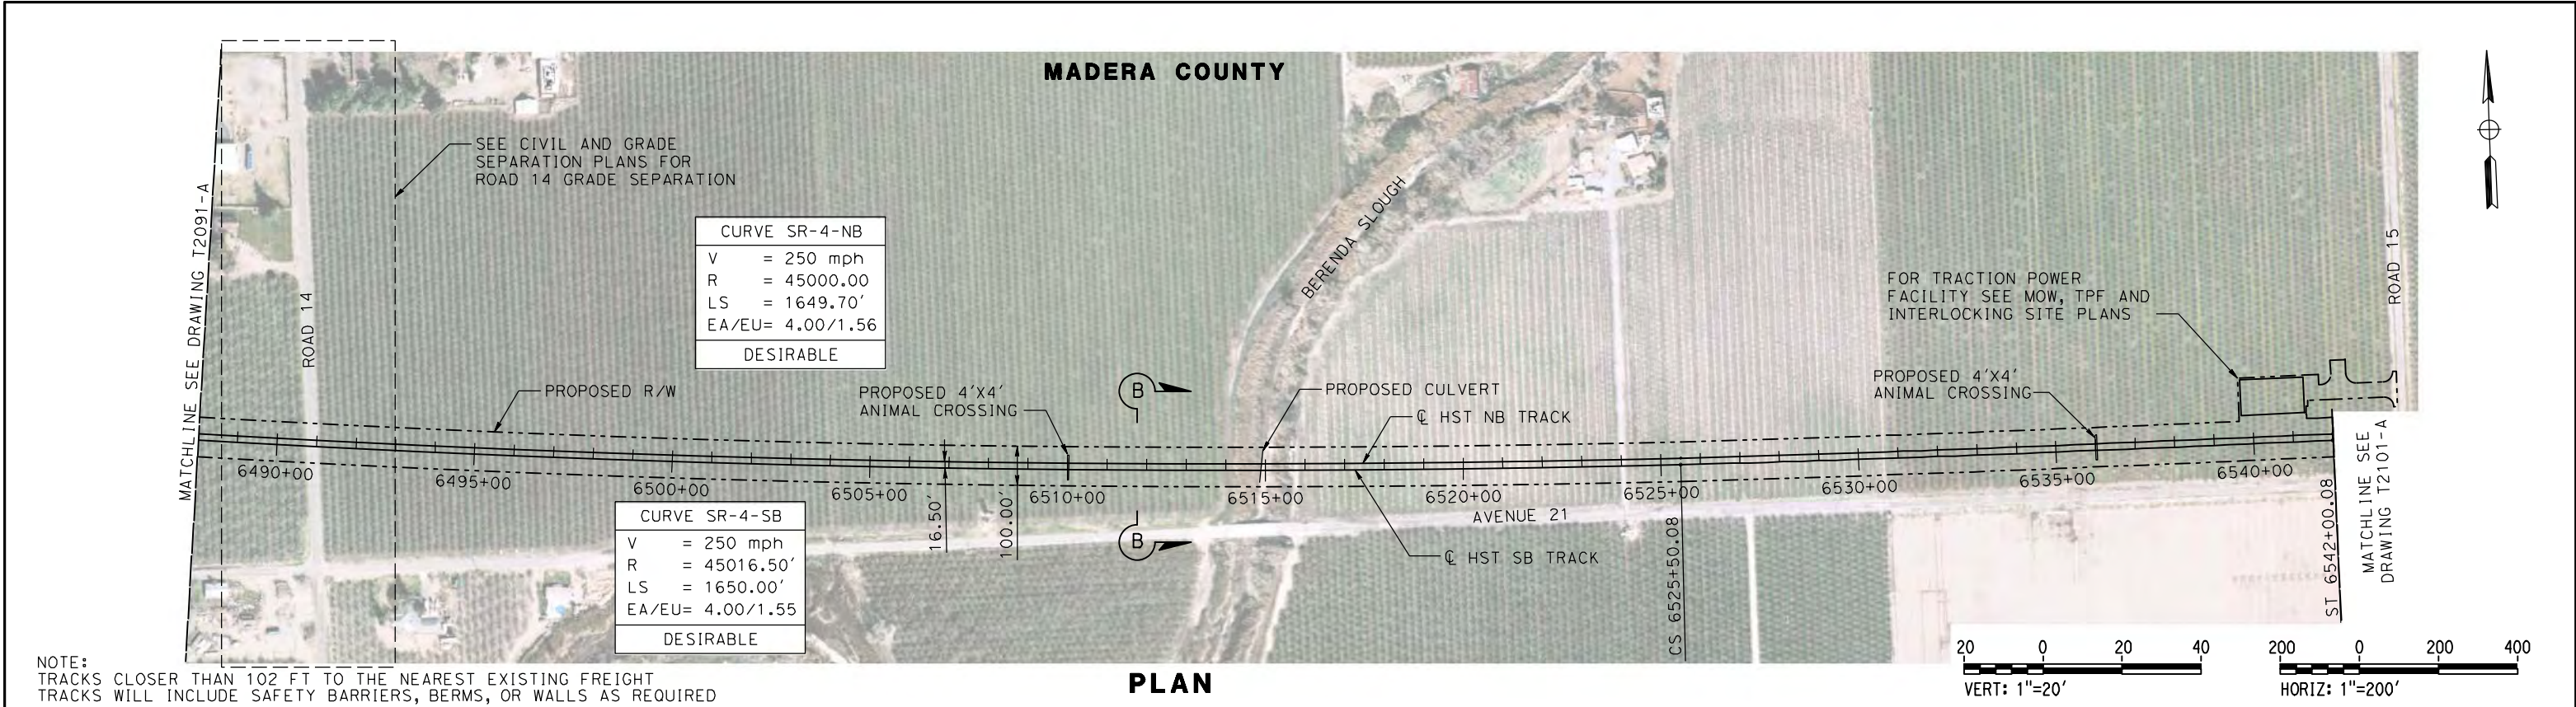
DESIGNED BY <b>P. JACOBY</b>	<b>15% DRAFT SUBMITTAL FOR INTERNAL USE ONLY</b>			<b>CALIFORNIA HIGH-SPEED TRAIN PROJECT MERCED TO FRESNO</b> HYBRID AVENUE 24/SR152/AVENUE 21 TRACK PLAN AND PROFILE STA 6432+00 TO STA 6488+00	CONTRACT NO. <b>HSR08-05</b>
DRAWN BY <b>ALBERT S.</b>					DRAWING NO. <b>T2091-A</b>
CHECKED BY <b>RESHMA C.</b>					SCALE <b>AS SHOWN</b>
IN CHARGE <b>D. WEMMER</b>					SHEET NO.
DATE <b>4/15/2011</b>					


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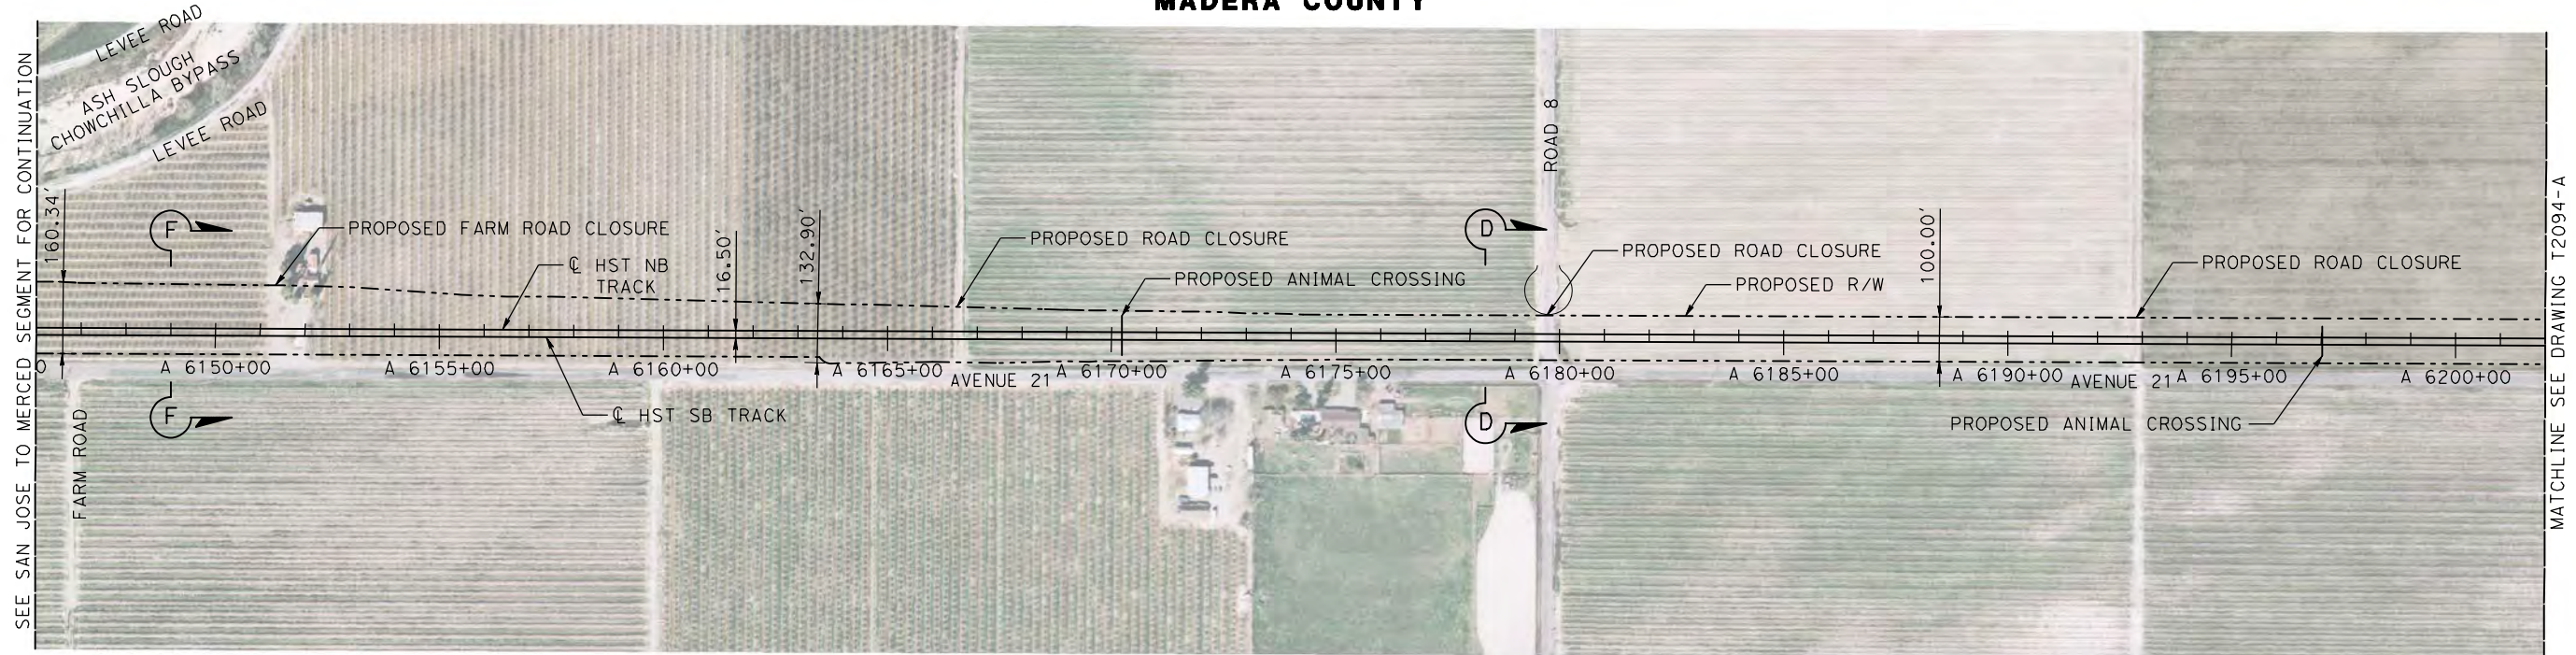
P0037225



						DESIGNED BY P. JACOBY	15% DRAFT SUBMITTAL FOR INTERNAL USE ONLY	 <b>PARSONS</b>	 <i>CALIFORNIA</i> HIGH-SPEED RAIL AUTHORITY	<b>CALIFORNIA HIGH-SPEED TRAIN PROJECT MERCED TO FRESNO</b>  HYBRID AVENUE 24/SR152/AVENUE 21 TRACK PLAN AND PROFILE 6488+00 TO STA 6542+00		CONTRACT NO. HSR08-05
					DRAWN BY ALBERT S.	DRAWING NO. T2092-A						
					CHECKED BY RESHMA C.	SCALE AS SHOWN						
					IN CHARGE D. WEMMER	SHEET NO.						
REV	DATE	BY	CHK	APP	DESCRIPTION	DATE 4/15/2011	NOT FOR CONSTRUCTION					

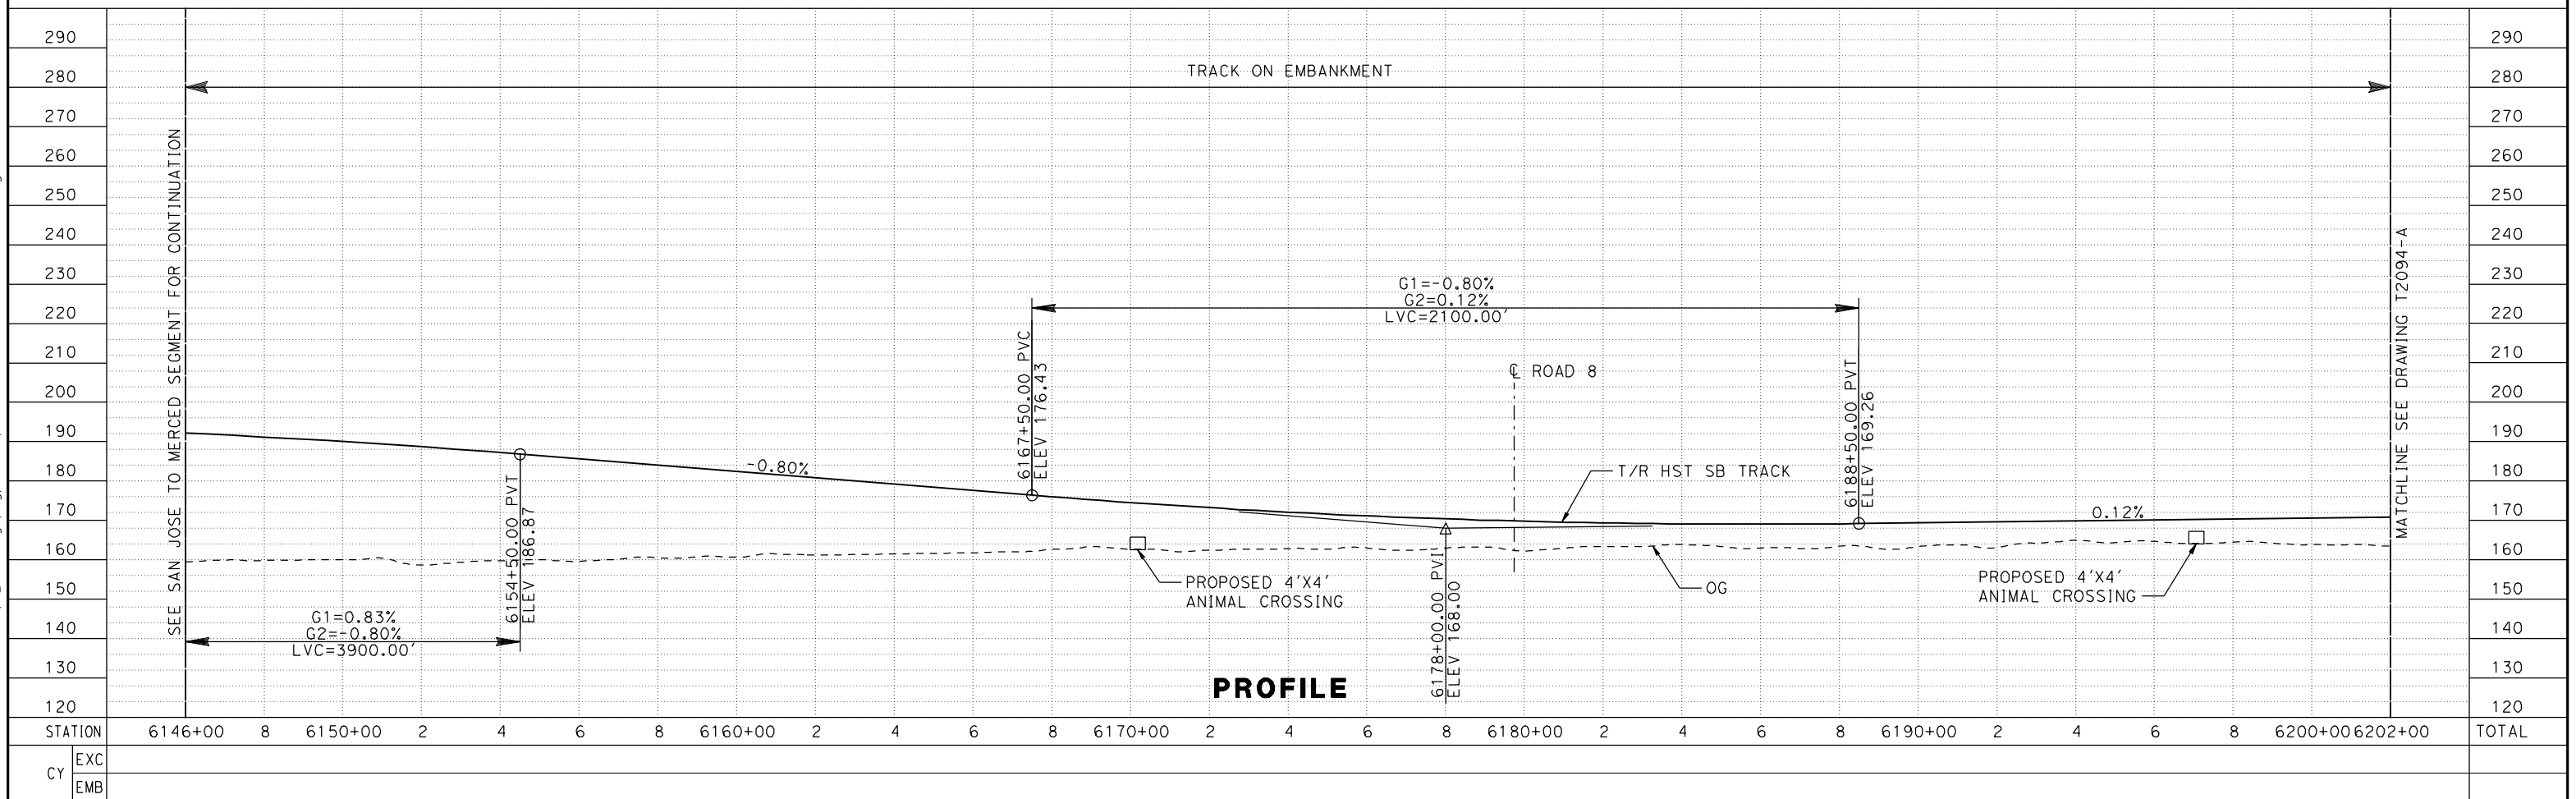
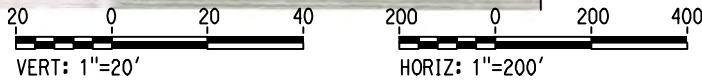




**MADERA COUNTY**



TRACKS CLOSER THAN 102 FT TO THE NEAREST EXISTING FREIGHT  
TRACKS WILL INCLUDE SAFETY BARRIERS, BERMS, OR WALLS AS REQUIRED

## PLAN



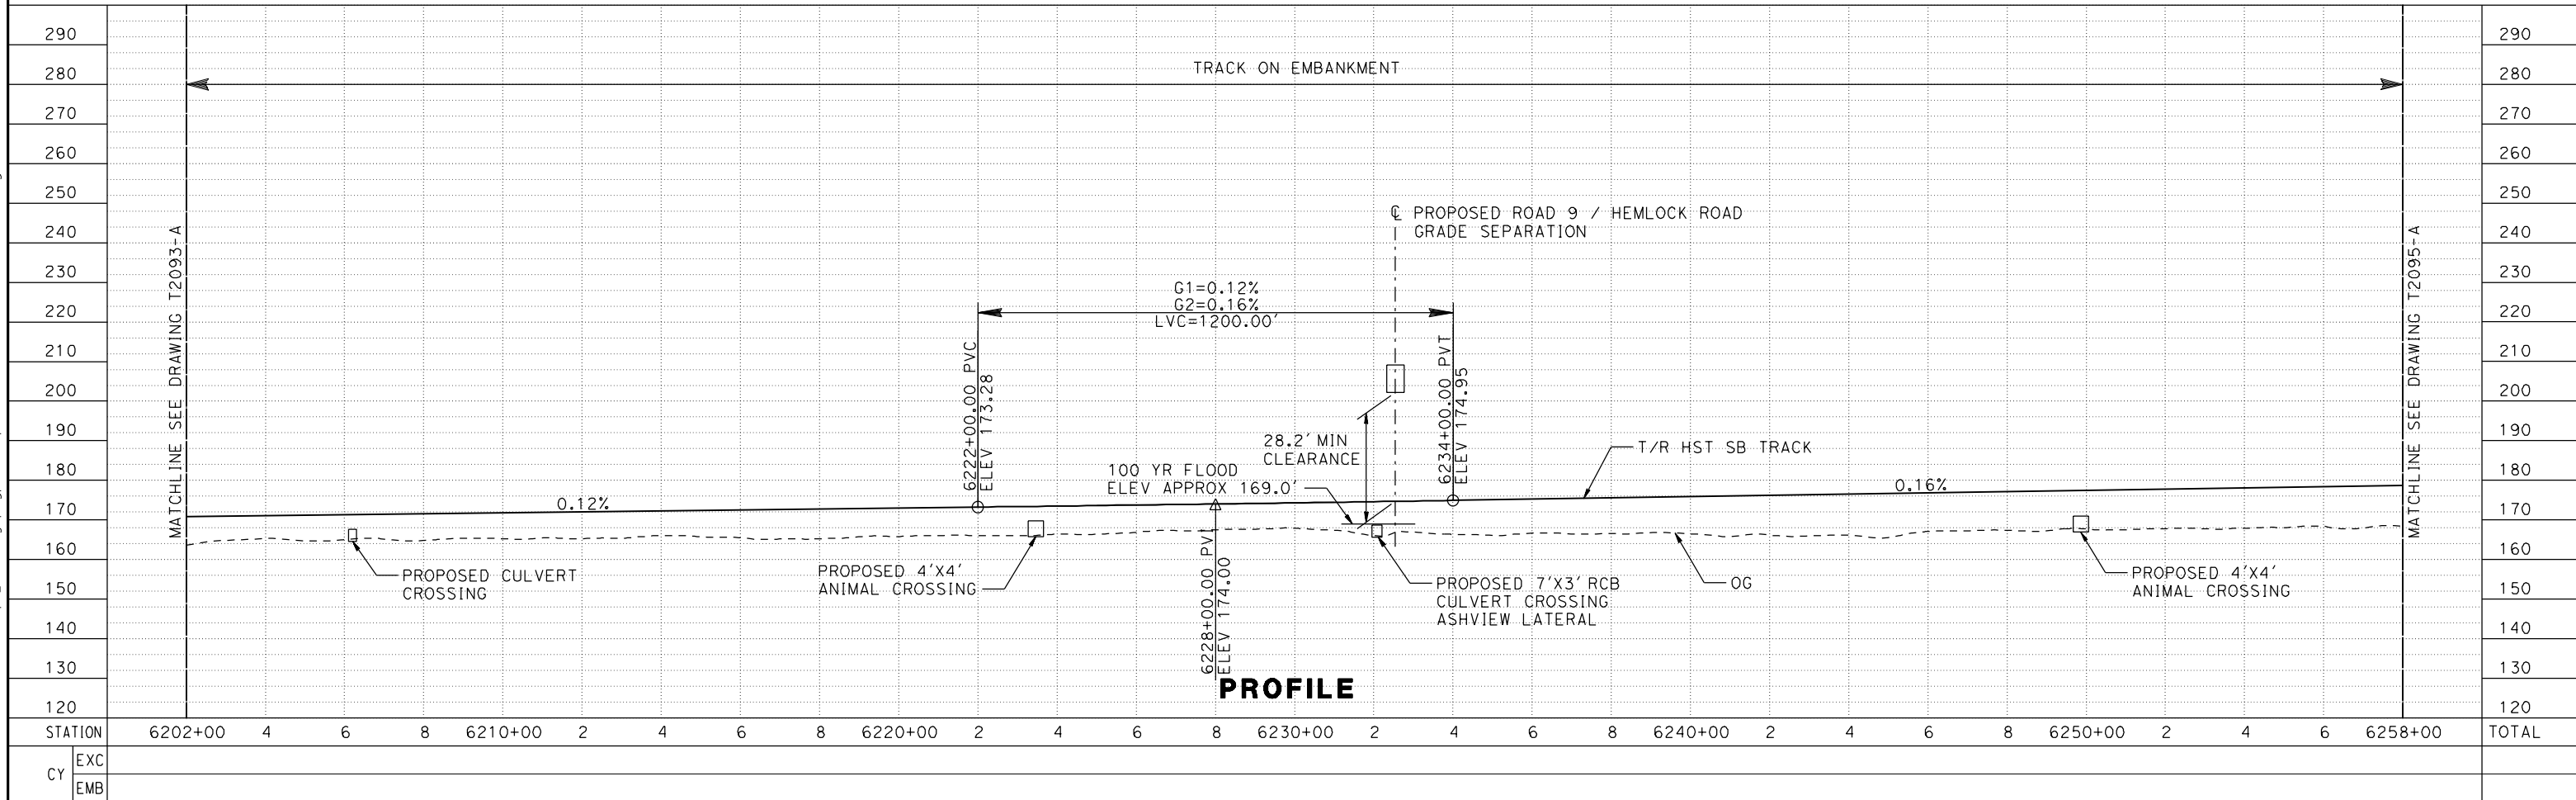
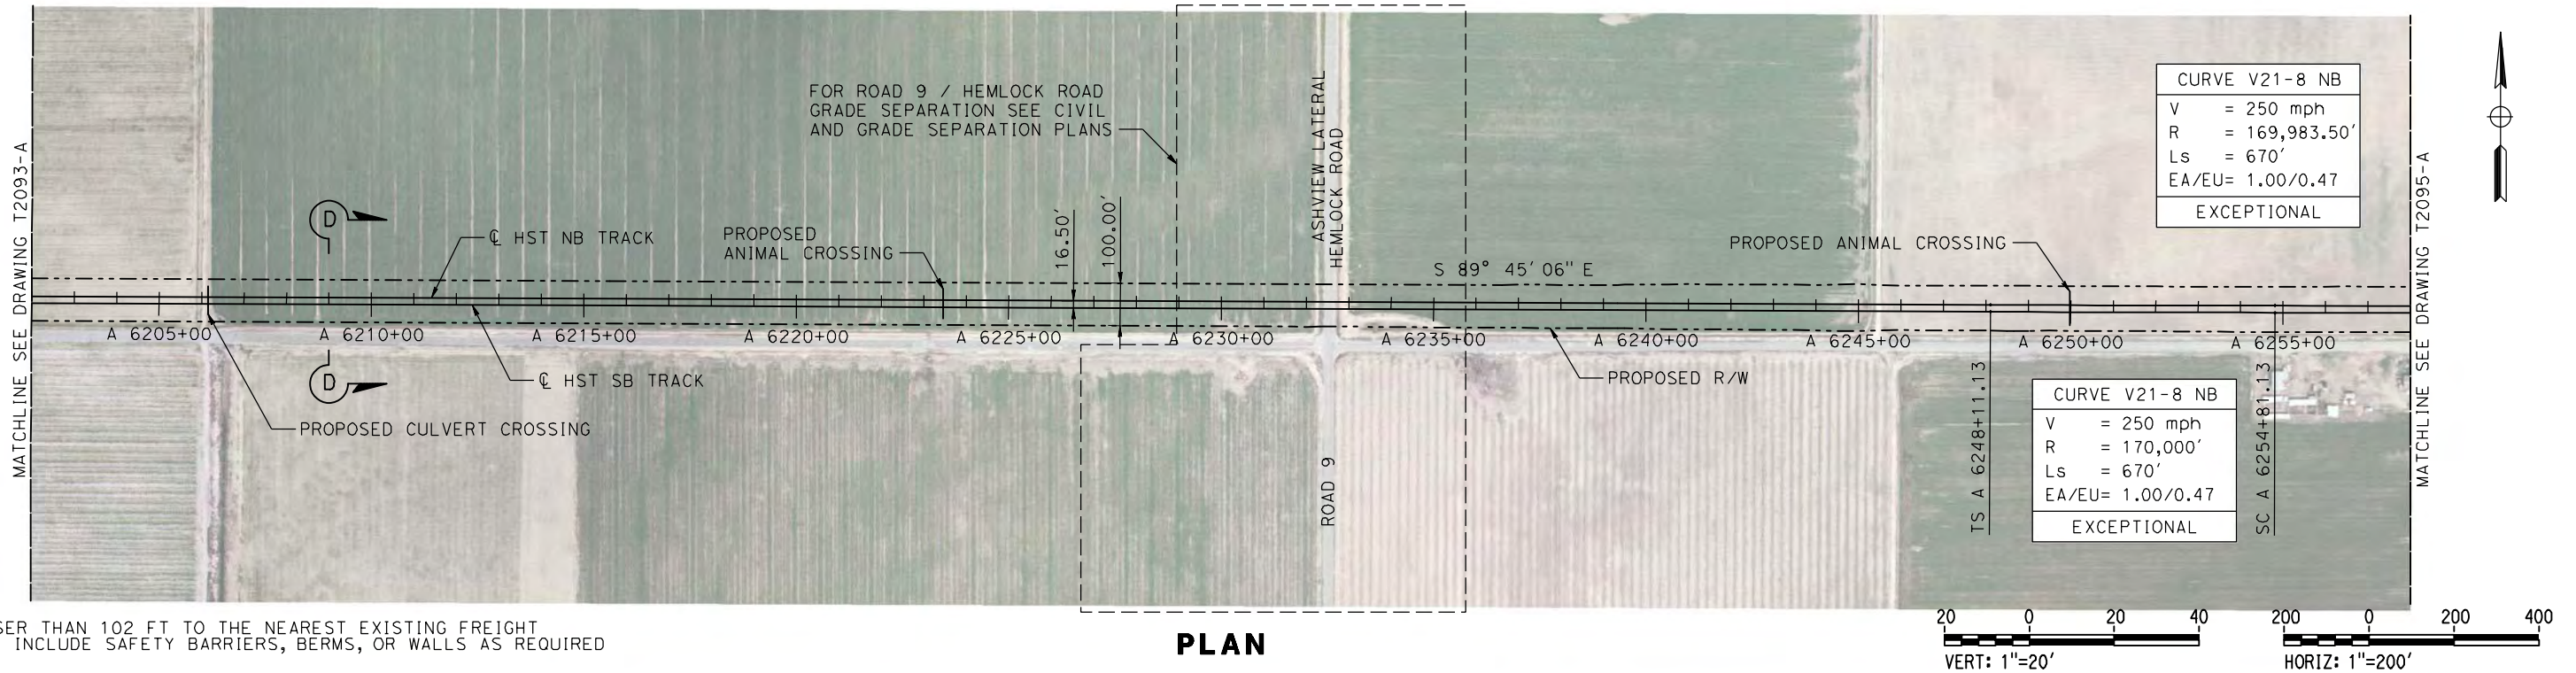
						DESIGNED BY A. GURA	<b>15% DRAFT SUBMITTAL FOR INTERNAL USE ONLY</b>			<b>CALIFORNIA HIGH-SPEED TRAIN PROJECT MERCED TO FRESNO</b>  HYBRID AVENUE 21 TRACK PLAN AND PROFILE STA A 6146+00 TO STA A 6202+00	CONTRACT NO. HSR08-05
						DRAWN BY A. GURA					DRAWING NO. T2093-A
						CHECKED BY S. GOOLLA					SCALE AS SHOWN
						IN CHARGE D. WEMMER					SHEET NO.
REV	DATE	BY	CHK	APP	DESCRIPTION	DATE 4/15/2011	<b>NOT FOR CONSTRUCTION</b>				



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P0037225

MADERA COUNTY



REV	DATE	BY	CHK	APP	DESCRIPTION

DESIGNED BY  
**A. GURA**

DRAWN BY  
**A. GURA**

CHECKED BY  
**S. GOOLLA**

IN CHARGE  
**D. WEMMER**

DATE  
**4/15/2011**

**15% DRAFT  
SUBMITTAL  
FOR INTERNAL  
USE ONLY**

**NOT FOR  
CONSTRUCTION**



**CALIFORNIA HIGH-SPEED TRAIN PROJECT  
MERCED TO FRESNO**

HYBRID  
AVENUE 21  
TRACK PLAN AND PROFILE  
STA A 6202+00 TO STA A 6258+00

CONTRACT NO.  
**HSR08-05**

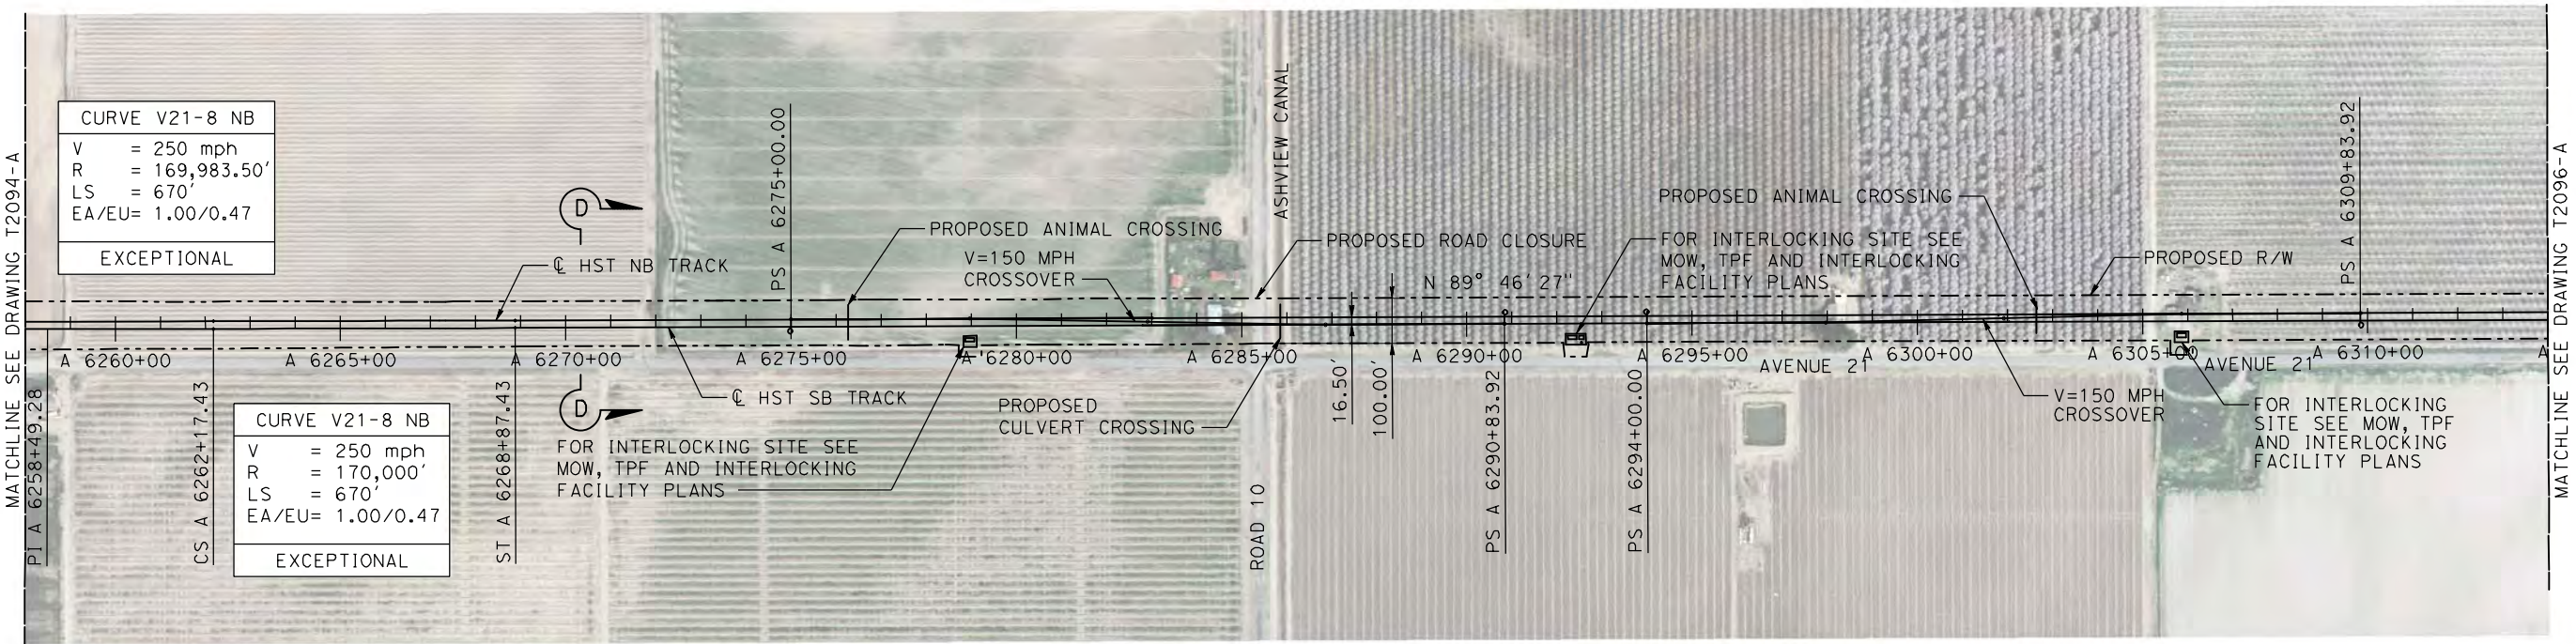
DRAWING NO.  
**T2094-A**

SCALE  
**AS SHOWN**

SHEET NO.

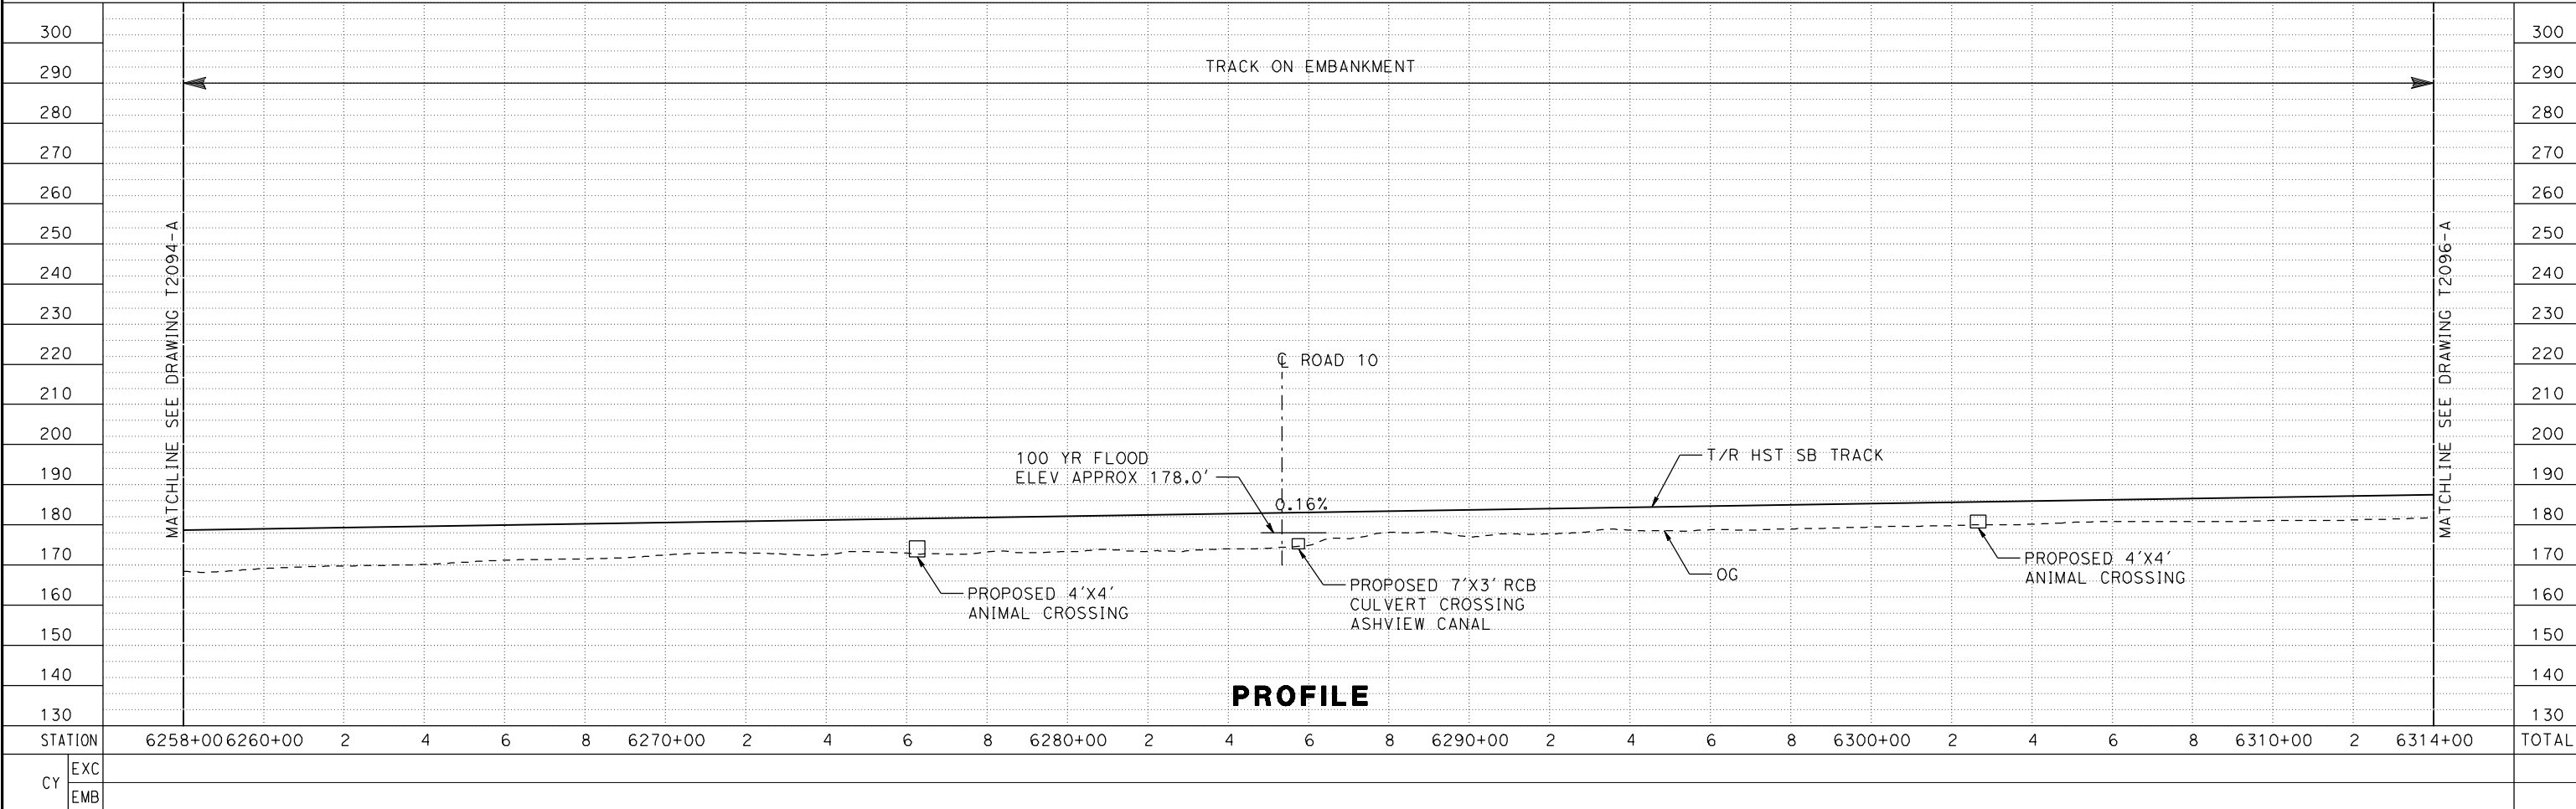


MADERA COUNTY



NOTE:  
TRACKS CLOSER THAN 102 FT TO THE NEAREST EXISTING FREIGHT  
TRACKS WILL INCLUDE SAFETY BARRIERS, BERMS, OR WALLS AS REQUIRED

PLAN



PROFILE

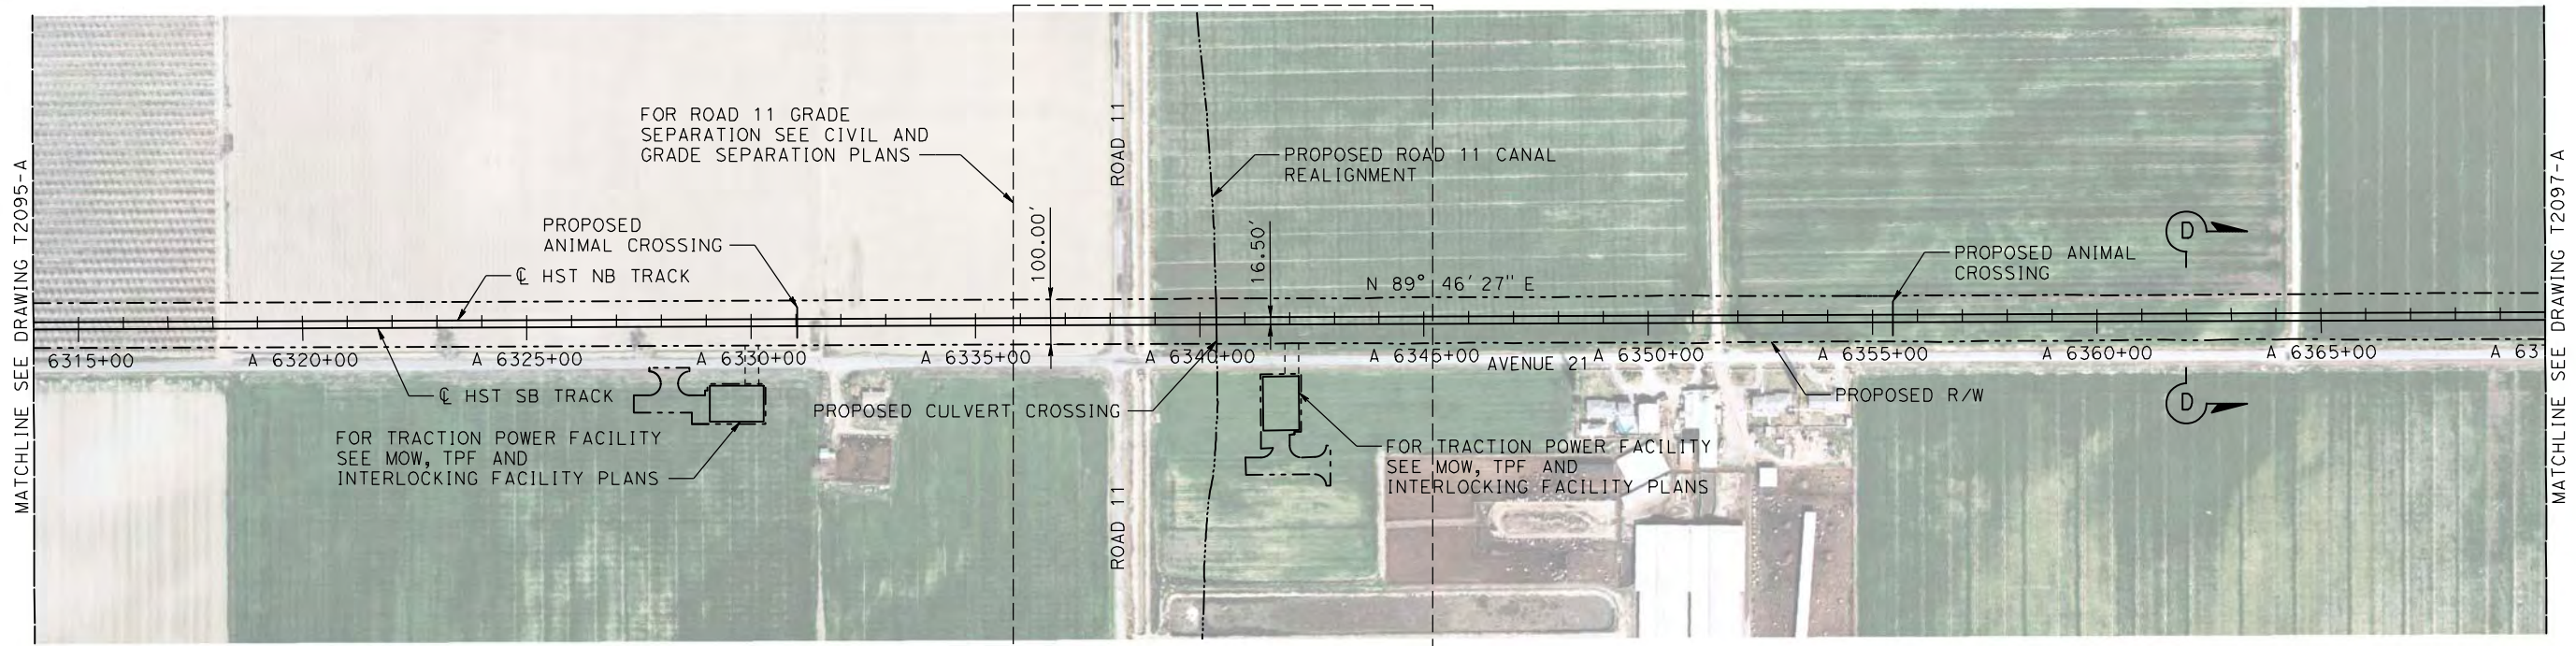
DESIGNED BY A. GURA						15% DRAFT SUBMITTAL FOR INTERNAL USE ONLY						NOT FOR CONSTRUCTION						CALIFORNIA HIGH-SPEED TRAIN PROJECT MERCED TO FRESNO						CONTRACT NO. HSR08-05					
DRAWN BY A. GURA						CHECKED BY S. GOOLLA						IN CHARGE D. WEMMER						HYBRID AVENUE 21 TRACK PLAN AND PROFILE STA A 6258+00 TO STA A 6314+00						DRAWING NO. T2095-A					
DATE 4/15/2011																								SCALE AS SHOWN					
																								SHEET NO.					
REV	DATE	BY	CHK	APP	DESCRIPTION																								



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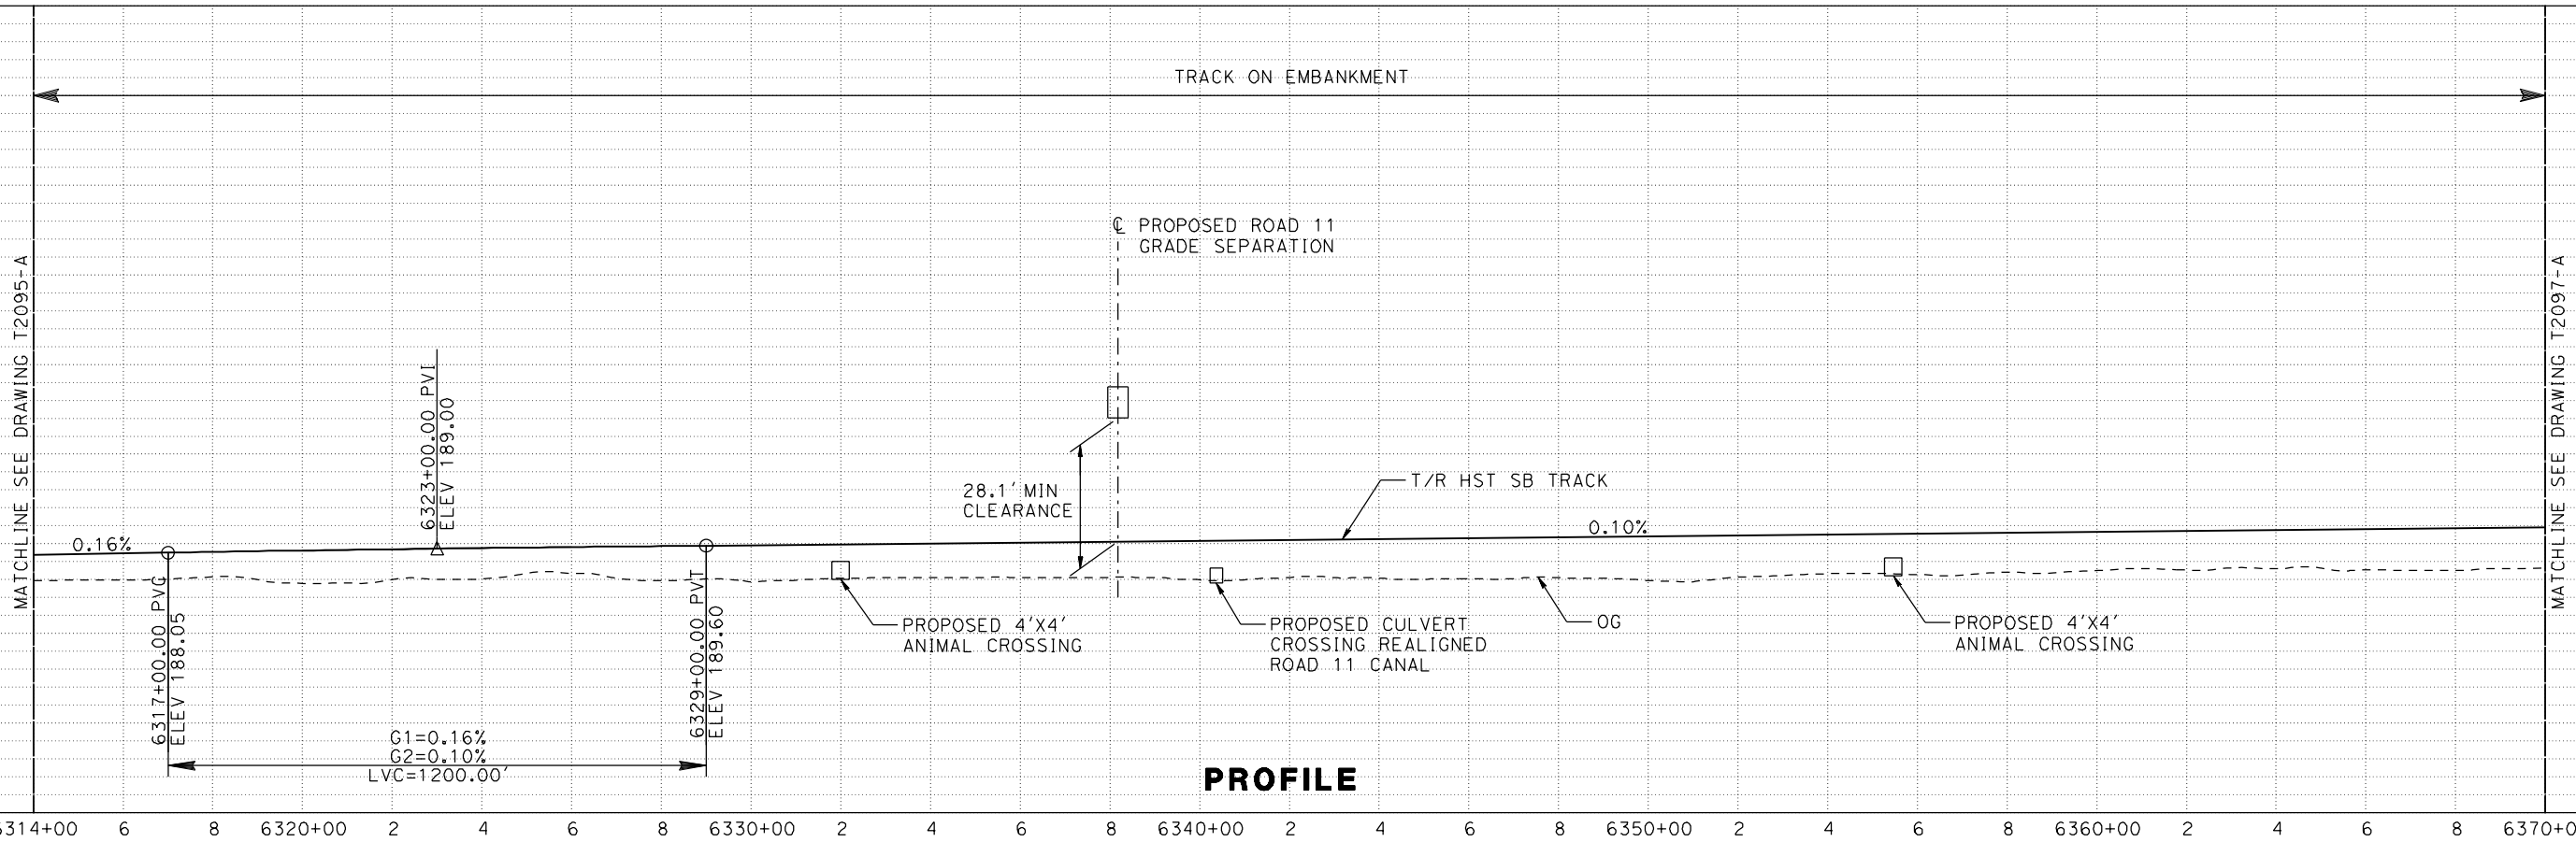
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# MADERA COUNTY



NOTE:  
TRACKS CLOSER THAN 102 FT TO THE NEAREST EXISTING FREIGHT  
TRACKS WILL INCLUDE SAFETY BARRIERS, BERMS, OR WALLS AS REQUIRED

PLAN



PROFILE

STATION	6314+00	6	8	6320+00	2	4	6	8	6330+00	2	4	6	8	6340+00	2	4	6	8	6350+00	2	4	6	8	6360+00	2	4	6	8	6370+00	TOTAL
EXC																														
EMB																														

REV	DATE	BY	CHK	APP	DESCRIPTION

DESIGNED BY  
**A. GURA**  
DRAWN BY  
**A. GURA**  
CHECKED BY  
**S. GOOLLA**  
IN CHARGE  
**D. WEMMER**  
DATE  
**4/15/2011**

**15% DRAFT  
SUBMITTAL  
FOR INTERNAL  
USE ONLY**

**NOT FOR  
CONSTRUCTION**



**CALIFORNIA HIGH-SPEED TRAIN PROJECT  
MERCED TO FRESNO**

HYBRID  
AVENUE 21  
TRACK PLAN AND PROFILE  
STA A 6314+00 TO STA A 6370+00

CONTRACT NO.  
**HSR08-05**

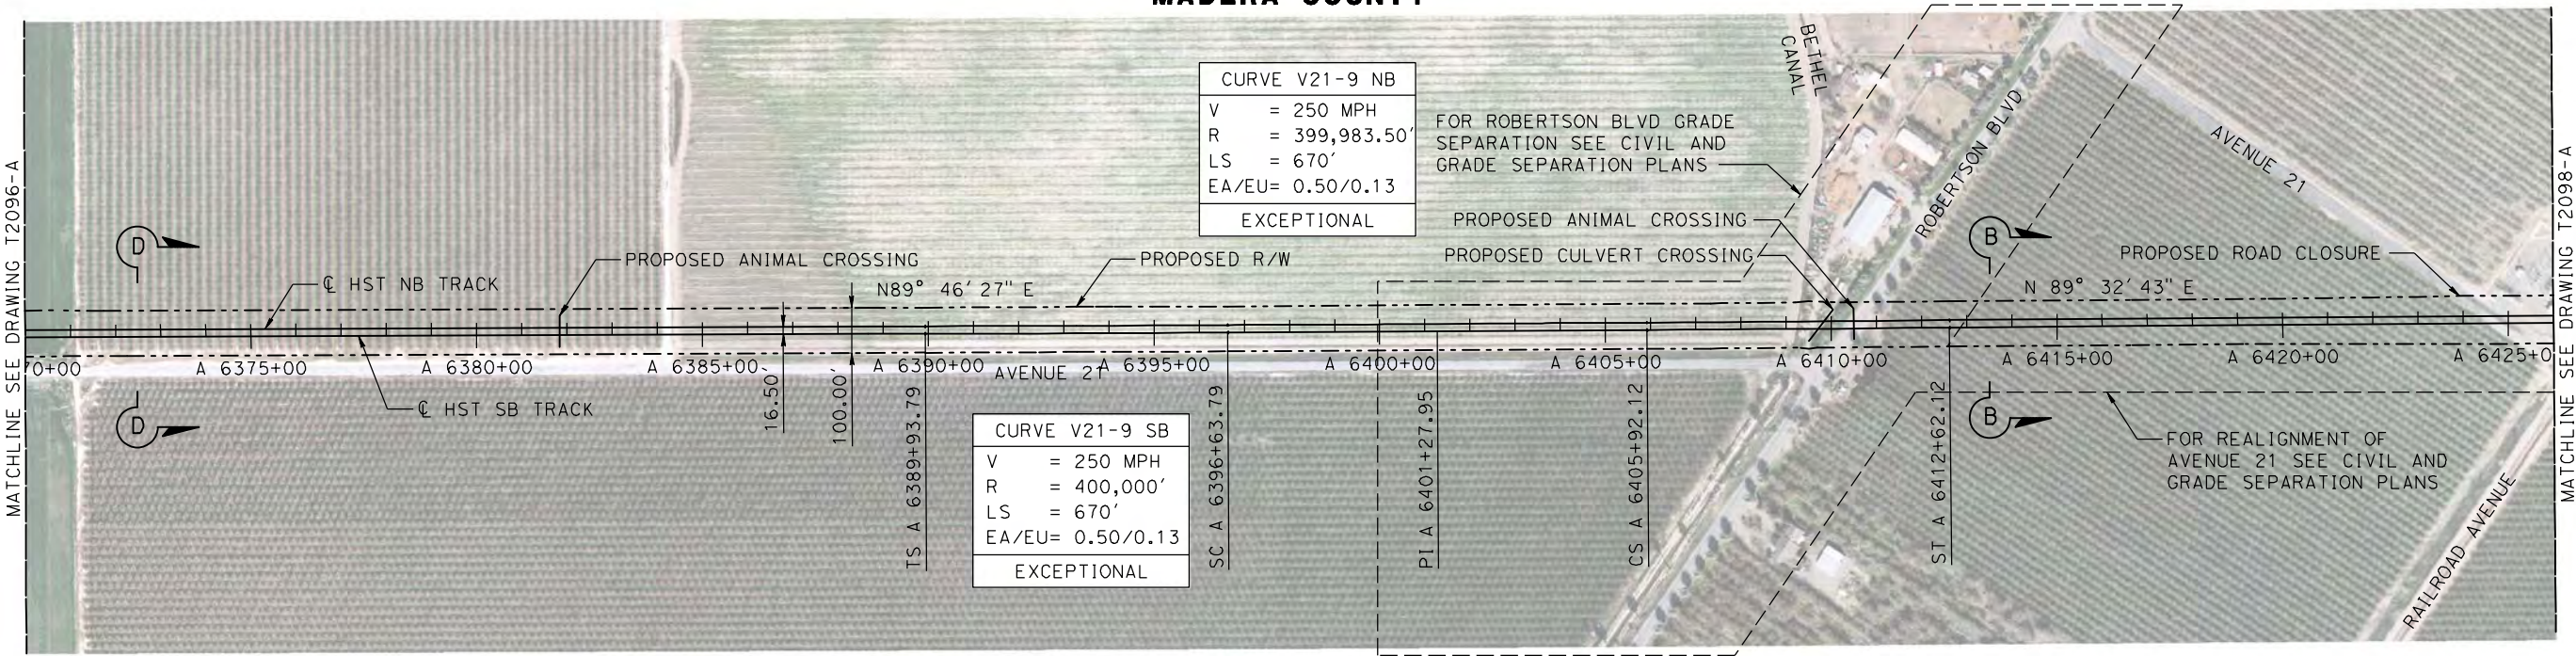
DRAWING NO.  
**T2096-A**

SCALE  
**AS SHOWN**

SHEET NO.

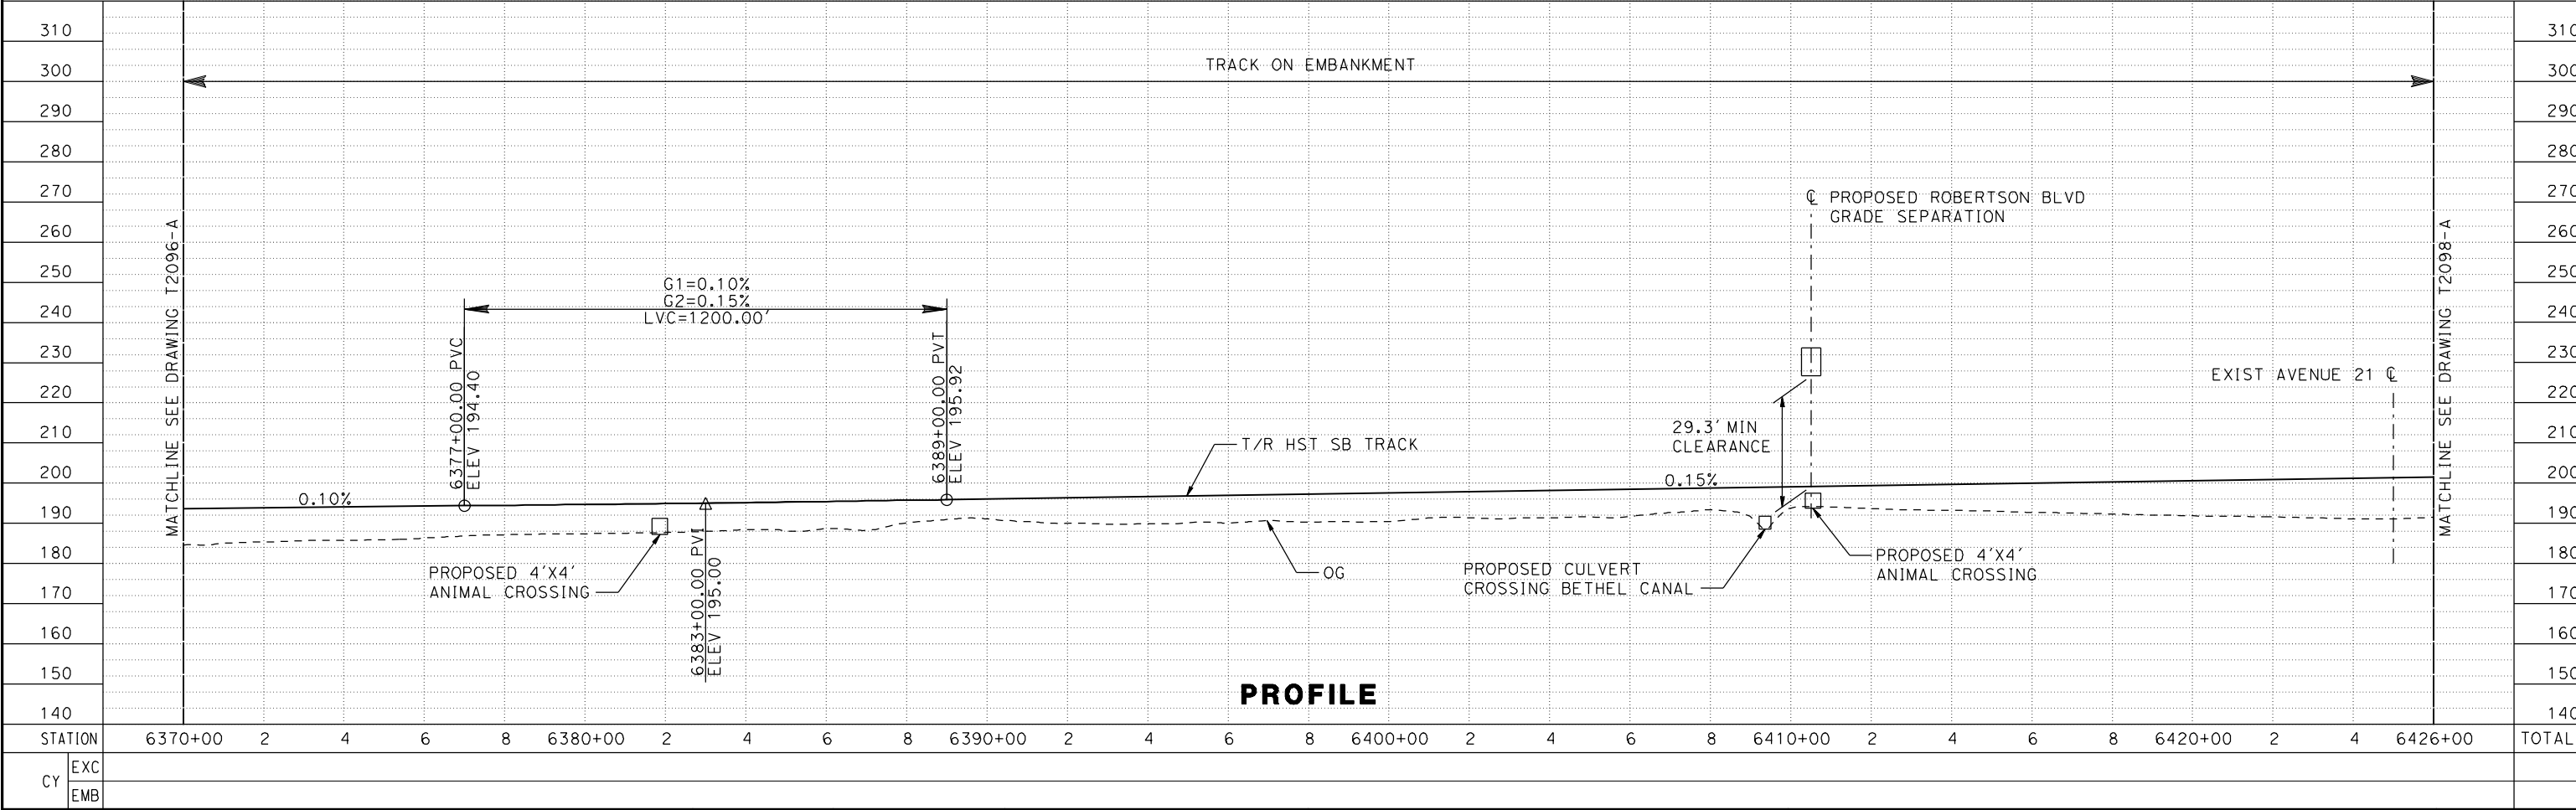
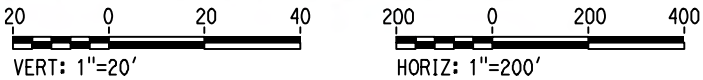


MADERA COUNTY



NOTE:  
TRACKS CLOSER THAN 102 FT TO THE NEAREST EXISTING FREIGHT  
TRACKS WILL INCLUDE SAFETY BARRIERS, BERMS, OR WALLS AS REQUIRED

PLAN

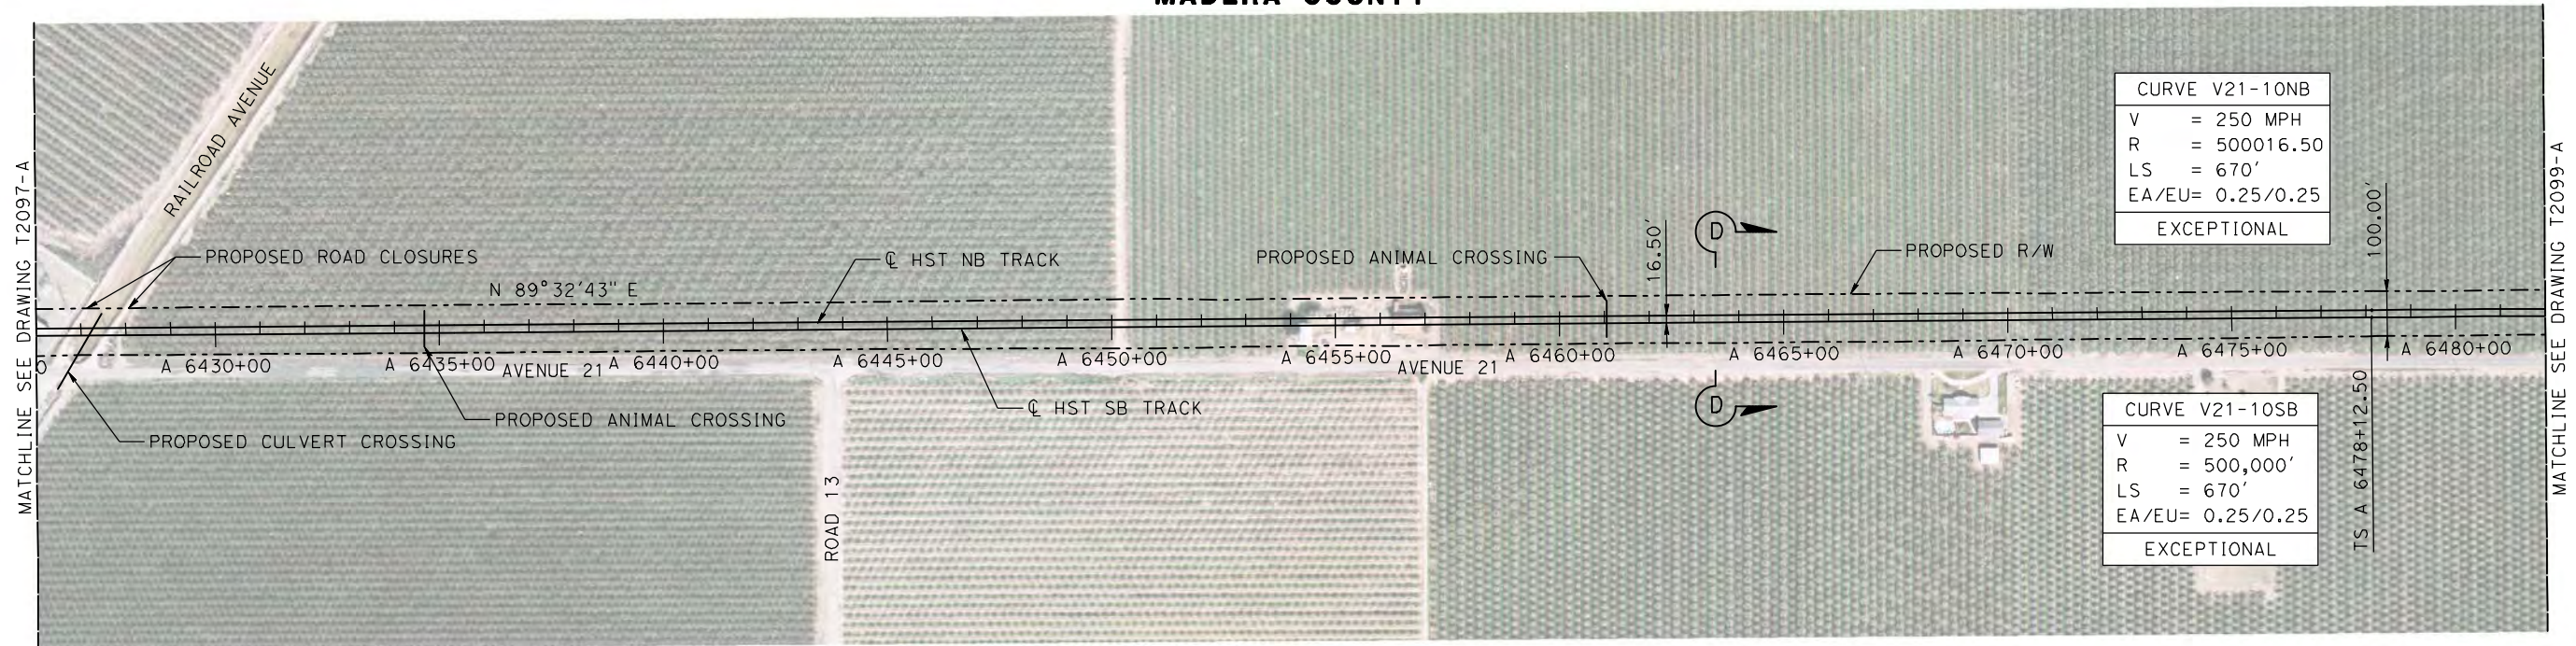


PROFILE

DESIGNED BY A. GURA						15% DRAFT SUBMITTAL FOR INTERNAL USE ONLY						NOT FOR CONSTRUCTION						CALIFORNIA HIGH-SPEED TRAIN PROJECT MERCED TO FRESNO						CONTRACT NO. HSR08-05					
DRAWN BY A. GURA						PARSONS						CALIFORNIA HIGH-SPEED RAIL AUTHORITY						HYBRID AVENUE 21 TRACK PLAN AND PROFILE STA A 6370+00 TO STA A 6426+00						DRAWING NO. T2097-A					
CHECKED BY S. GOOLLA						IN CHARGE D. WEMMER						DATE 4/15/2011						SCALE AS SHOWN						SHEET NO.					
REVISIONS						REV						DATE						BY						CHK					
APP						DESCRIPTION																							

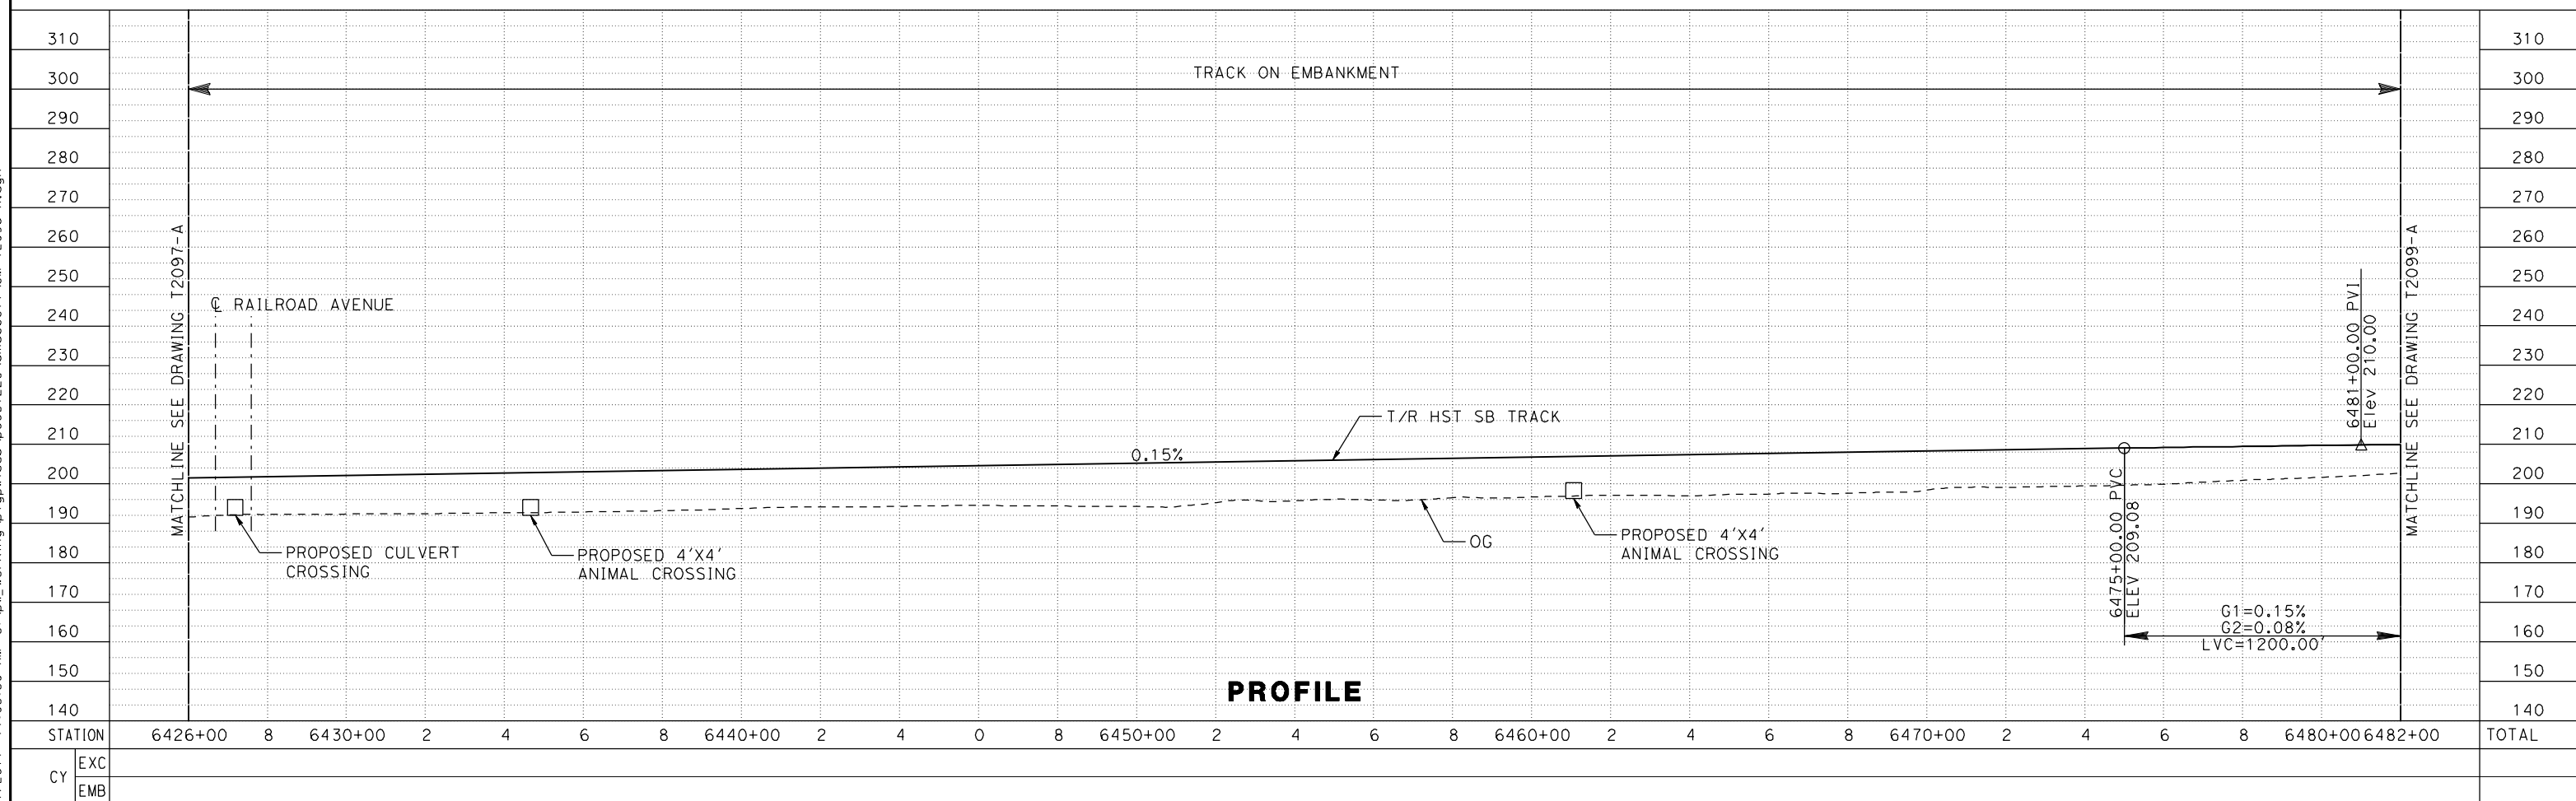


**MADERA COUNTY**



NOTE:  
TRACKS CLOSER THAN 102 FT TO THE NEAREST EXISTING FREIGHT  
TRACKS WILL INCLUDE SAFETY BARRIERS, BERMS, OR WALLS AS REQUIRED

## PLAN

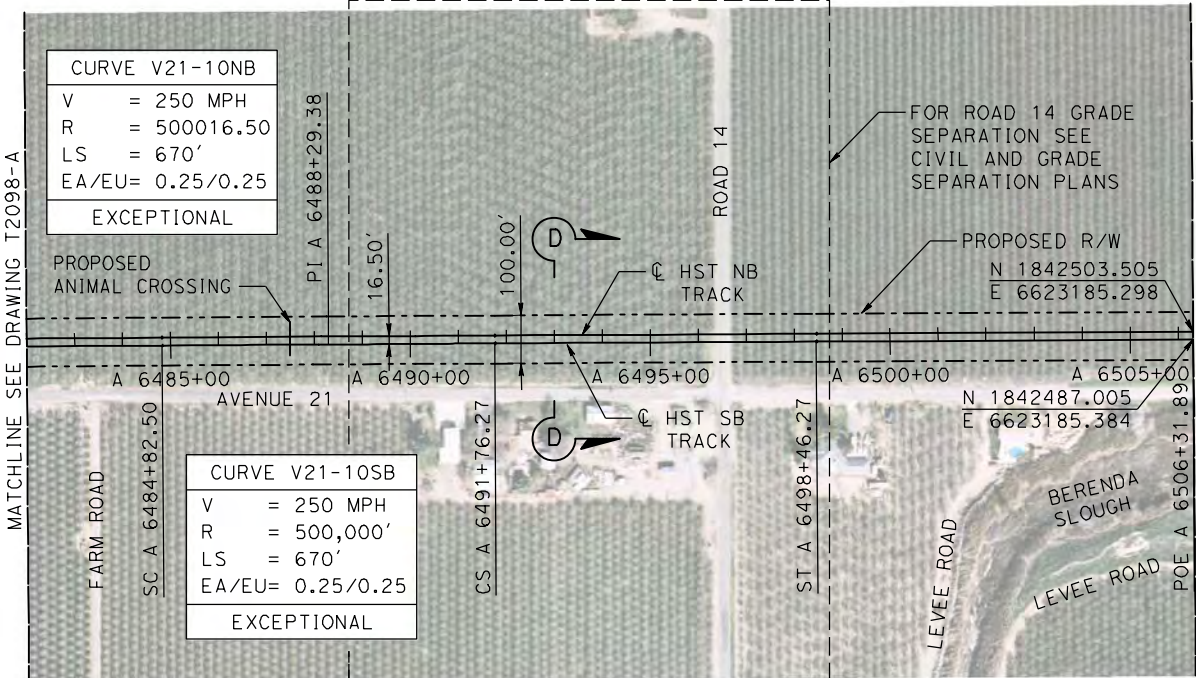


# PROFILE

						DESIGNED BY A. GURA	<b>15% DRAFT SUBMITTAL FOR INTERNAL USE ONLY</b>  <b>NOT FOR CONSTRUCTION</b>	 <b>PARSONS</b>  	<b>CALIFORNIA HIGH-SPEED TRAIN PROJECT MERCED TO FRESNO</b>  HYBRID AVENUE 21 TRACK PLAN AND PROFILE STA A 6426+00 TO STA A 6482+00	CONTRACT NO. HSR08-05
						DRAWN BY A. GURA				DRAWING NO. T2098-A
						CHECKED BY S. GOOLLA				SCALE AS SHOWN
						IN CHARGE D. WEMMER				SHEET NO.
REV	DATE	BY	CHK	APP	DESCRIPTION	DATE 4/15/2011				



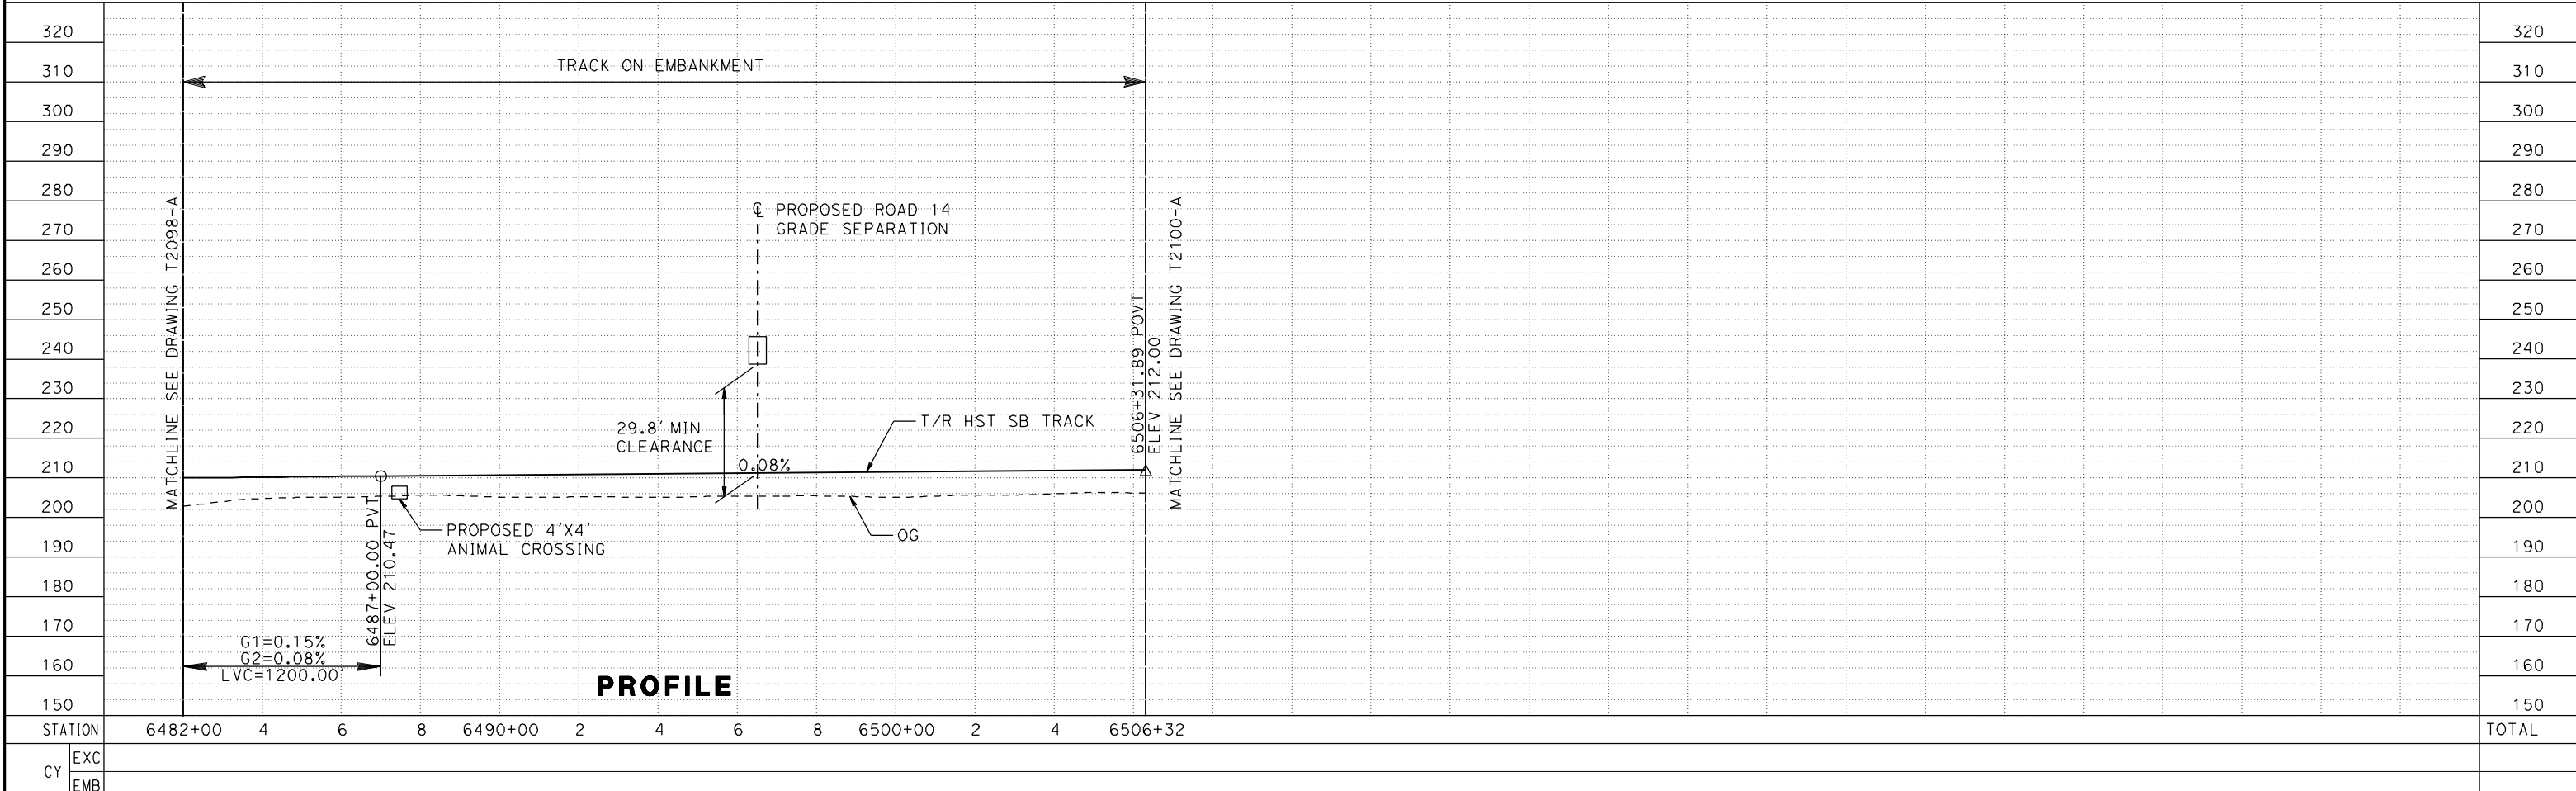
# MADERA COUNTY



NOTE:  
TRACKS CLOSER THAN 102 FT TO THE NEAREST EXISTING FREIGHT  
TRACKS WILL INCLUDE SAFETY BARRIERS, BERMS, OR WALLS AS REQUIRED



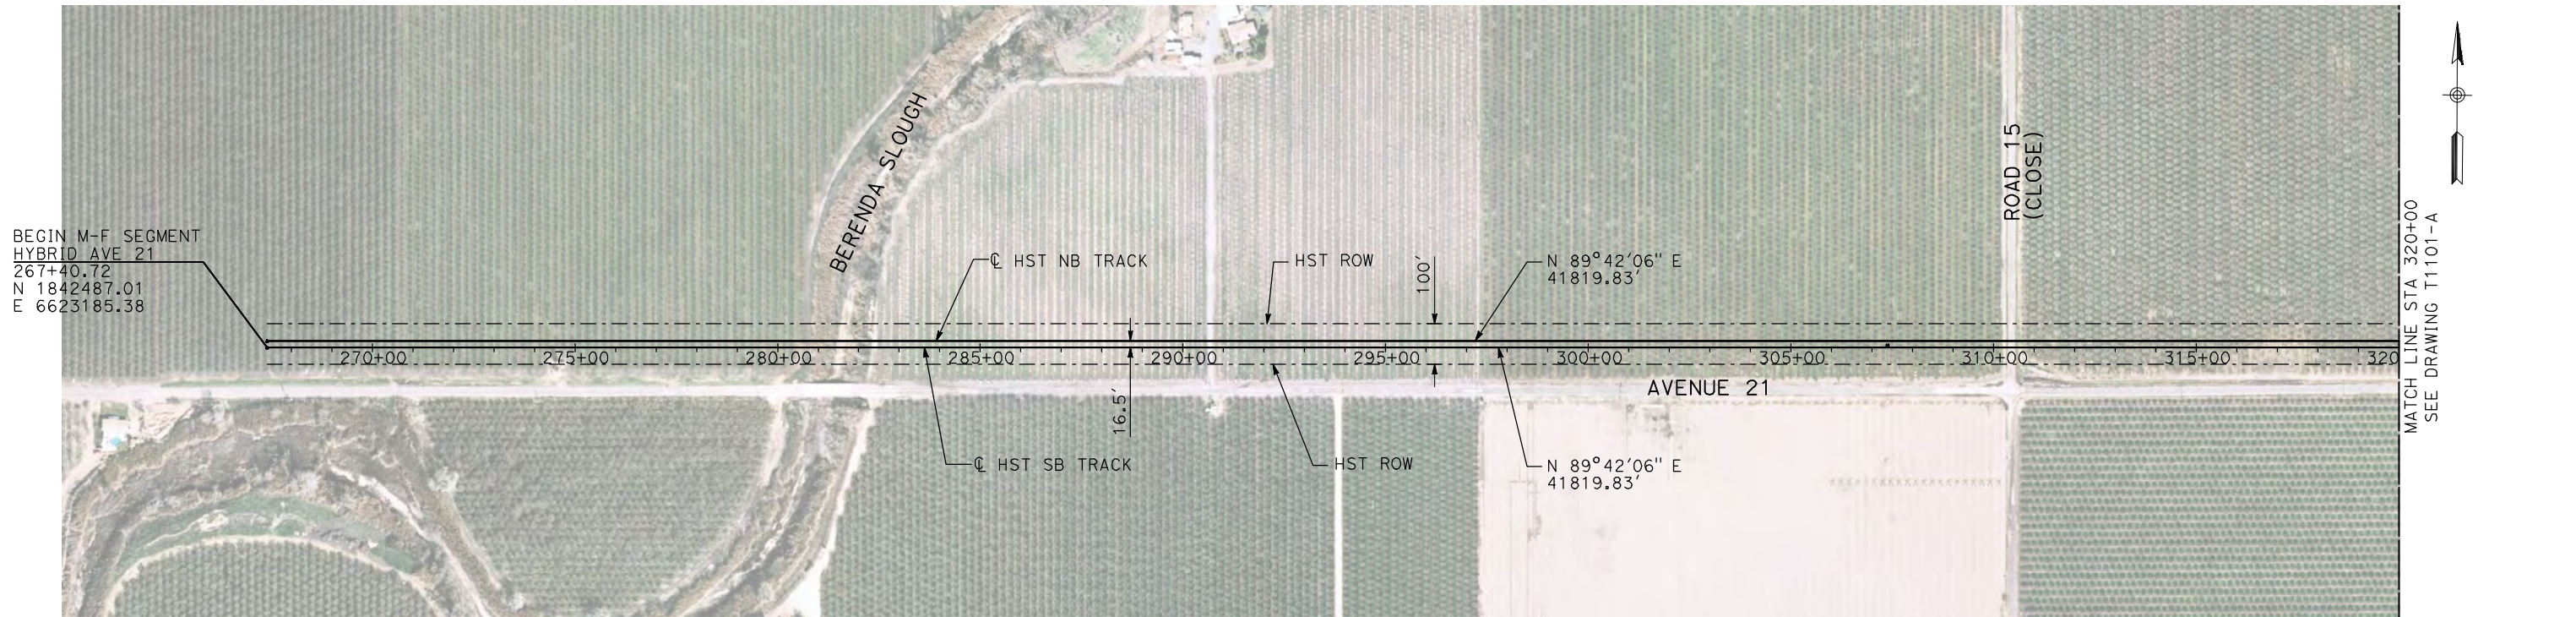
## PLAN



						DESIGNED BY A. GURA	<b>15% DRAFT SUBMITTAL FOR INTERNAL USE ONLY</b>  <b>NOT FOR CONSTRUCTION</b>			<b>CALIFORNIA HIGH-SPEED TRAIN PROJECT MERCED TO FRESNO</b>  HYBRID AVENUE 21 TRACK PLAN AND PROFILE STA A 6482+00 TO STA A 6506+32	CONTRACT NO. HSR08-05
						DRAWN BY A. GURA					DRAWING NO. T2099-A
						CHECKED BY S. GOOLLA					SCALE AS SHOWN
						IN CHARGE D. WEMMER					SHEET NO.
REV	DATE	BY	CHK	APP	DESCRIPTION	DATE 4/15/2011					

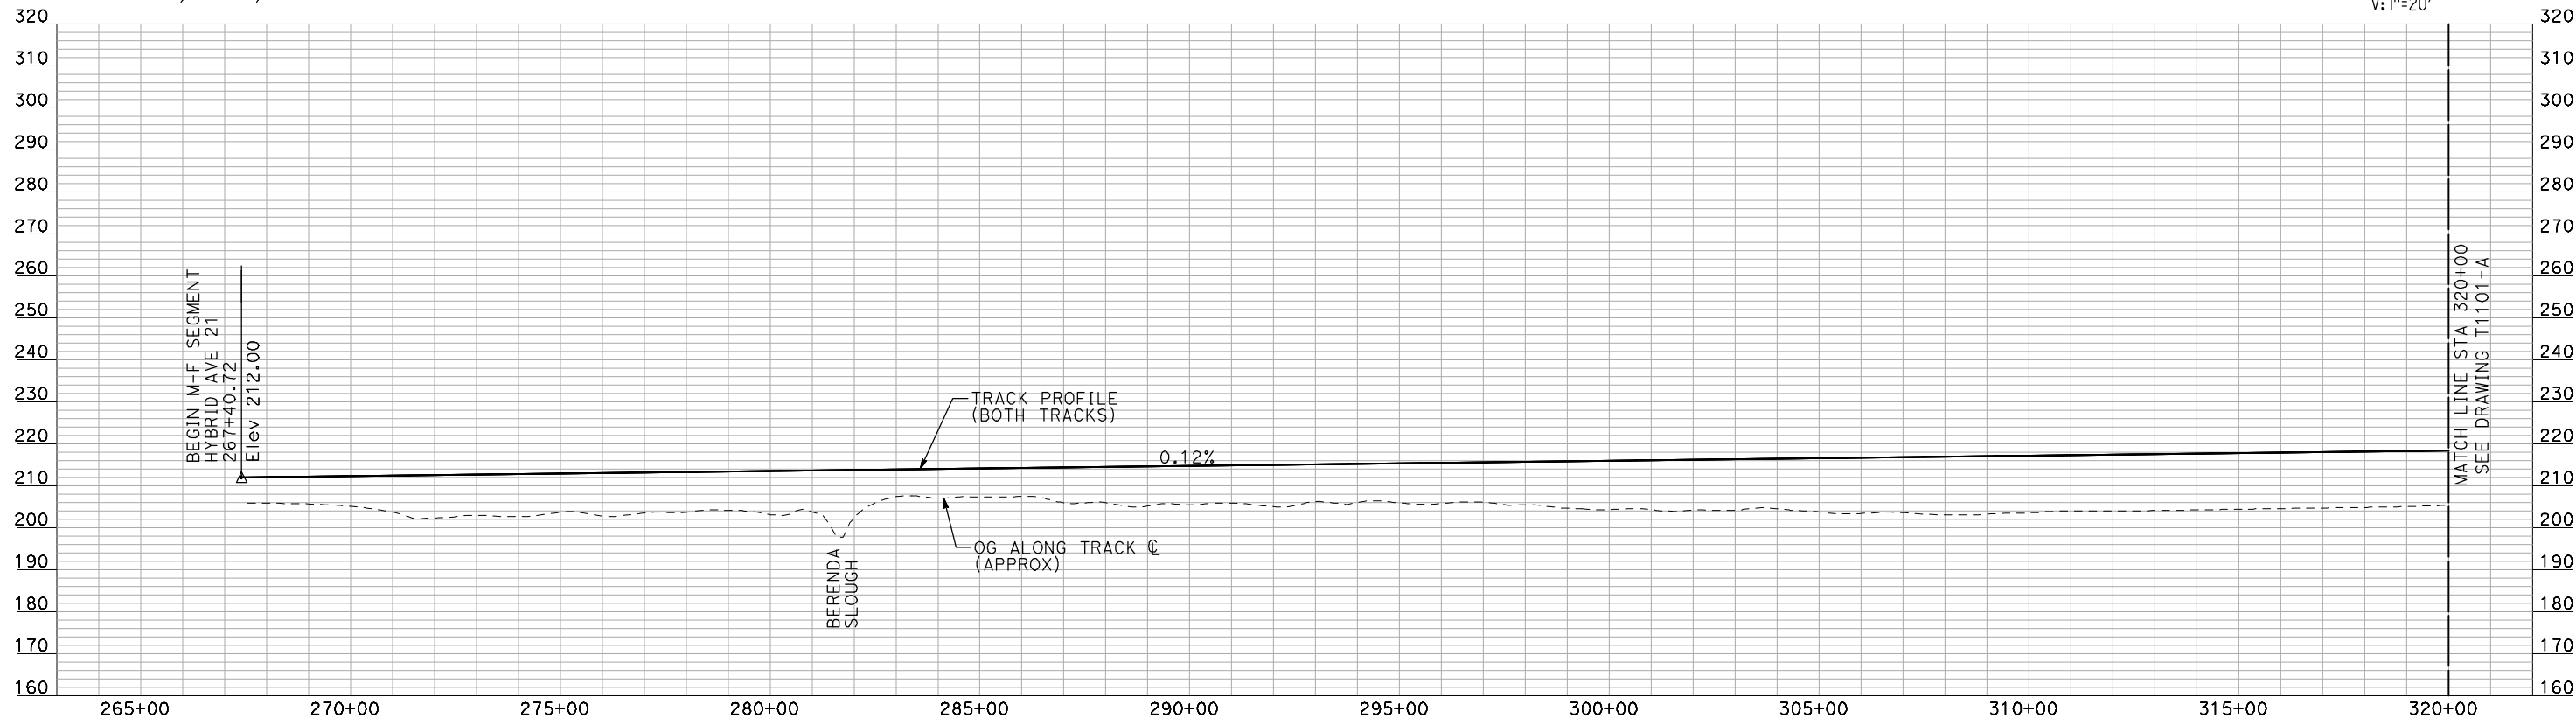
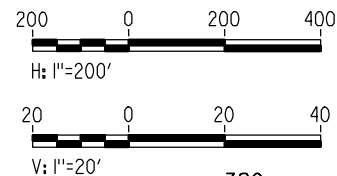


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- NOTES:
1. ALL UTILITIES SHOWN ARE EXISTING UTILITY LINES BASED ON RECORD DRAWINGS AND ARE SHOWN FOR INFORMATIONAL PURPOSES ONLY.
  2. TRACKS CLOSER THAN 102 FT TO THE NEAREST EXISTING FREIGHT TRACKS WILL INCLUDE SAFETY BARRIERS, BERMS, OR WALLS AS REQUIRED.

PLAN



PROFILE

"SEE T3000-T3017 DRAWINGS FOR  
TYPICAL SECTION LIMITS AND DETAILS"

REV	DATE	BY	CHK	APP	DESCRIPTION

DESIGNED BY A. SHIELDS
DRAWN BY H. SULLIVAN
CHECKED BY A. BOONE
IN CHARGE A. BOONE
DATE 07/20/2011

RECORD SET  
15% DESIGN  
SUBMITTAL

NOT FOR  
CONSTRUCTION



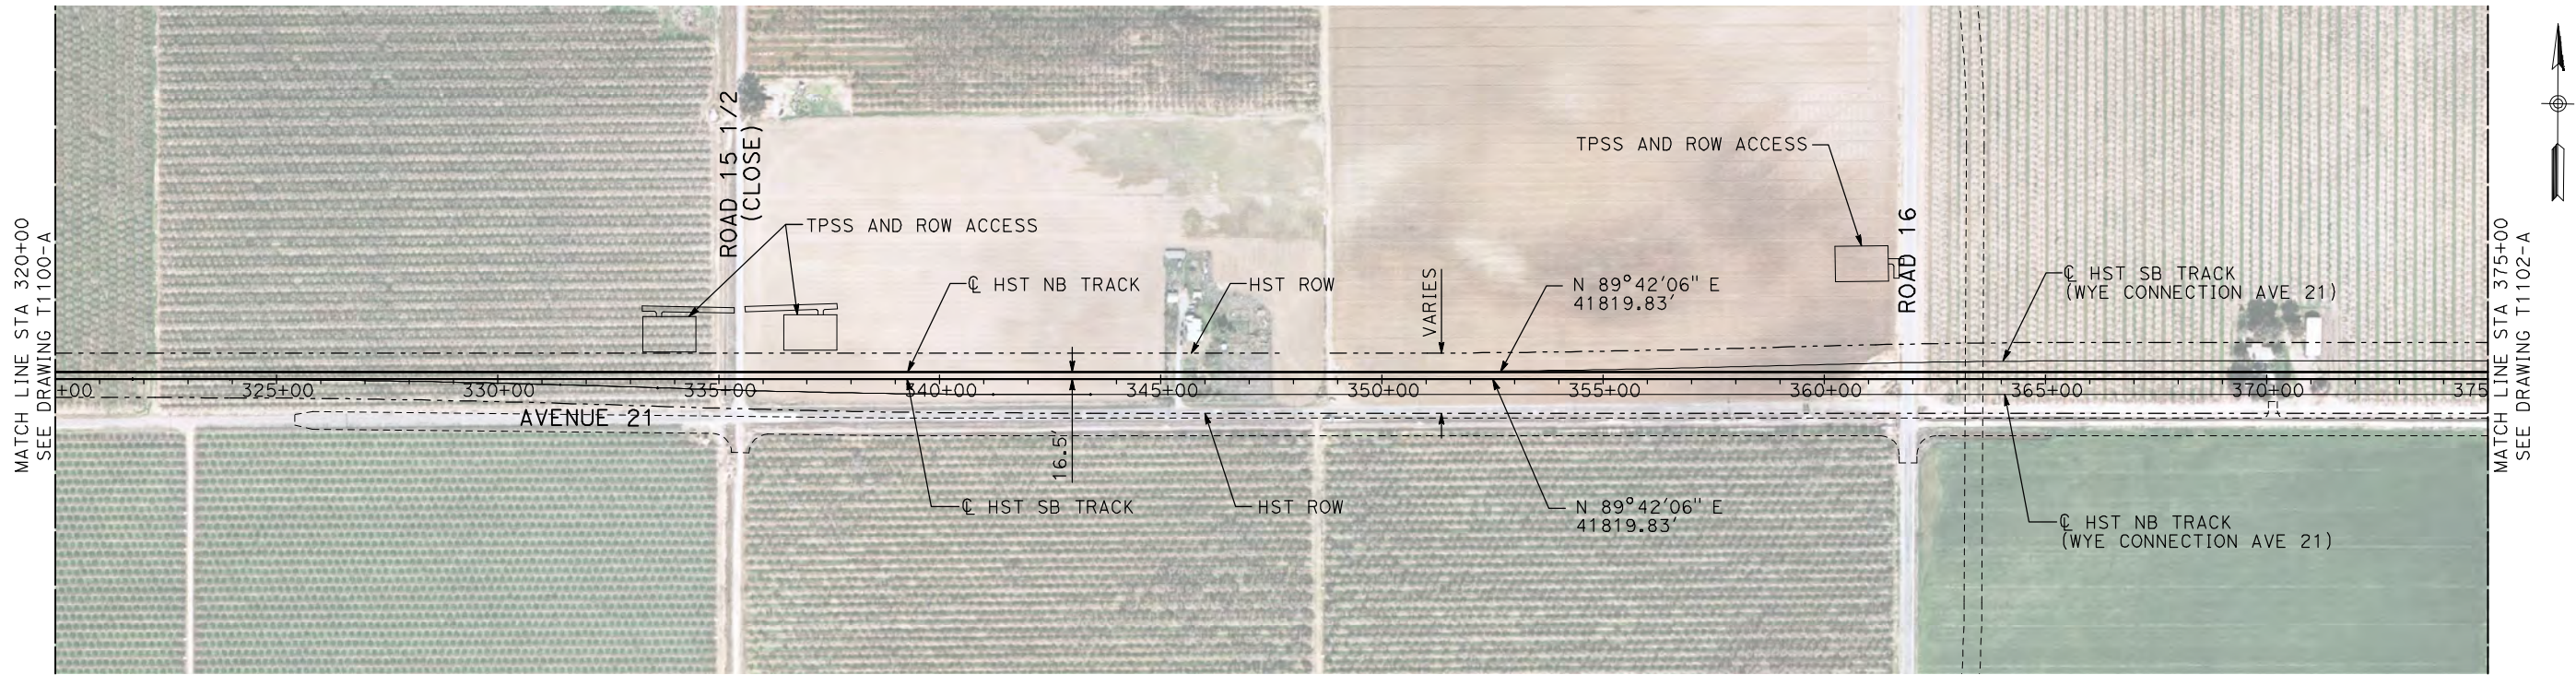
CALIFORNIA HIGH-SPEED TRAIN PROJECT  
MERCED TO FRESNO

HYBRID  
AVENUE 21  
PLAN AND PROFILE  
STA 267+40.72 TO STA 320+00

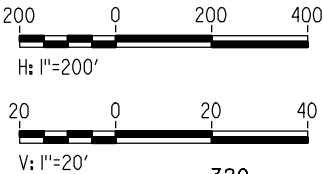
CONTRACT NO. HSR06-007
DRAWING NO. T1100-A
SCALE AS SHOWN
SHEET NO. ### OF ###



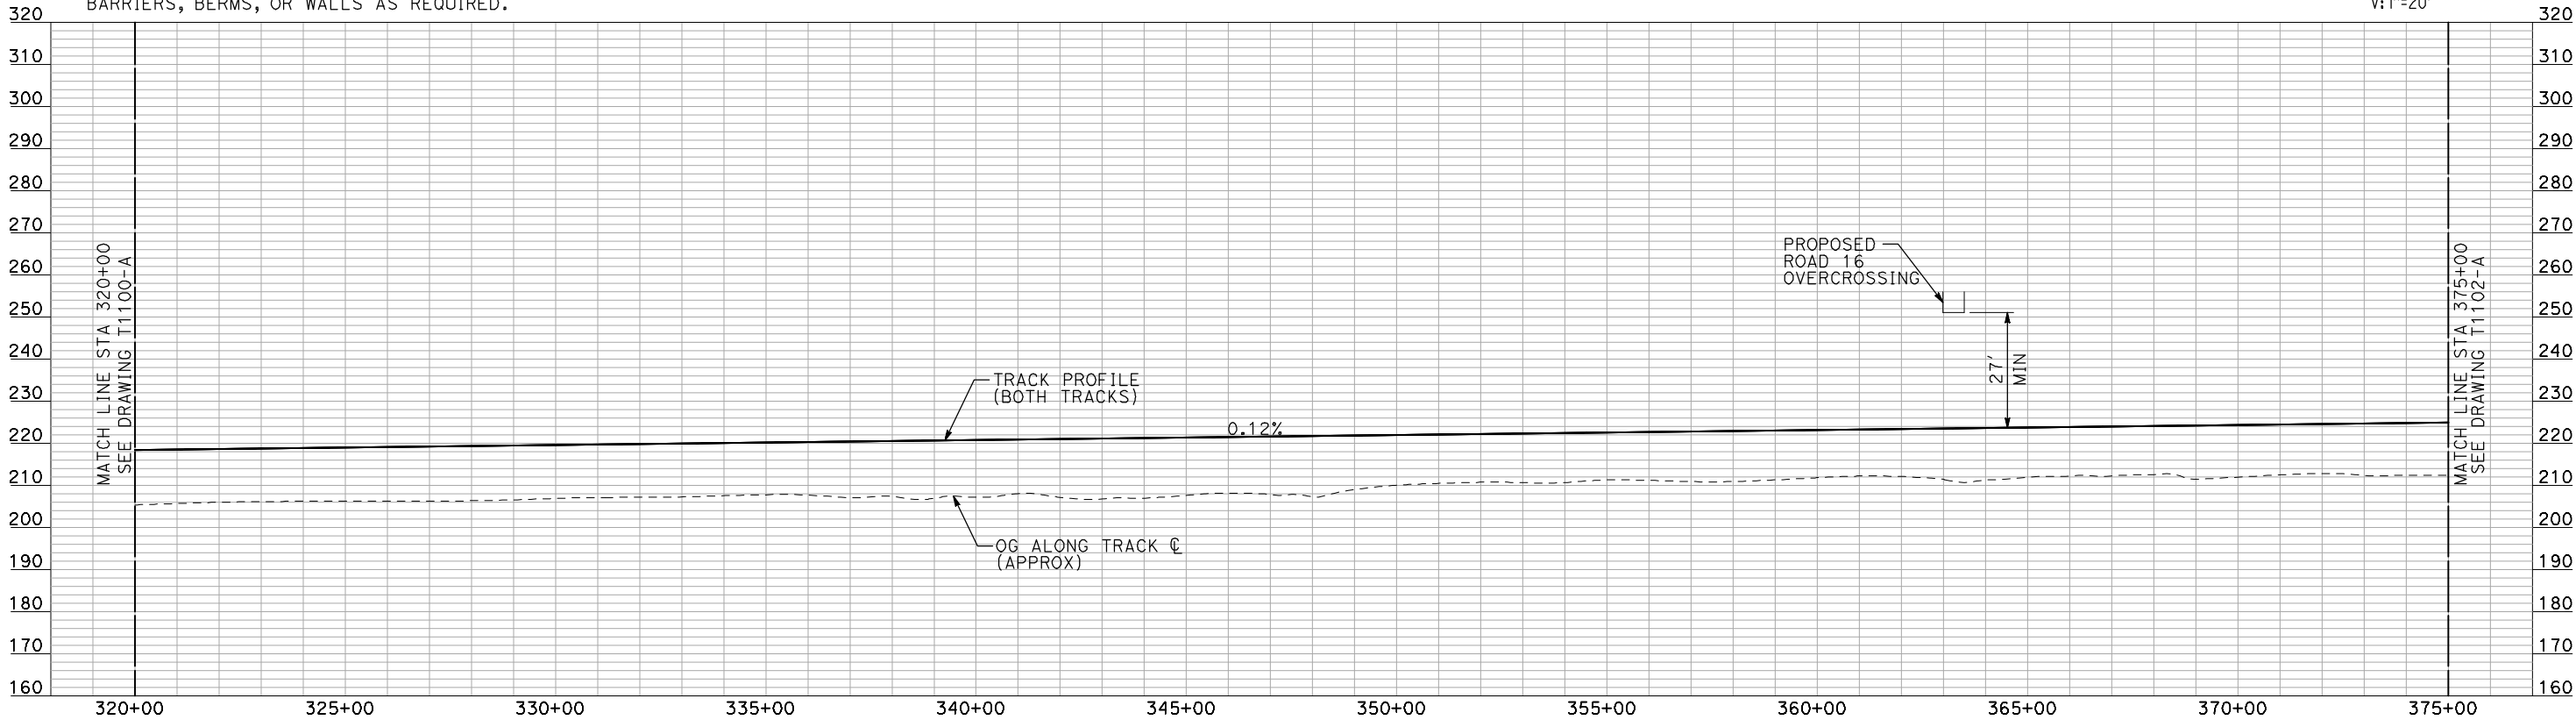
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PLAN



- NOTES:
1. ALL UTILITIES SHOWN ARE EXISTING UTILITY LINES BASED ON RECORD DRAWINGS AND ARE SHOWN FOR INFORMATIONAL PURPOSES ONLY.
  2. TRACKS CLOSER THAN 102 FT TO THE NEAREST EXISTING FREIGHT TRACKS WILL INCLUDE SAFETY BARRIERS, BERMS, OR WALLS AS REQUIRED.



PROFILE

"SEE T3000-T3017 DRAWINGS FOR  
TYPICAL SECTION LIMITS AND DETAILS"

REV	DATE	BY	CHK	APP	DESCRIPTION

DESIGNED BY A. SHIELDS
DRAWN BY H. SULLIVAN
CHECKED BY A. BOONE
IN CHARGE A. BOONE
DATE 07/20/2011

RECORD SET  
15% DESIGN  
SUBMITTAL

NOT FOR  
CONSTRUCTION



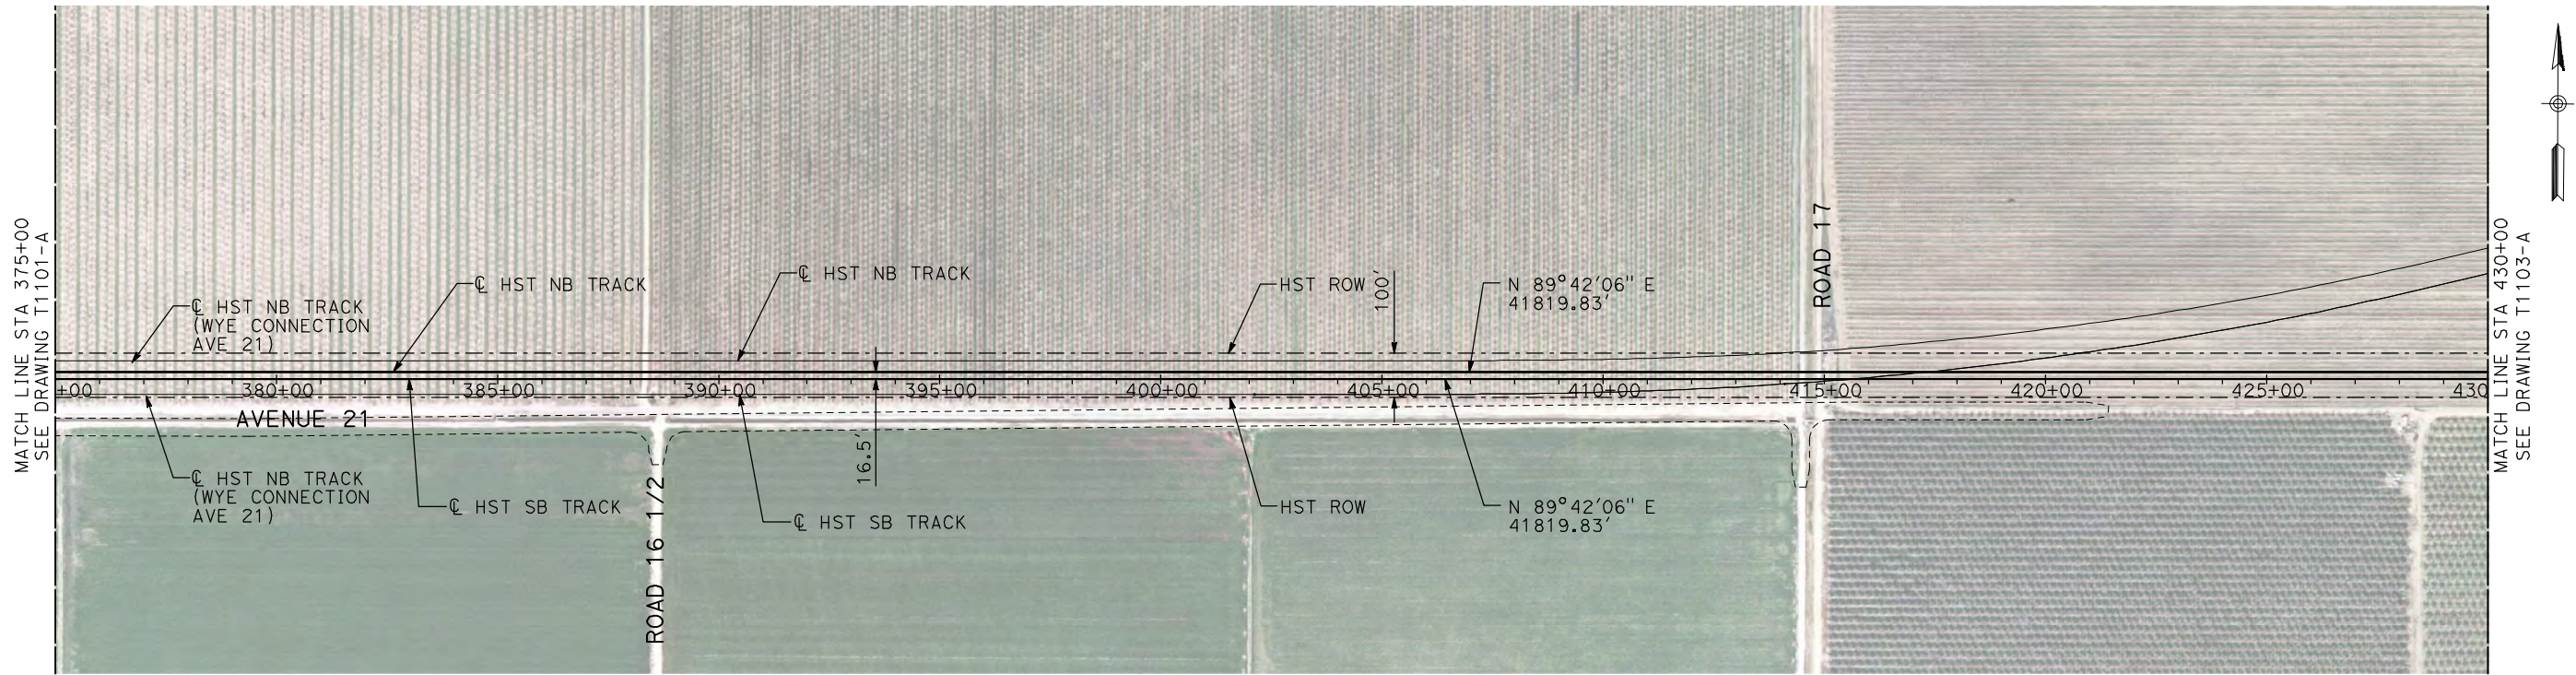
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MERCED TO FRESNO

HYBRID  
AVENUE 21  
PLAN AND PROFILE  
STA 320+00 TO STA 375+00

CONTRACT NO. HSR06-007
DRAWING NO. T1101-A
SCALE AS SHOWN
SHEET NO. ### OF ###

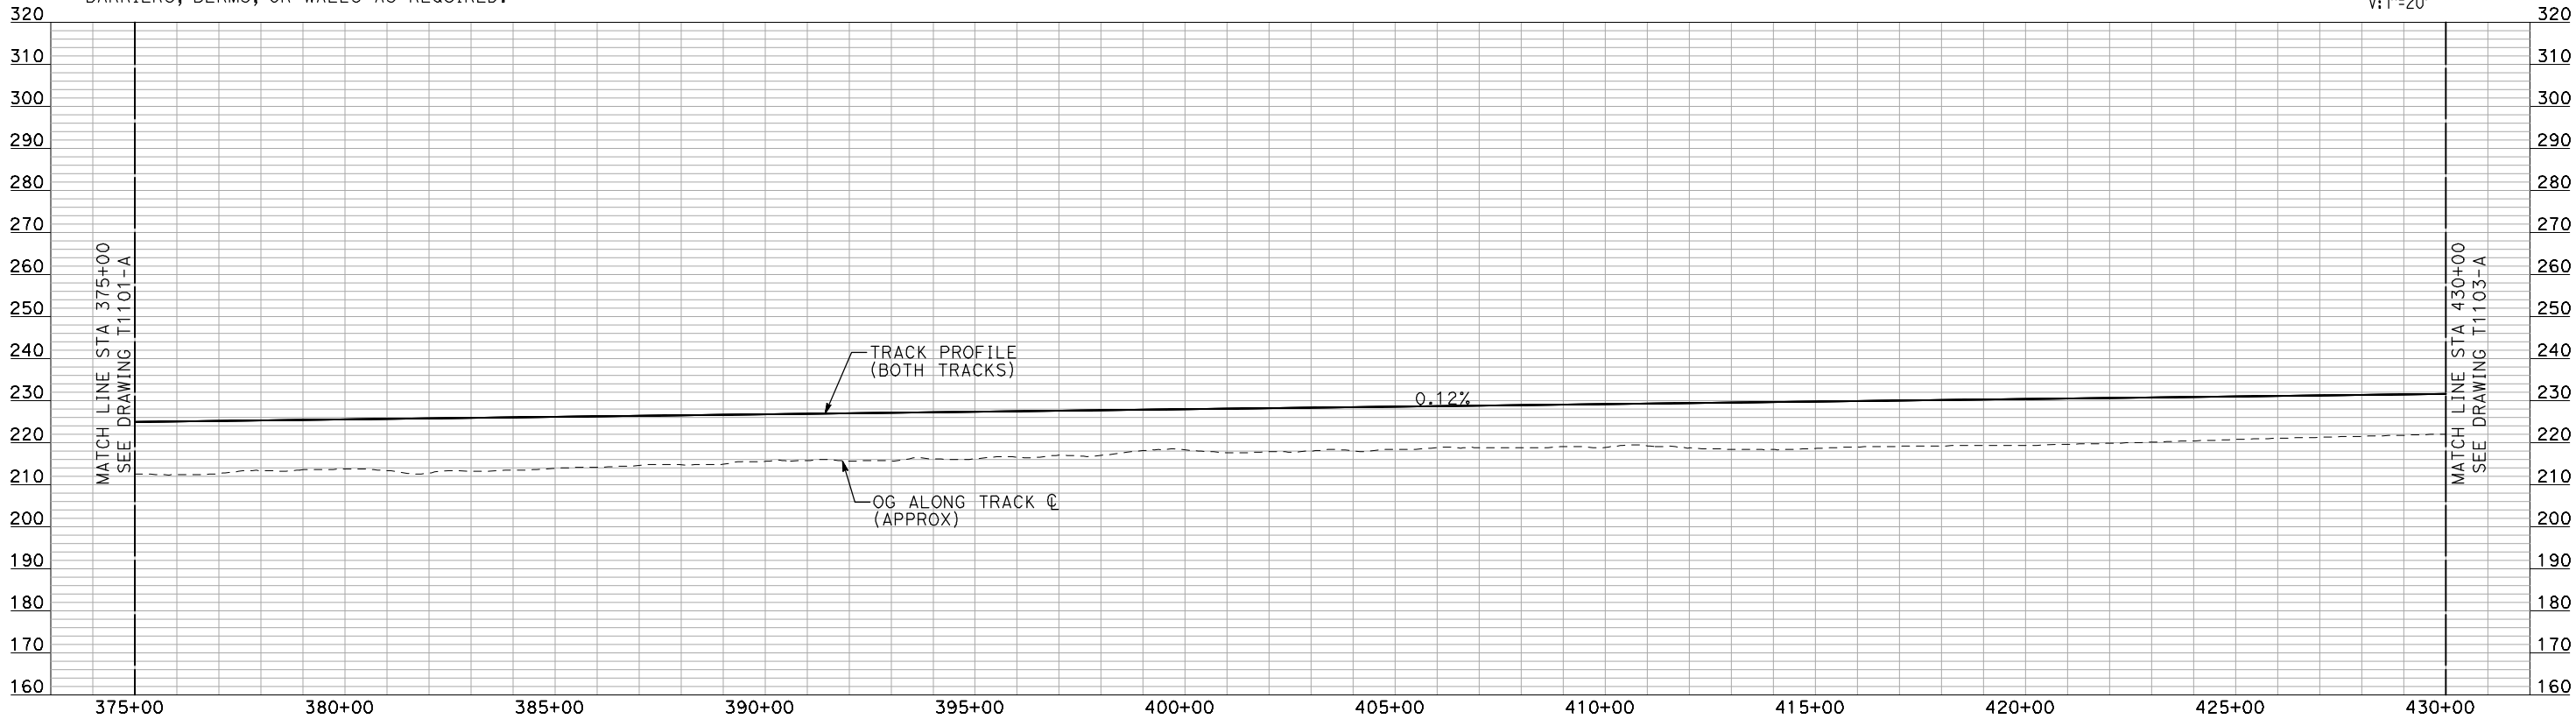
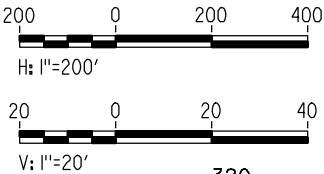


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- NOTES:
1. ALL UTILITIES SHOWN ARE EXISTING UTILITY LINES BASED ON RECORD DRAWINGS AND ARE SHOWN FOR INFORMATIONAL PURPOSES ONLY.
  2. TRACKS CLOSER THAN 102 FT TO THE NEAREST EXISTING FREIGHT TRACKS WILL INCLUDE SAFETY BARRIERS, BERMS, OR WALLS AS REQUIRED.

PLAN



PROFILE

"SEE T3000-T3017 DRAWINGS FOR  
TYPICAL SECTION LIMITS AND DETAILS"

REV	DATE	BY	CHK	APP	DESCRIPTION

DESIGNED BY A. SHIELDS
DRAWN BY H. SULLIVAN
CHECKED BY A. BOONE
IN CHARGE A. BOONE
DATE 07/20/2011

RECORD SET  
15% DESIGN  
SUBMITTAL

NOT FOR  
CONSTRUCTION



CALIFORNIA  
HIGH-SPEED RAIL AUTHORITY

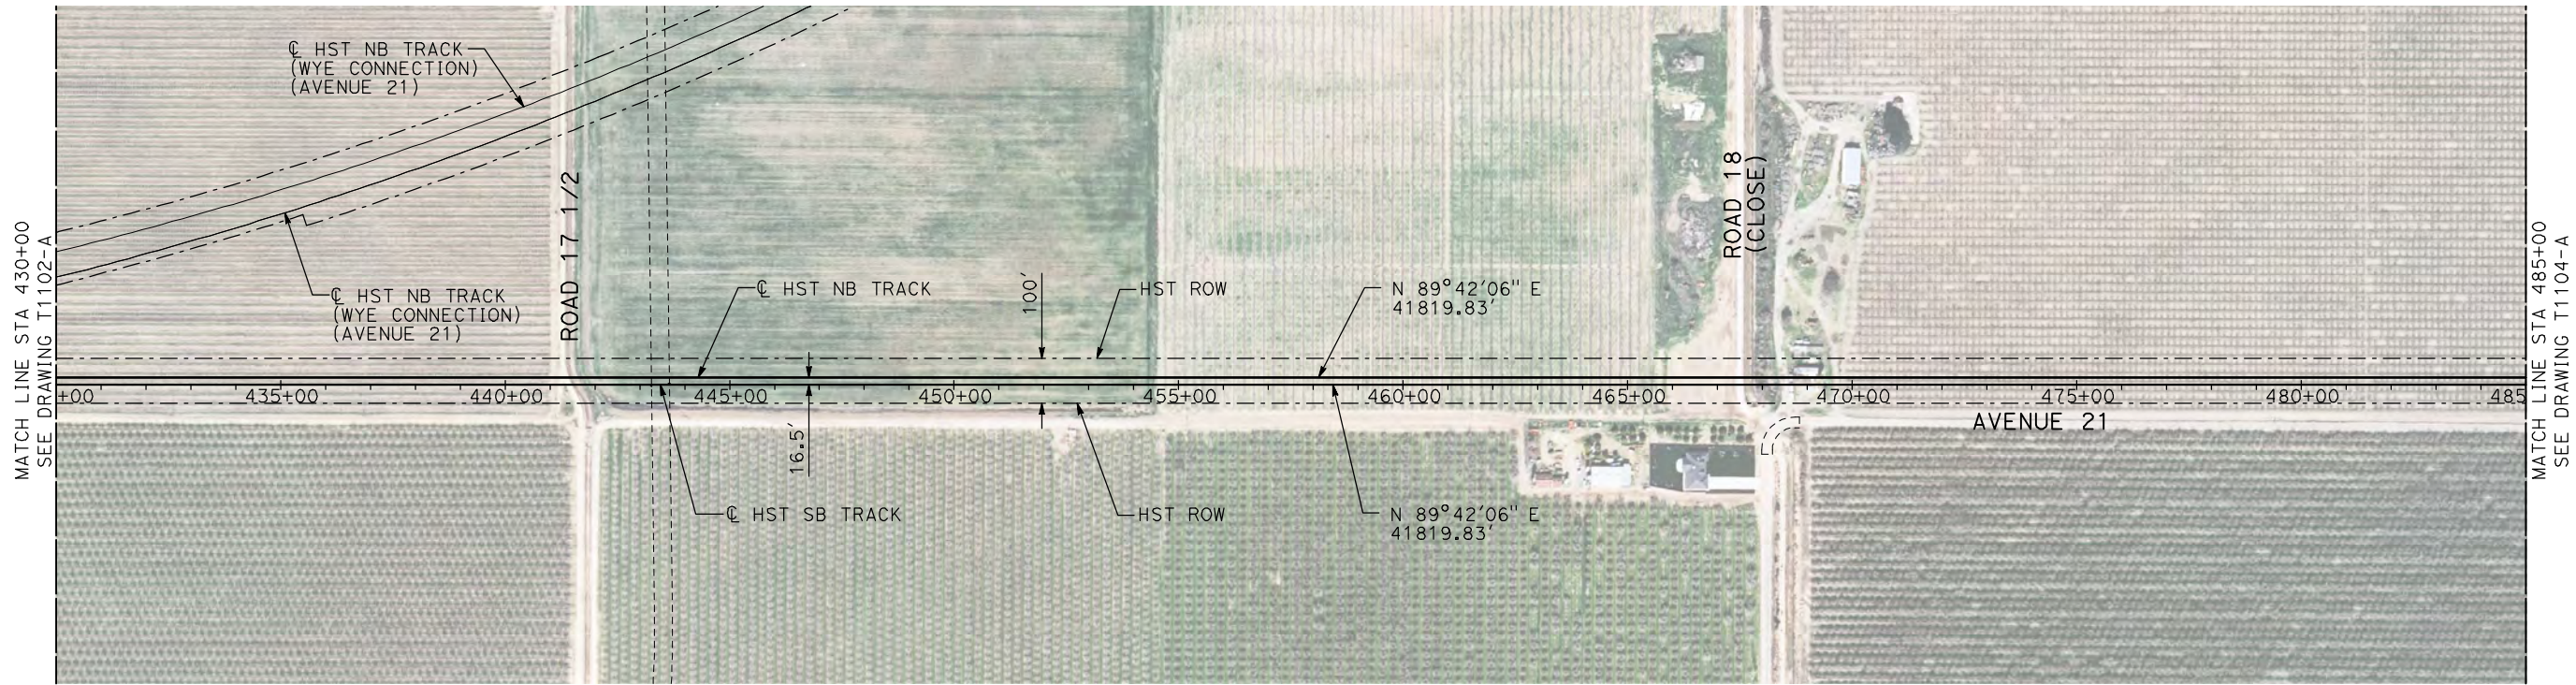
CALIFORNIA HIGH-SPEED TRAIN PROJECT  
MERCED TO FRESNO

HYBRID  
AVENUE 21  
PLAN AND PROFILE  
STA 375+00 TO STA 430+00

CONTRACT NO. HSR06-007
DRAWING NO. T1102-A
SCALE AS SHOWN
SHEET NO. ### OF ###

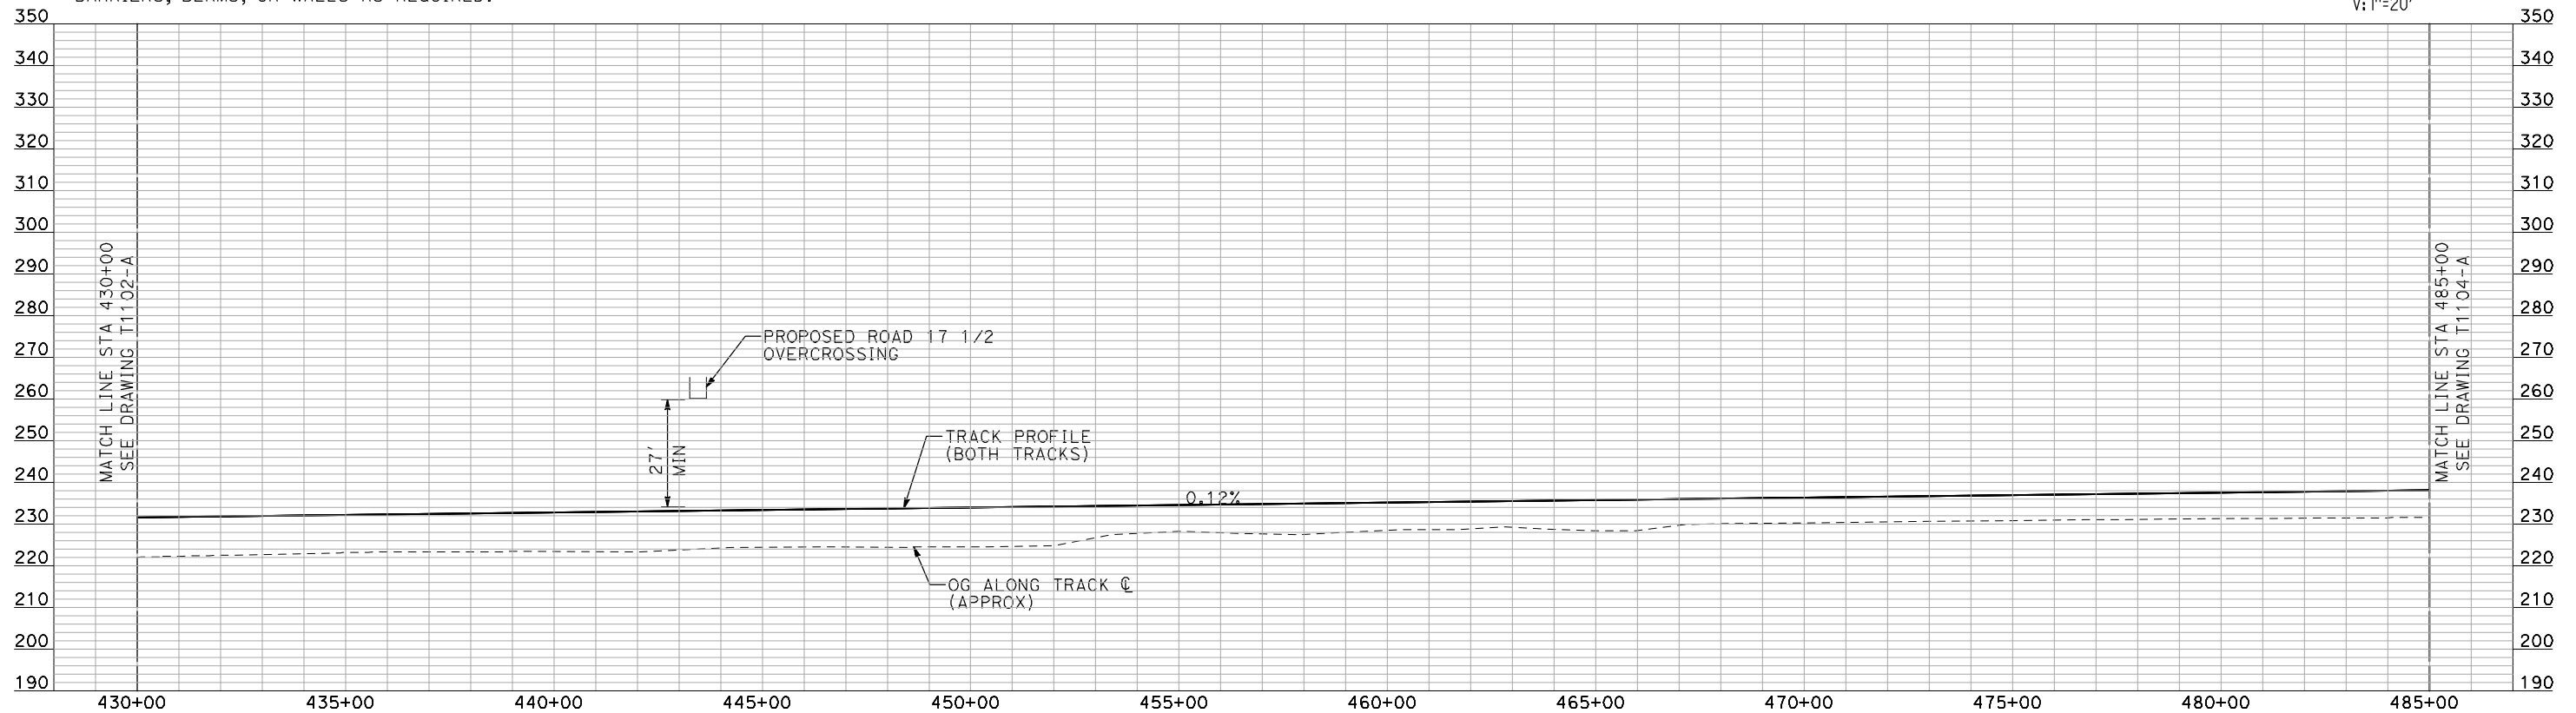
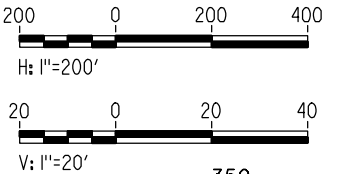


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- NOTES:
1. ALL UTILITIES SHOWN ARE EXISTING UTILITY LINES BASED ON RECORD DRAWINGS AND ARE SHOWN FOR INFORMATIONAL PURPOSES ONLY.
  2. TRACKS CLOSER THAN 102 FT TO THE NEAREST EXISTING FREIGHT TRACKS WILL INCLUDE SAFETY BARRIERS, BERMS, OR WALLS AS REQUIRED.

PLAN



PROFILE

"SEE T3000-T3017 DRAWINGS FOR  
TYPICAL SECTION LIMITS AND DETAILS"

REV	DATE	BY	CHK	APP	DESCRIPTION

DESIGNED BY A. SHIELDS
DRAWN BY H. SULLIVAN
CHECKED BY A. BOONE
IN CHARGE A. BOONE
DATE 07/20/2011

**RECORD SET**  
**15% DESIGN**  
**SUBMITTAL**

**NOT FOR**  
**CONSTRUCTION**

**AECOM**  
Technical Services, Inc.  
2020 L Street, Suite 300  
Sacramento, CA 95811

**CH2M HILL**



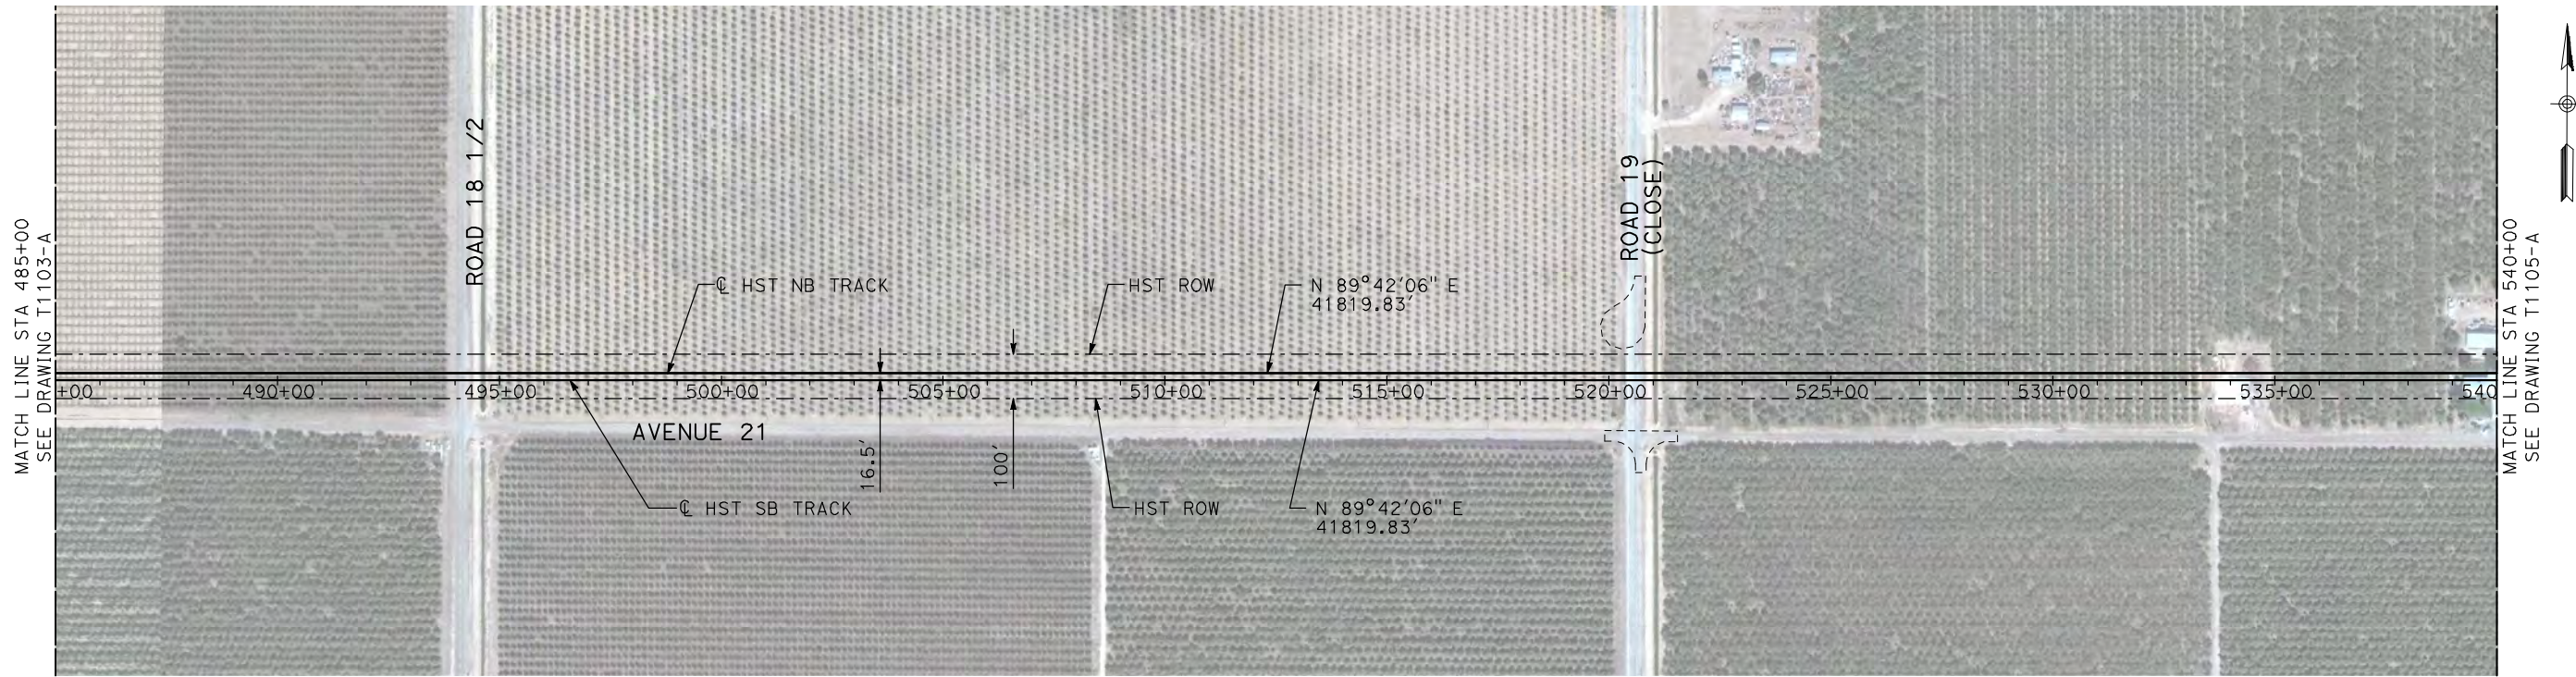
**CALIFORNIA HIGH-SPEED TRAIN PROJECT**  
**MERCED TO FRESNO**

HYBRID  
AVENUE 21  
PLAN AND PROFILE  
STA 430+00 TO STA 485+00

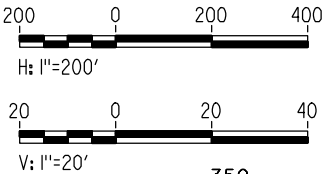
CONTRACT NO. HSR06-007
DRAWING NO. T1103-A
SCALE AS SHOWN
SHEET NO. ### OF ###



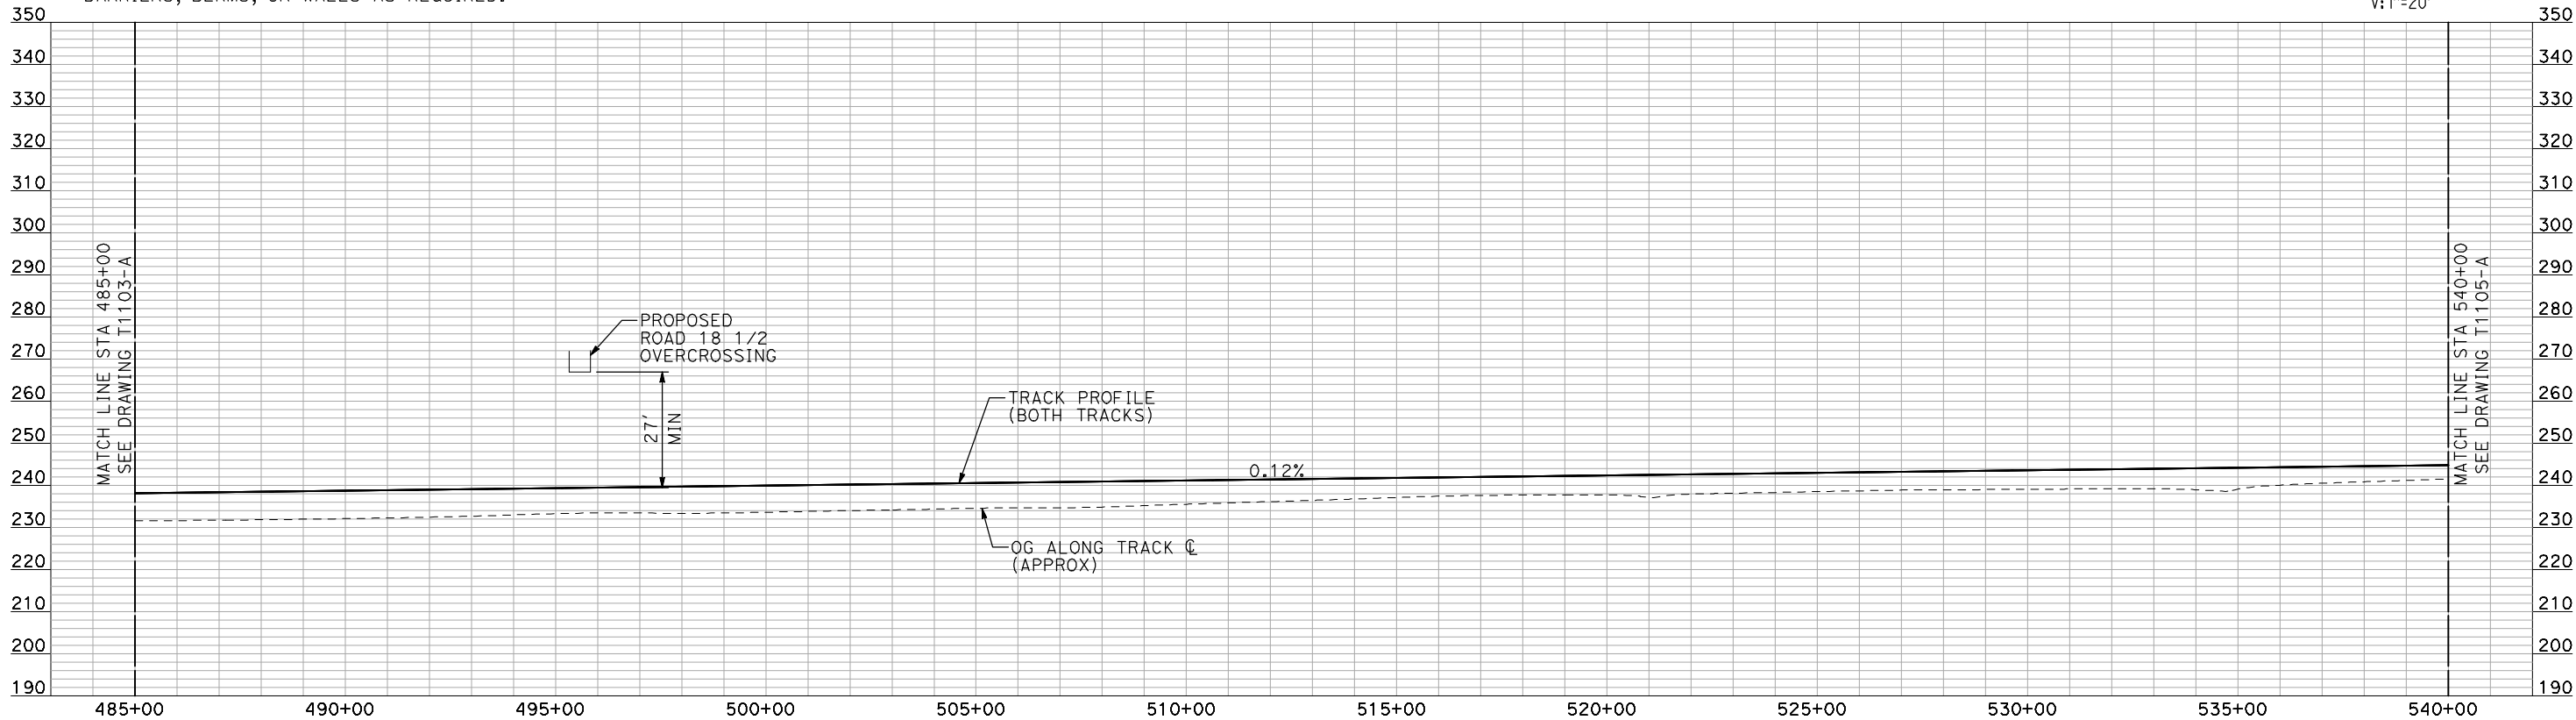
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PLAN



- NOTES:
1. ALL UTILITIES SHOWN ARE EXISTING UTILITY LINES BASED ON RECORD DRAWINGS AND ARE SHOWN FOR INFORMATIONAL PURPOSES ONLY.
  2. TRACKS CLOSER THAN 102 FT TO THE NEAREST EXISTING FREIGHT TRACKS WILL INCLUDE SAFETY BARRIERS, BERMS, OR WALLS AS REQUIRED.



PROFILE

"SEE T3000-T3017 DRAWINGS FOR  
TYPICAL SECTION LIMITS AND DETAILS"

REV	DATE	BY	CHK	APP	DESCRIPTION

DESIGNED BY A. SHIELDS
DRAWN BY H. SULLIVAN
CHECKED BY A. BOONE
IN CHARGE A. BOONE
DATE 07/20/2011

**RECORD SET**  
**15% DESIGN**  
**SUBMITTAL**

**NOT FOR**  
**CONSTRUCTION**



**CALIFORNIA HIGH-SPEED TRAIN PROJECT**  
**MERCED TO FRESNO**

HYBRID  
AVENUE 21  
PLAN AND PROFILE  
STA 485+00 TO STA 540+00

CONTRACT NO. HSR06-007
DRAWING NO. T1104-A
SCALE AS SHOWN
SHEET NO. ### OF ###

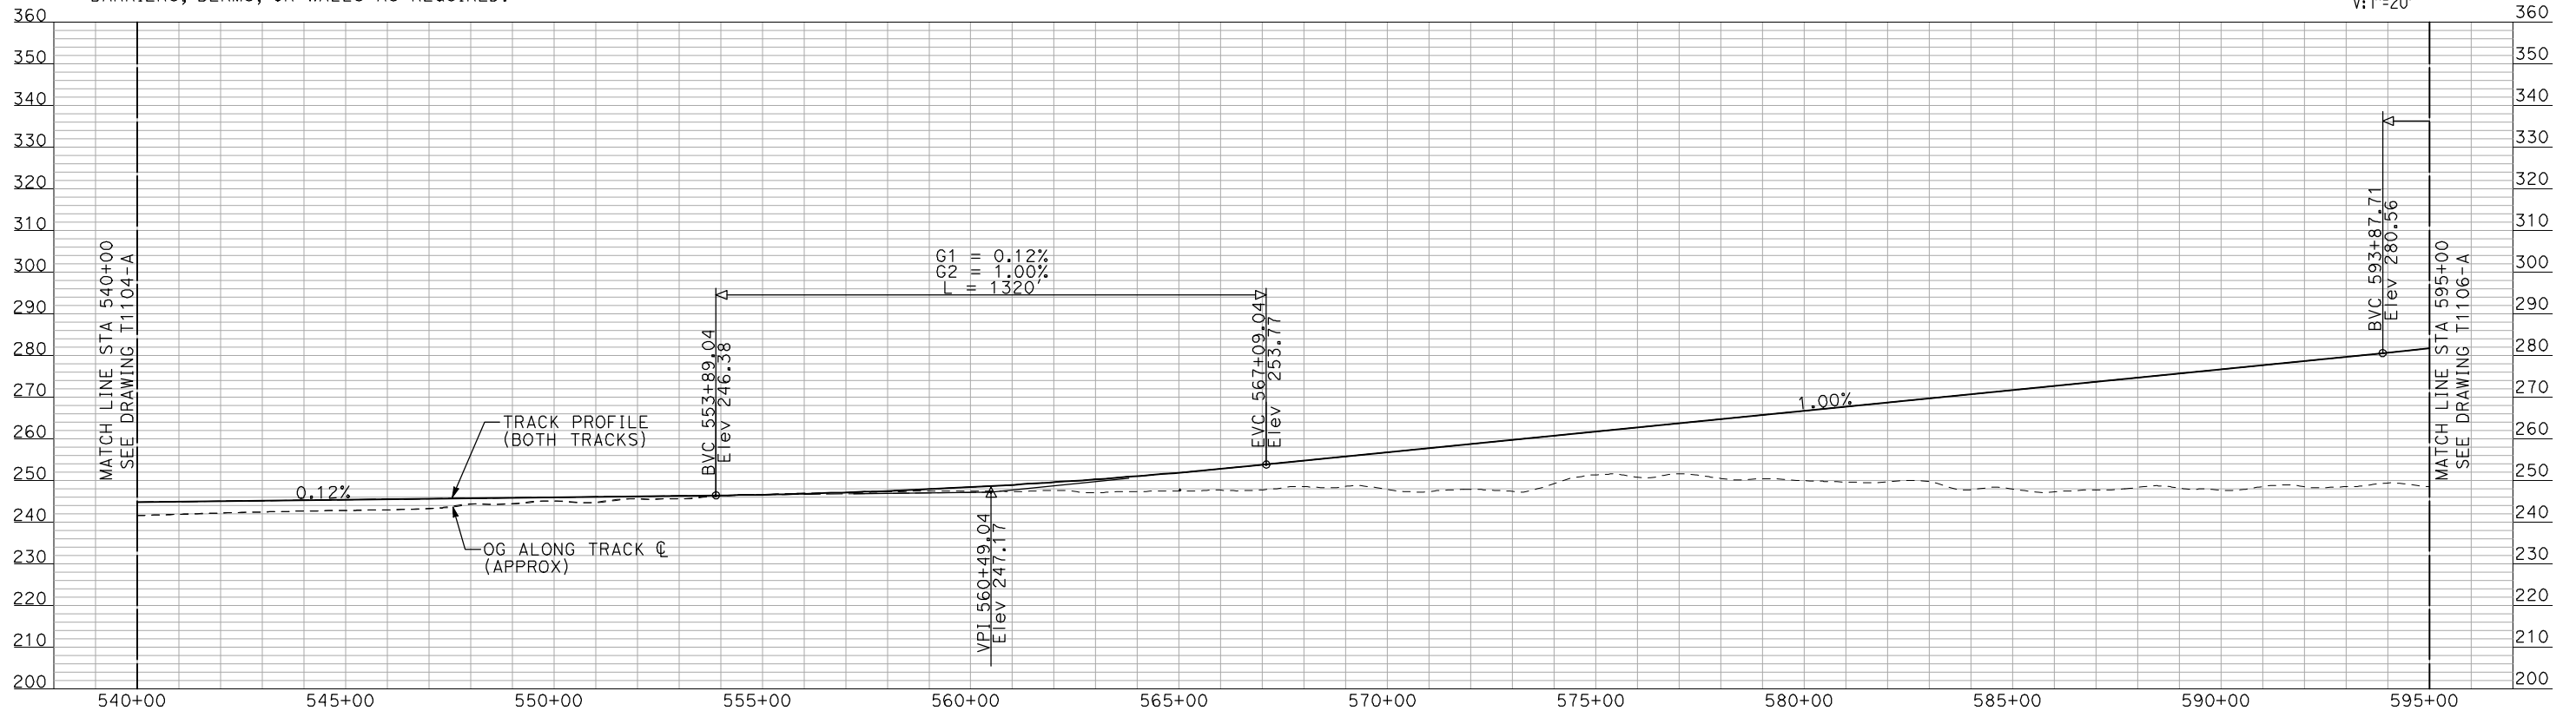
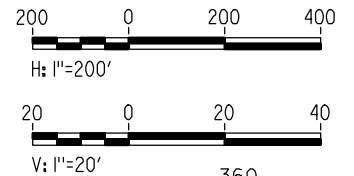


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- NOTES:
1. ALL UTILITIES SHOWN ARE EXISTING UTILITY LINES BASED ON RECORD DRAWINGS AND ARE SHOWN FOR INFORMATIONAL PURPOSES ONLY.
  2. TRACKS CLOSER THAN 102 FT TO THE NEAREST EXISTING FREIGHT TRACKS WILL INCLUDE SAFETY BARRIERS, BERMS, OR WALLS AS REQUIRED.

PLAN



PROFILE

"SEE T3000-T3017 DRAWINGS FOR  
TYPICAL SECTION LIMITS AND DETAILS"

REV	DATE	BY	CHK	APP	DESCRIPTION

DESIGNED BY A. SHIELDS
DRAWN BY H. SULLIVAN
CHECKED BY A. BOONE
IN CHARGE A. BOONE
DATE 07/20/2011

**RECORD SET**  
**15% DESIGN**  
**SUBMITTAL**

**NOT FOR**  
**CONSTRUCTION**

**AECOM**  
Technical Services, Inc.  
2020 L Street, Suite 300  
Sacramento, CA 95811

**CH2M HILL**



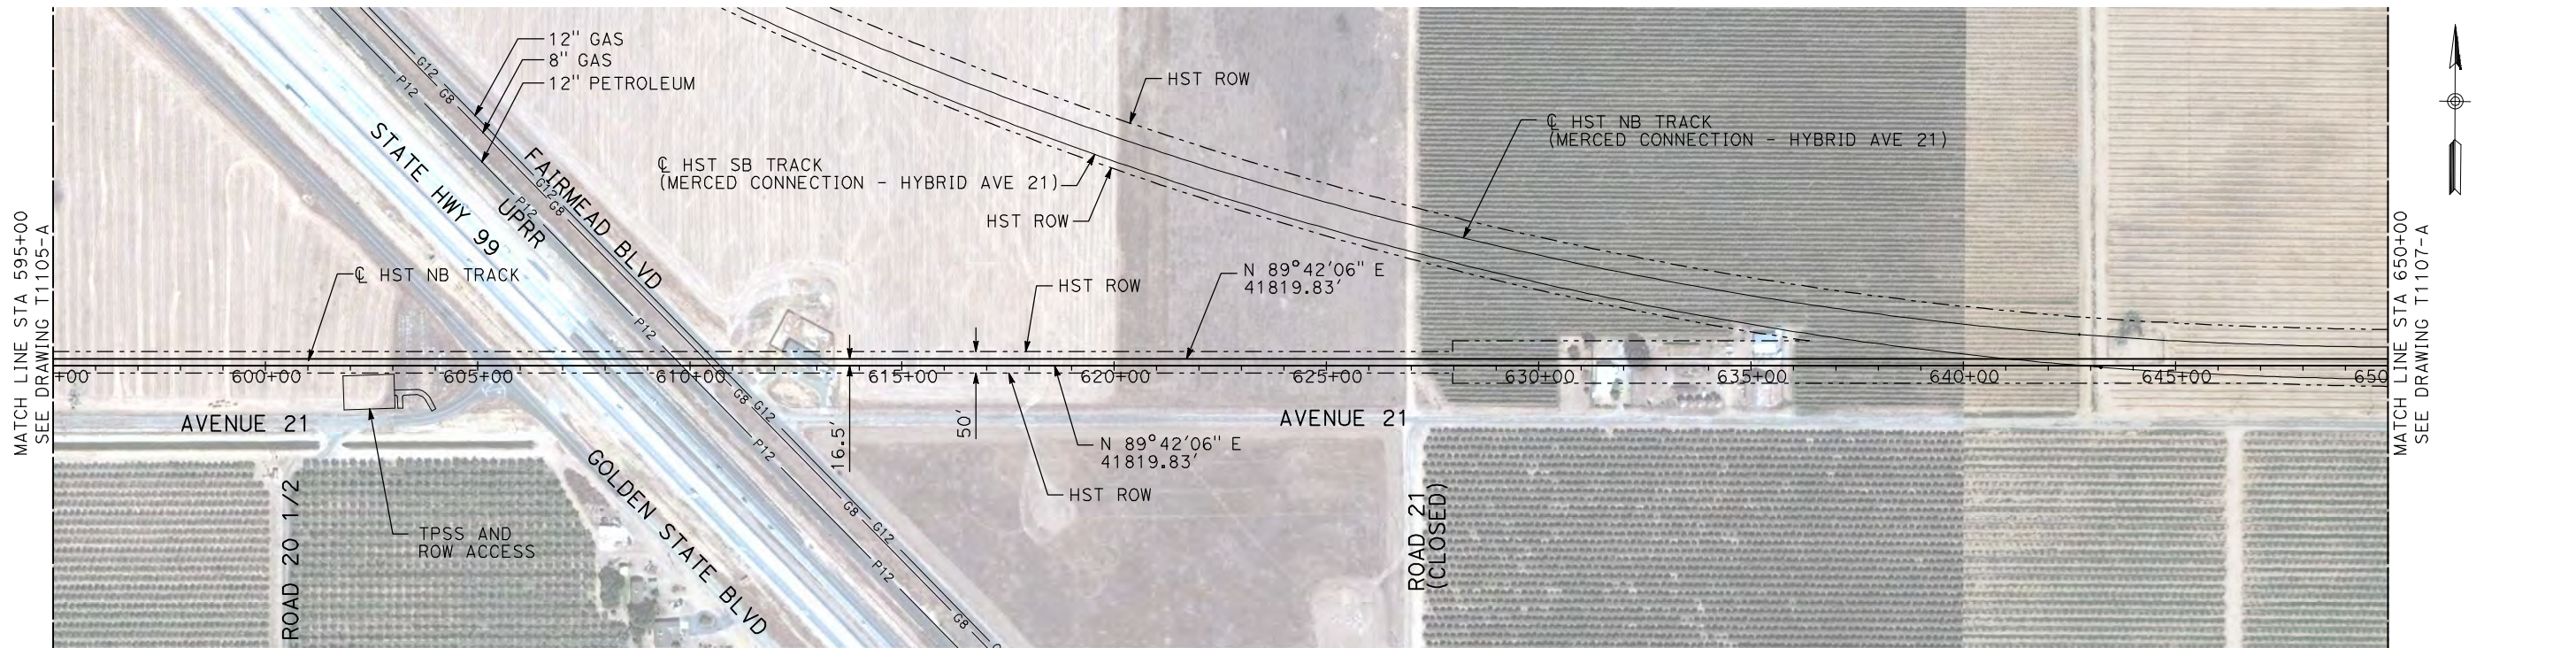
**CALIFORNIA HIGH-SPEED TRAIN PROJECT**  
**MERCED TO FRESNO**

HYBRID  
AVENUE 21  
PLAN AND PROFILE  
STA 540+00 TO STA 595+00

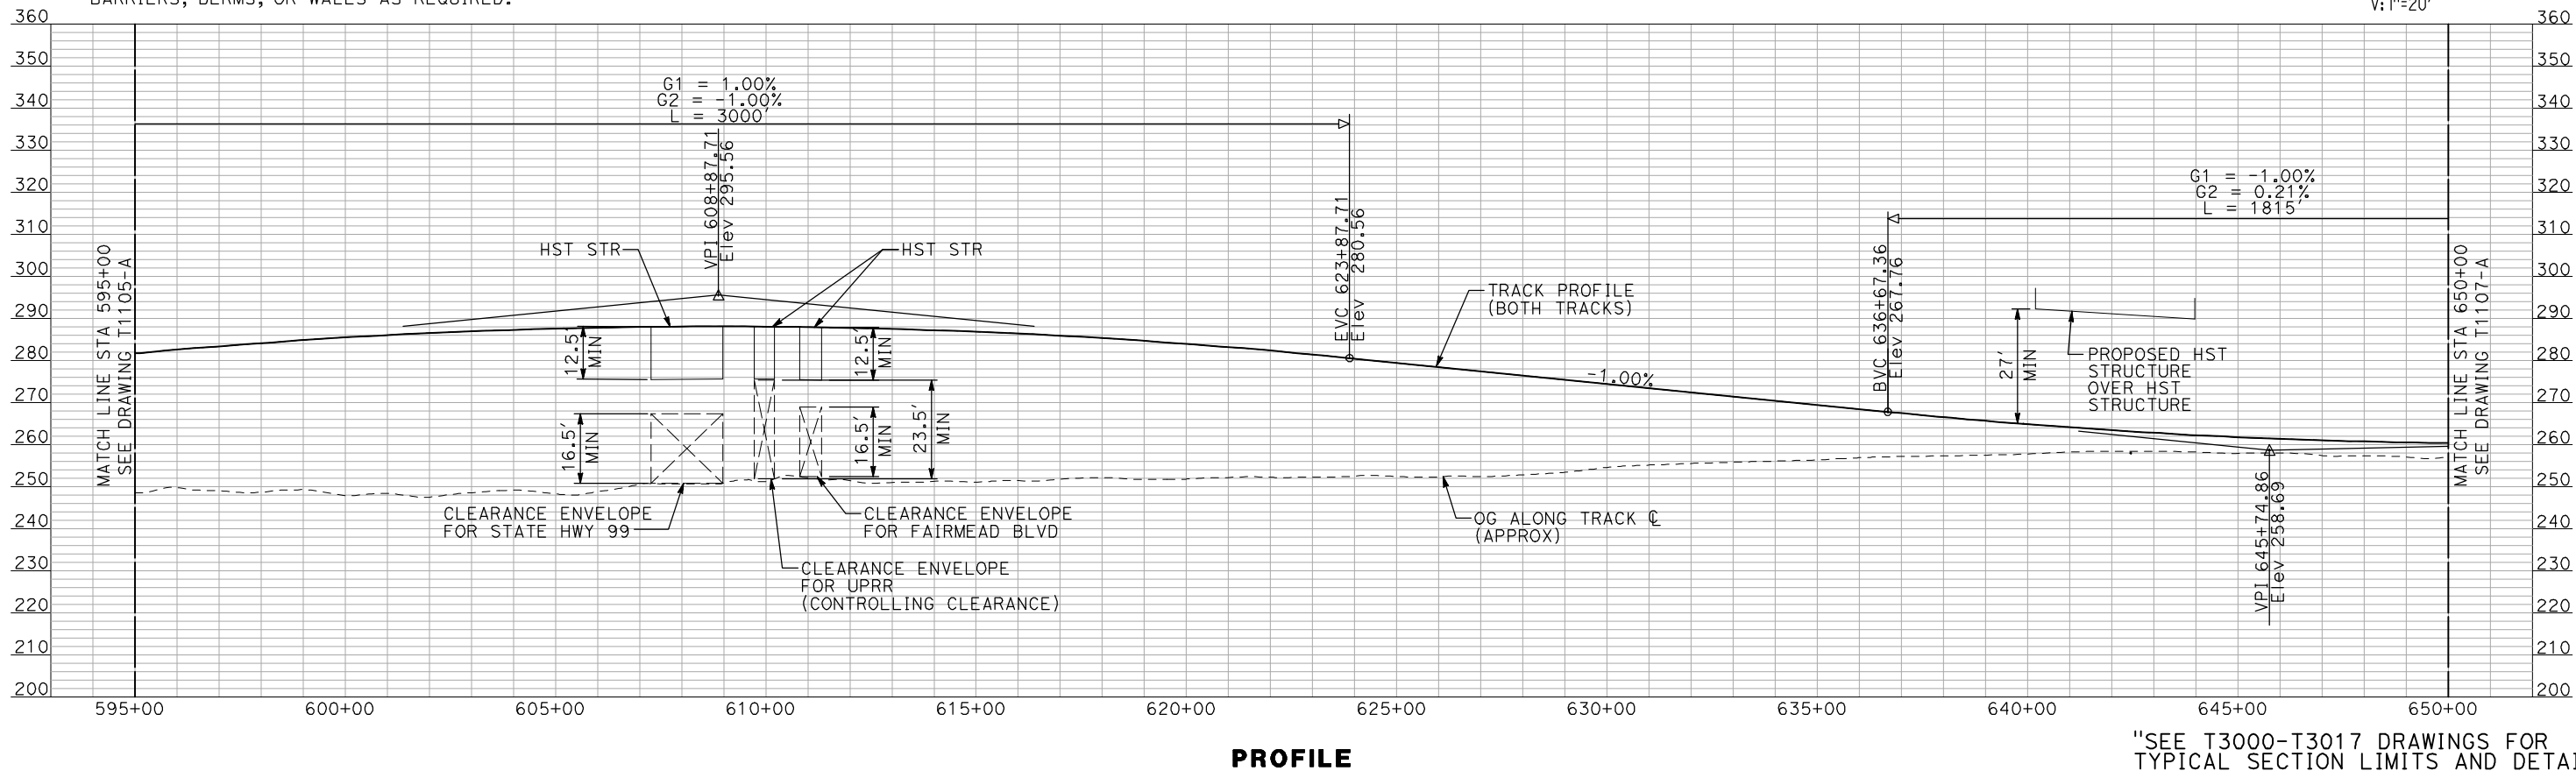
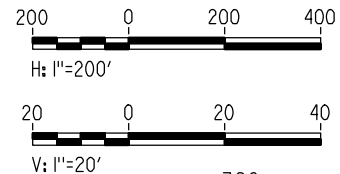
CONTRACT NO. HSR06-007
DRAWING NO. T1105-A
SCALE AS SHOWN
SHEET NO. ### OF ###



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- NOTES:
1. ALL UTILITIES SHOWN ARE EXISTING UTILITY LINES BASED ON RECORD DRAWINGS AND ARE SHOWN FOR INFORMATIONAL PURPOSES ONLY.
  2. TRACKS CLOSER THAN 102 FT TO THE NEAREST EXISTING FREIGHT TRACKS WILL INCLUDE SAFETY BARRIERS, BERMS, OR WALLS AS REQUIRED.



"SEE T3000-T3017 DRAWINGS FOR  
TYPICAL SECTION LIMITS AND DETAILS"

REV	DATE	BY	CHK	APP	DESCRIPTION

DESIGNED BY  
A. SHIELDS  
DRAWN BY  
H. SULLIVAN  
CHECKED BY  
A. BOONE  
IN CHARGE  
A. BOONE  
DATE  
07/20/2011

RECORD SET  
15% DESIGN  
SUBMITTAL

NOT FOR  
CONSTRUCTION

**AECOM**  
Technical Services, Inc.  
2020 L Street, Suite 300  
Sacramento, CA 95811  
**CH2M HILL**



**CALIFORNIA HIGH-SPEED TRAIN PROJECT  
MERCED TO FRESNO**

HYBRID  
AVENUE 21  
PLAN AND PROFILE  
STA 595+00 TO STA 650+00

CONTRACT NO.  
HSR06-007  
DRAWING NO.  
T1106-A  
SCALE  
AS SHOWN  
SHEET NO.  
### OF ###

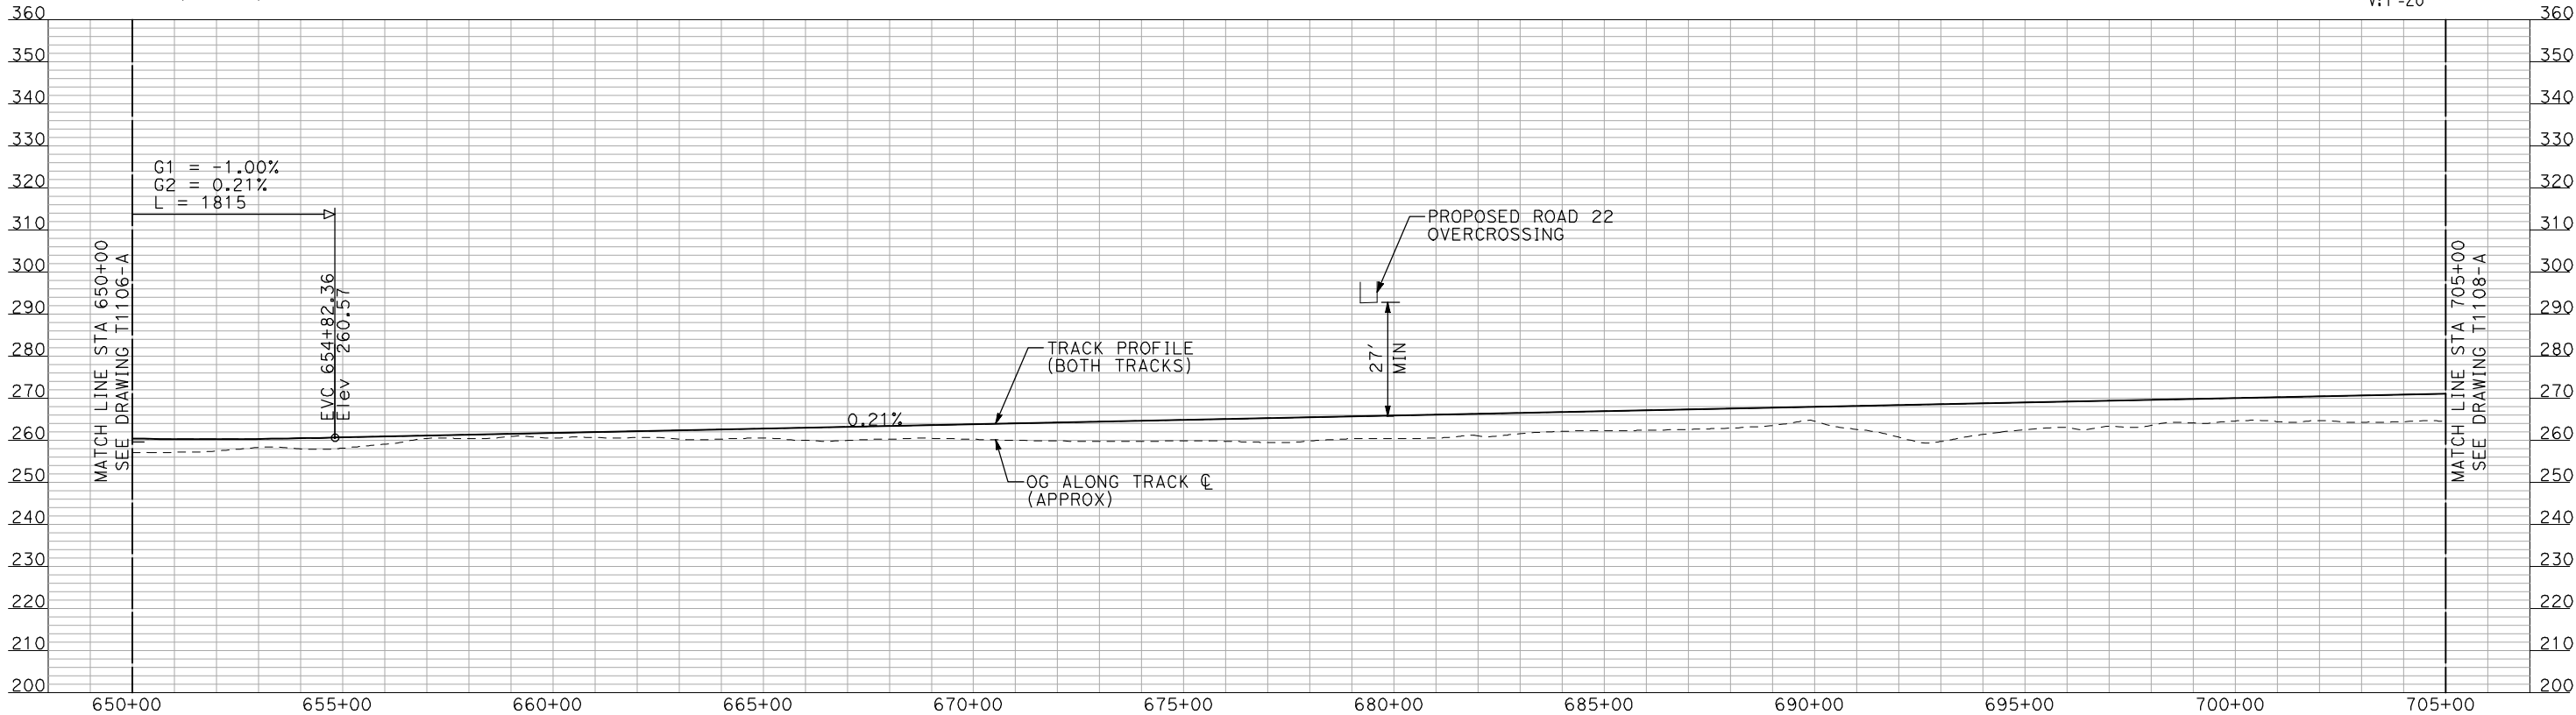
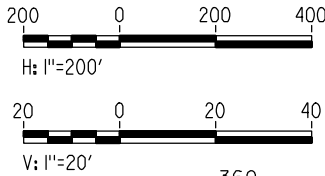


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- NOTES:
1. ALL UTILITIES SHOWN ARE EXISTING UTILITY LINES BASED ON RECORD DRAWINGS AND ARE SHOWN FOR INFORMATIONAL PURPOSES ONLY.
  2. TRACKS CLOSER THAN 102 FT TO THE NEAREST EXISTING FREIGHT TRACKS WILL INCLUDE SAFETY BARRIERS, BERMS, OR WALLS AS REQUIRED.

PLAN



PROFILE

"SEE T3000-T3017 DRAWINGS FOR  
TYPICAL SECTION LIMITS AND DETAILS"

REV	DATE	BY	CHK	APP	DESCRIPTION

DESIGNED BY A. SHIELDS
DRAWN BY H. SULLIVAN
CHECKED BY A. BOONE
IN CHARGE A. BOONE
DATE 07/20/2011

RECORD SET  
15% DESIGN  
SUBMITTAL

NOT FOR  
CONSTRUCTION



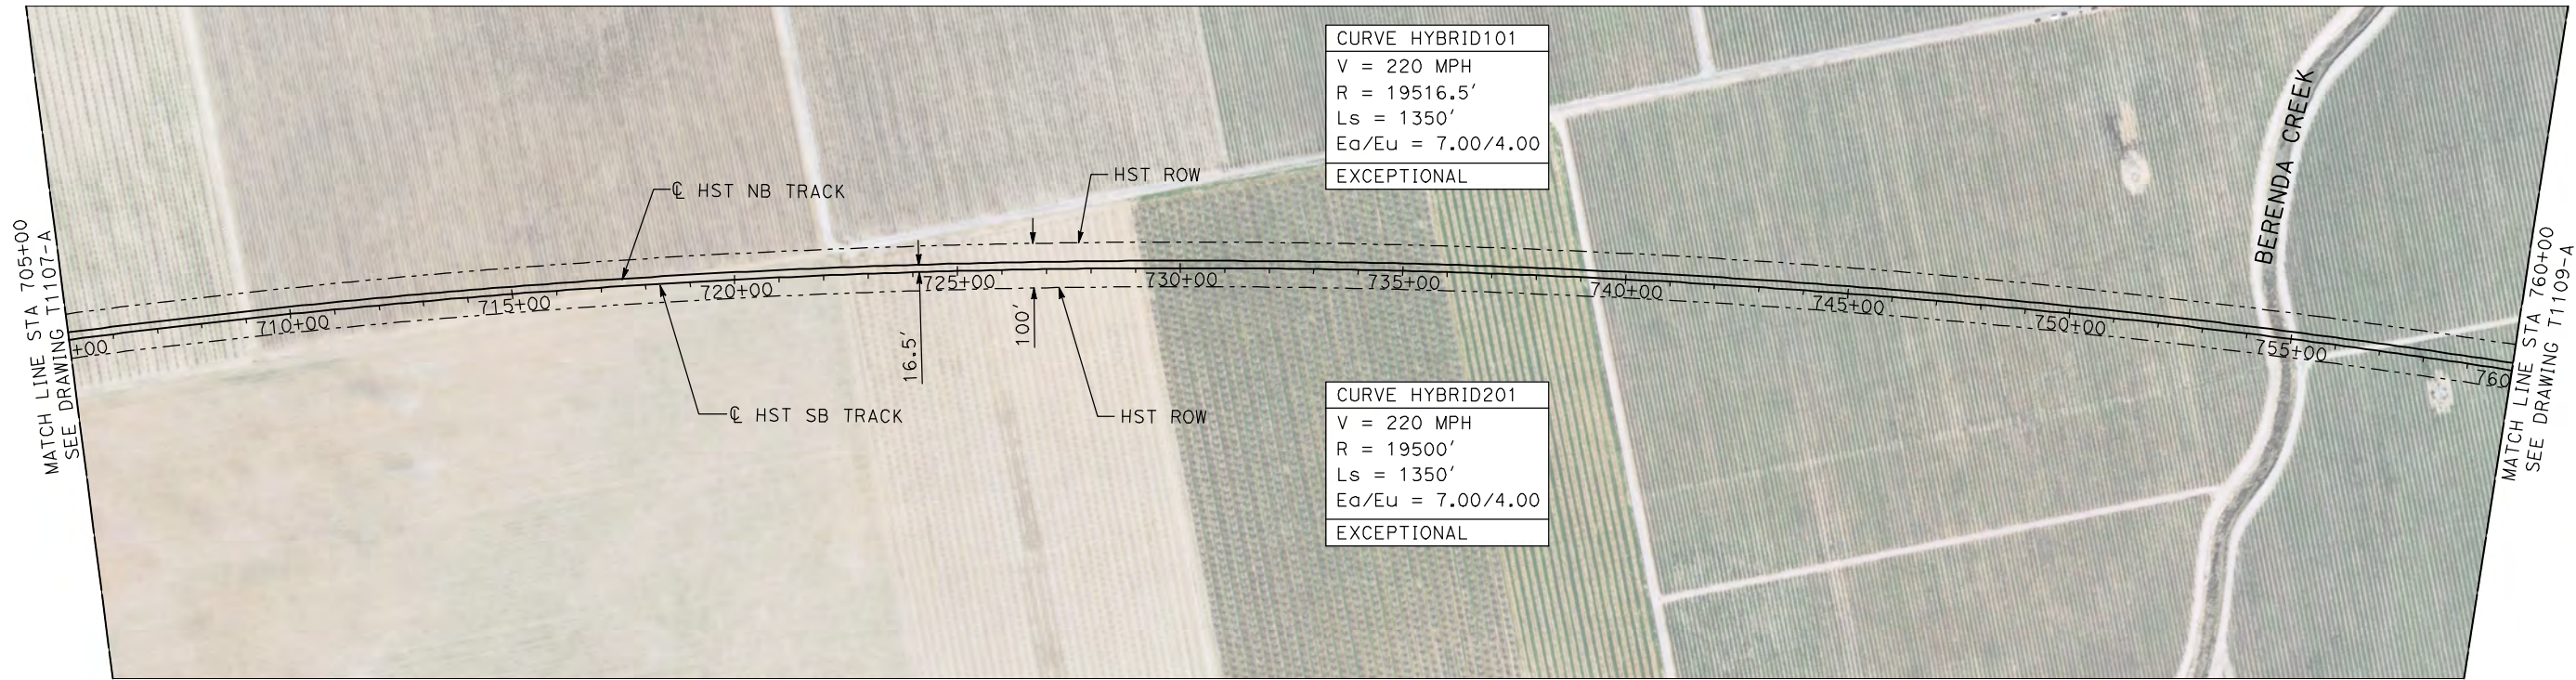
CALIFORNIA HIGH-SPEED TRAIN PROJECT  
MERCED TO FRESNO

HYBRID  
AVENUE 21  
PLAN AND PROFILE  
STA 650+00 TO STA 705+00

CONTRACT NO. HSR06-007
DRAWING NO. T1107-A
SCALE AS SHOWN
SHEET NO. ### OF ###

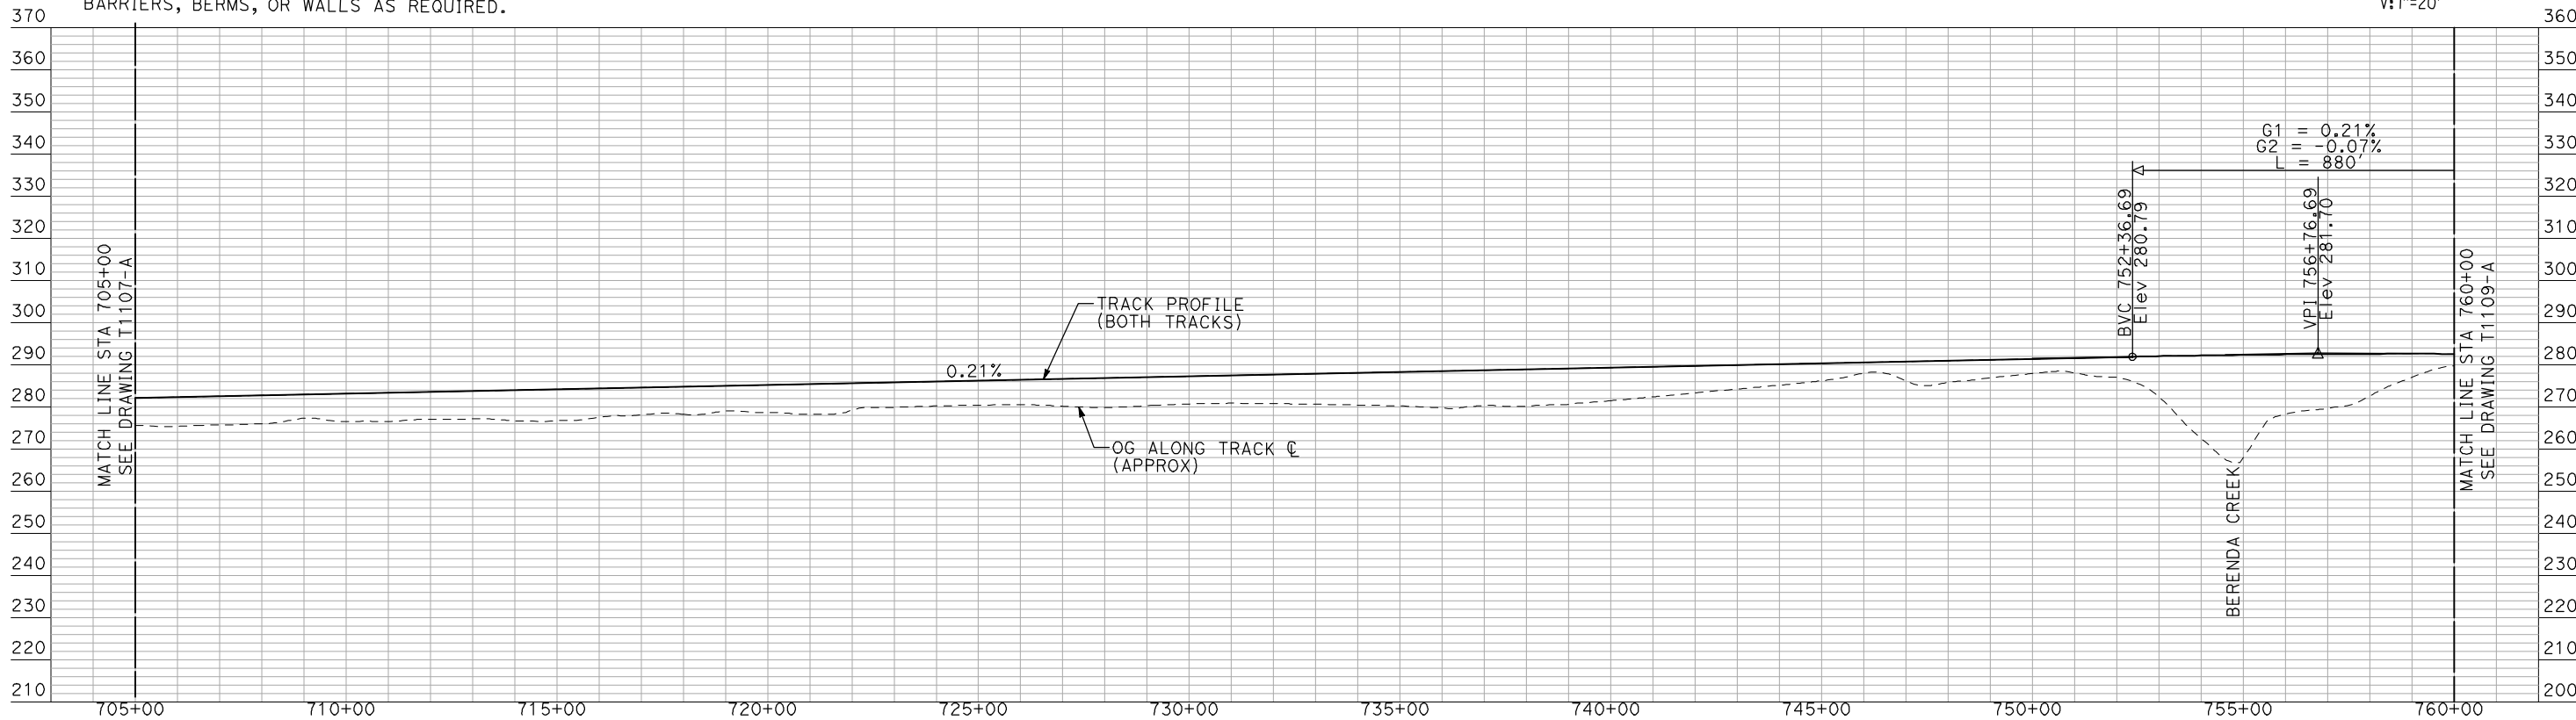


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PLAN

- NOTES:
1. ALL UTILITIES SHOWN ARE EXISTING UTILITY LINES BASED ON RECORD DRAWINGS AND ARE SHOWN FOR INFORMATIONAL PURPOSES ONLY.
  2. TRACKS CLOSER THAN 102 FT TO THE NEAREST EXISTING FREIGHT TRACKS WILL INCLUDE SAFETY BARRIERS, BERMS, OR WALLS AS REQUIRED.



PROFILE

"SEE T3000-T3017 DRAWINGS FOR  
TYPICAL SECTION LIMITS AND DETAILS"

REV	DATE	BY	CHK	APP	DESCRIPTION

DESIGNED BY A. SHIELDS
DRAWN BY H. SULLIVAN
CHECKED BY A. BOONE
IN CHARGE A. BOONE
DATE 07/20/2011

RECORD SET  
15% DESIGN  
SUBMITTAL

NOT FOR  
CONSTRUCTION

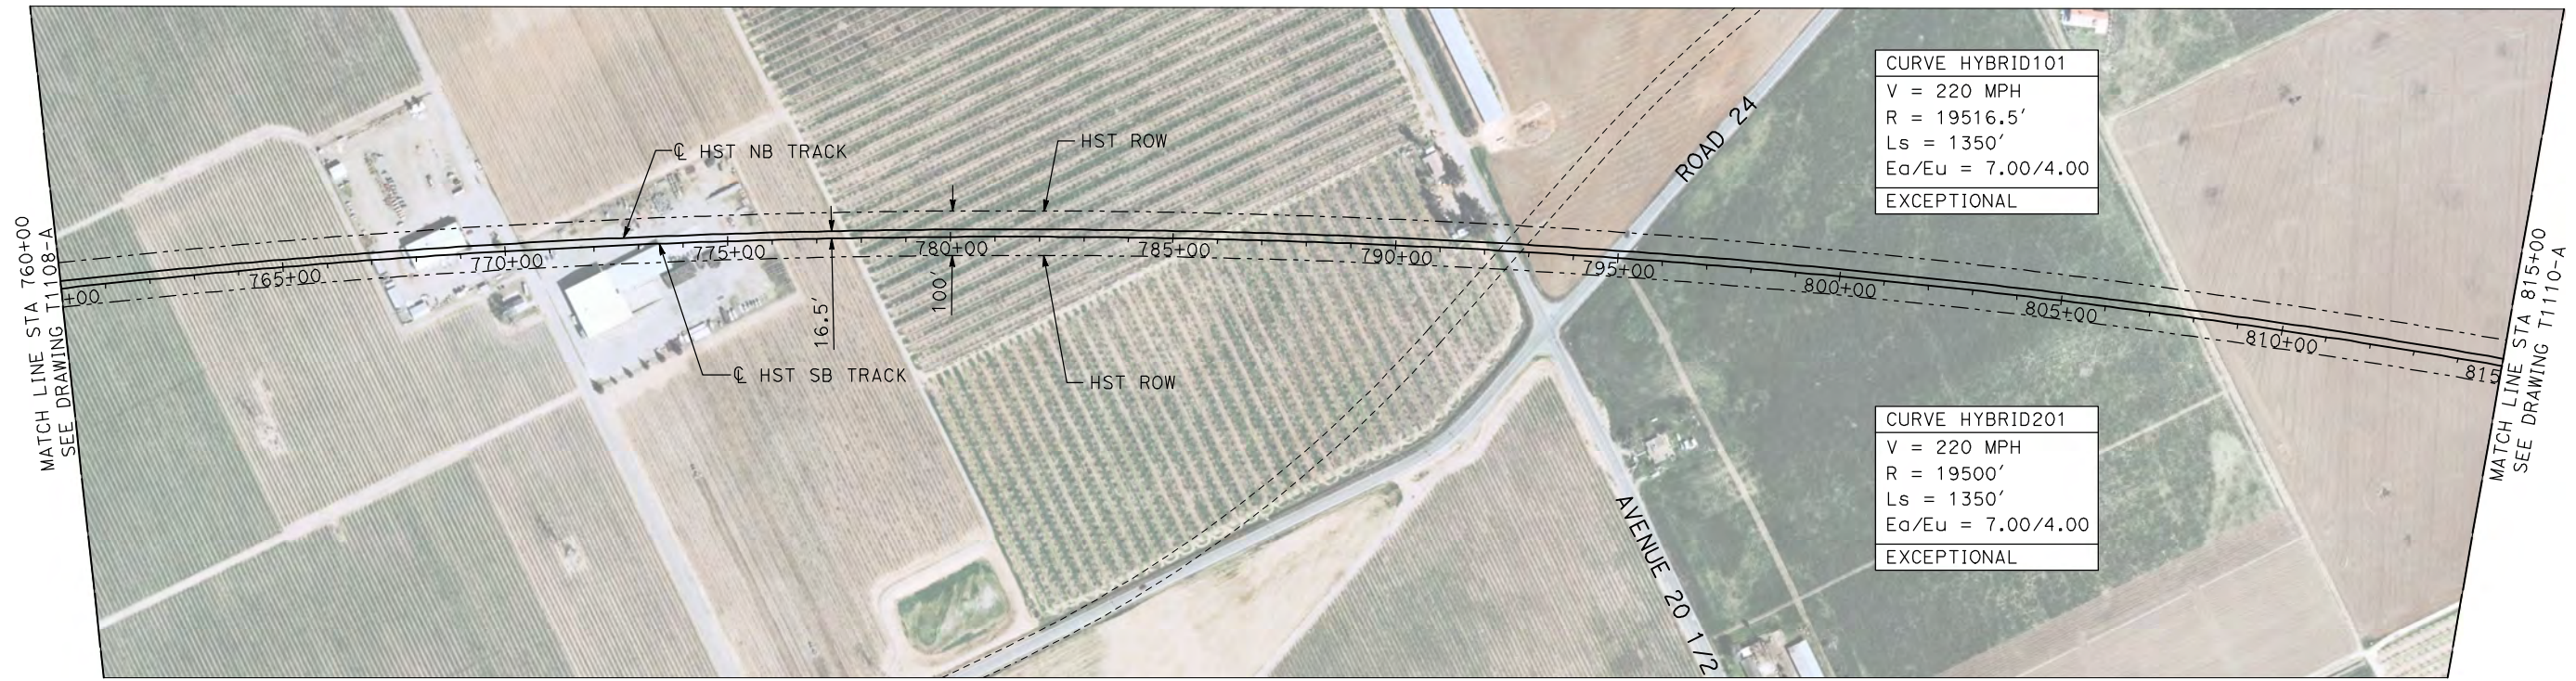


CALIFORNIA HIGH-SPEED TRAIN PROJECT  
MERCED TO FRESNO  
HYBRID  
AVENUE 21  
PLAN AND PROFILE  
STA 705+00 TO STA 760+00

CONTRACT NO. HSR06-007
DRAWING NO. T1108-A
SCALE AS SHOWN
SHEET NO. ### OF ###

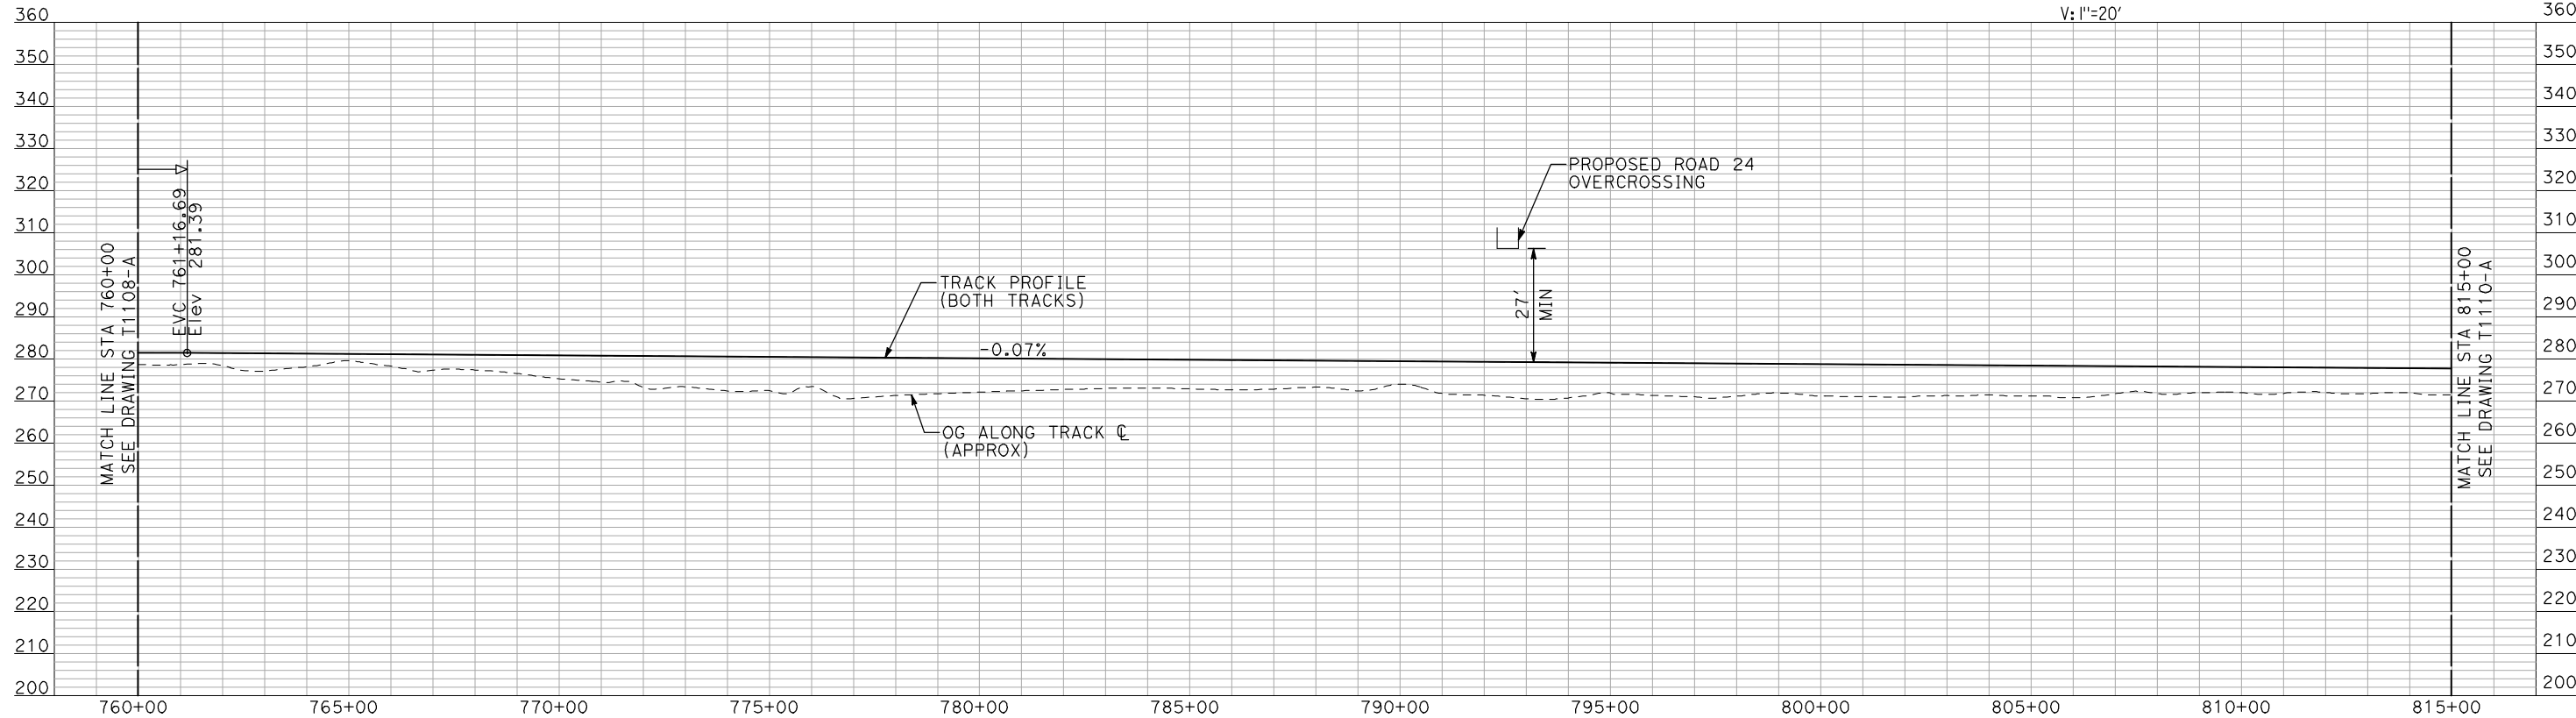
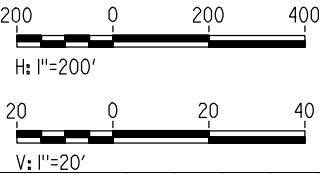


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- NOTES:
1. ALL UTILITIES SHOWN ARE EXISTING UTILITY LINES BASED ON RECORD DRAWINGS AND ARE SHOWN FOR INFORMATIONAL PURPOSES ONLY.
  2. TRACKS CLOSER THAN 102 FT TO THE NEAREST EXISTING FREIGHT TRACKS WILL INCLUDE SAFETY BARRIERS, BERMS, OR WALLS AS REQUIRED.

PLAN



PROFILE

"SEE T3000-T3017 DRAWINGS FOR  
TYPICAL SECTION LIMITS AND DETAILS"

REV	DATE	BY	CHK	APP	DESCRIPTION

DESIGNED BY A. SHIELDS
DRAWN BY H. SULLIVAN
CHECKED BY A. BOONE
IN CHARGE A. BOONE
DATE 07/20/2011

**RECORD SET  
15% DESIGN  
SUBMITTAL**

**NOT FOR  
CONSTRUCTION**



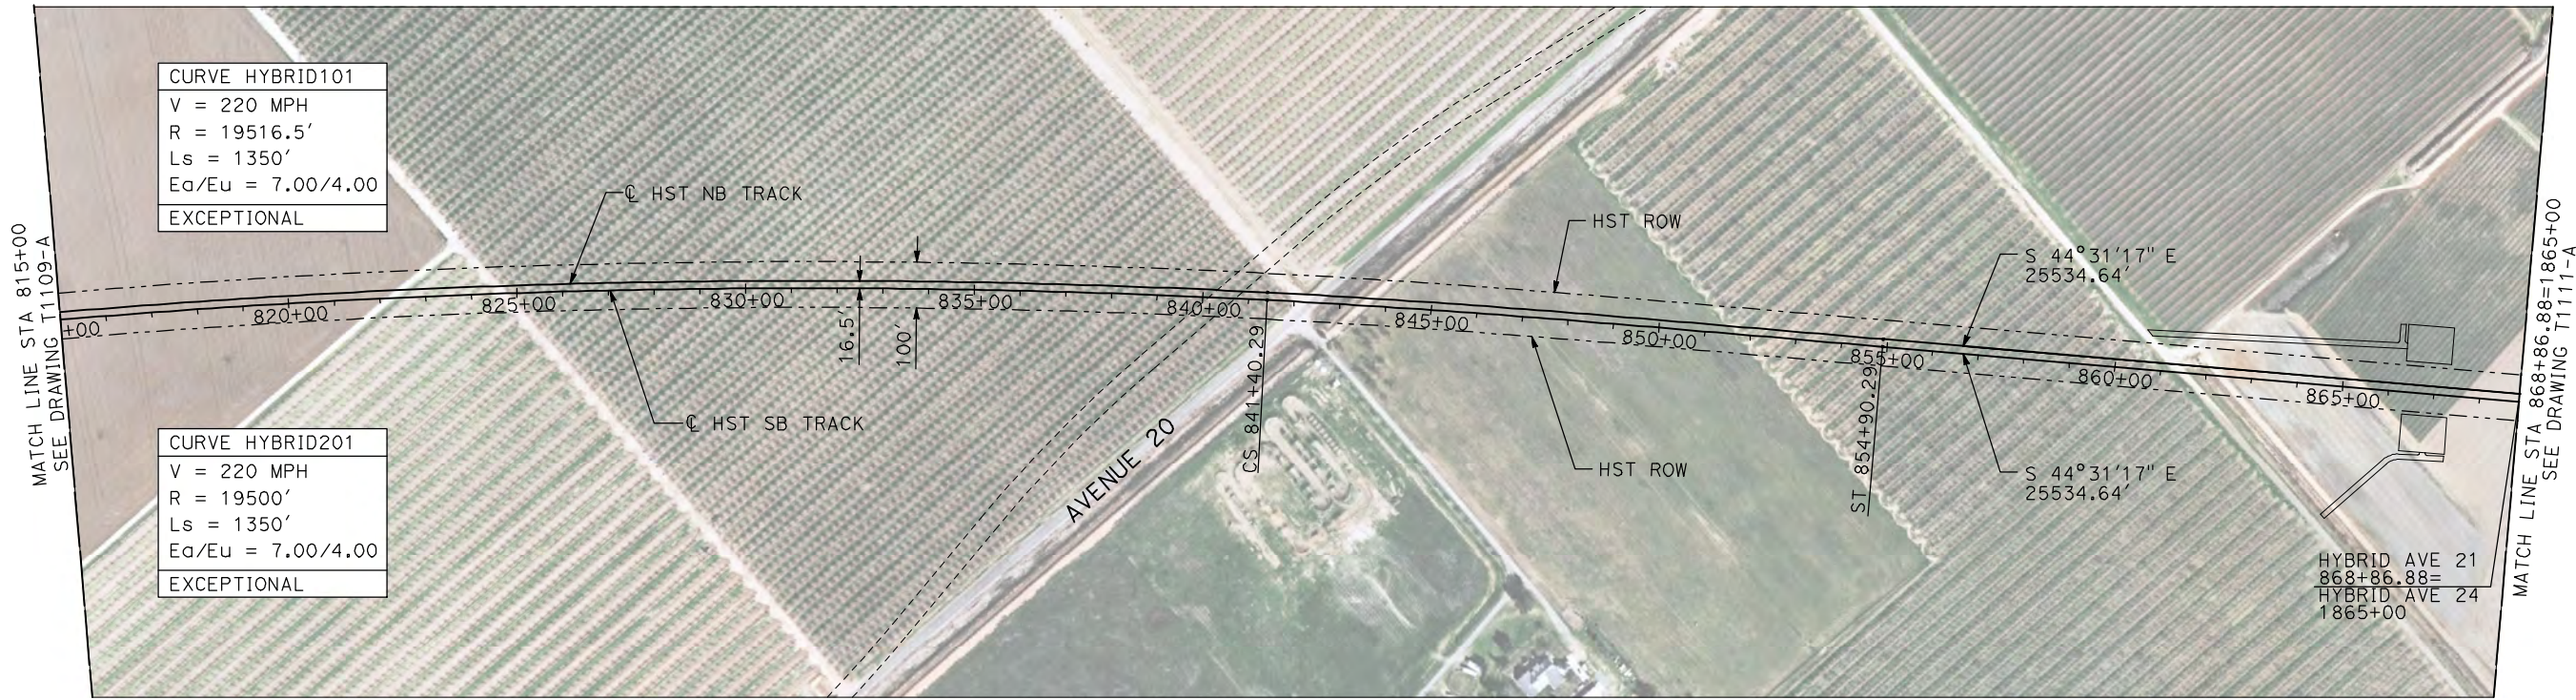
**CALIFORNIA HIGH-SPEED TRAIN PROJECT  
MERCED TO FRESNO**

HYBRID  
AVENUE 21  
PLAN AND PROFILE  
STA 760+00 TO STA 815+00

CONTRACT NO. HSR06-007
DRAWING NO. T1109-A
SCALE AS SHOWN
SHEET NO. ### OF ###

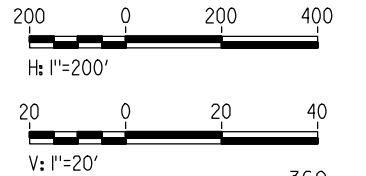


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- NOTES:
1. ALL UTILITIES SHOWN ARE EXISTING UTILITY LINES BASED ON RECORD DRAWINGS AND ARE SHOWN FOR INFORMATIONAL PURPOSES ONLY.
  2. TRACKS CLOSER THAN 102 FT TO THE NEAREST EXISTING FREIGHT TRACKS WILL INCLUDE SAFETY BARRIERS, BERMS, OR WALLS AS REQUIRED.

PLAN



PROFILE

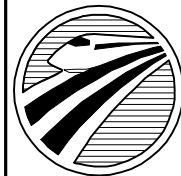
"SEE T3000-T3017 DRAWINGS FOR  
TYPICAL SECTION LIMITS AND DETAILS"

REV	DATE	BY	CHK	APP	DESCRIPTION

DESIGNED BY A. SHIELDS
DRAWN BY H. SULLIVAN
CHECKED BY A. BOONE
IN CHARGE A. BOONE
DATE 07/20/2011

RECORD SET  
15% DESIGN  
SUBMITTAL

NOT FOR  
CONSTRUCTION



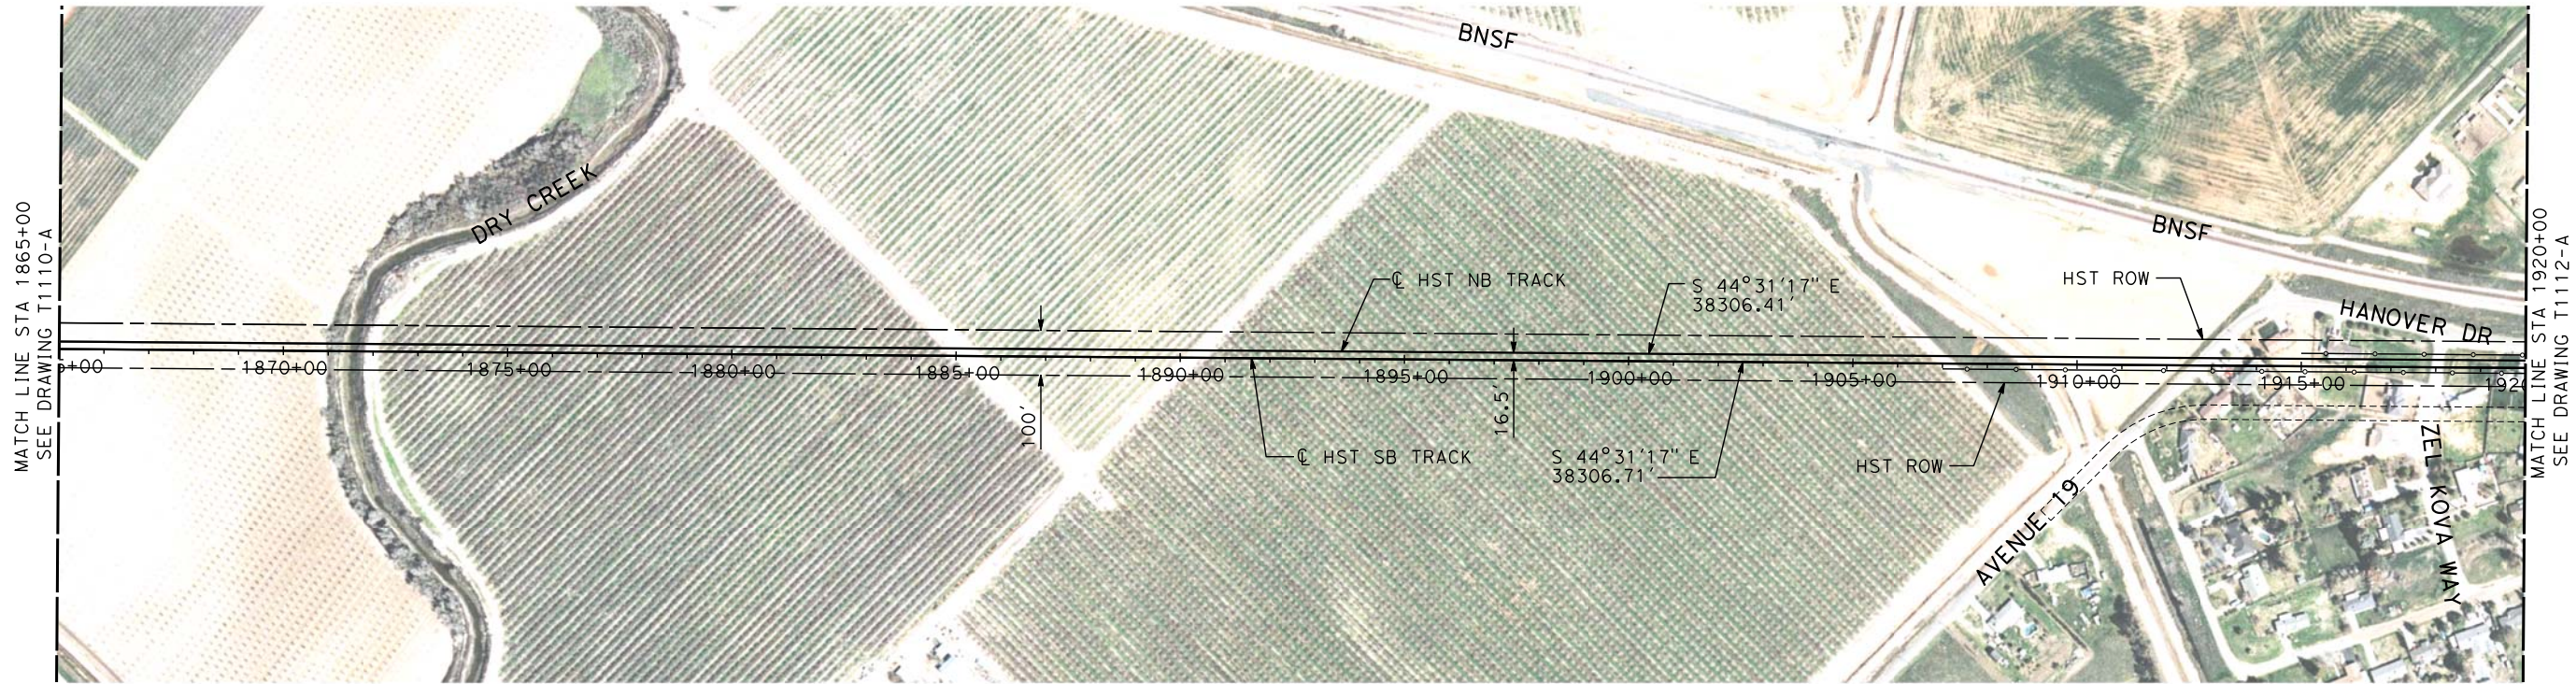
CALIFORNIA  
HIGH-SPEED RAIL AUTHORITY

CALIFORNIA HIGH-SPEED TRAIN PROJECT  
MERCED TO FRESNO  
HYBRID  
AVENUE 21  
PLAN AND PROFILE  
STA 815+00 TO STA 868+86.88

CONTRACT NO. HSR06-007
DRAWING NO. T1110-A
SCALE AS SHOWN
SHEET NO. ### OF ###

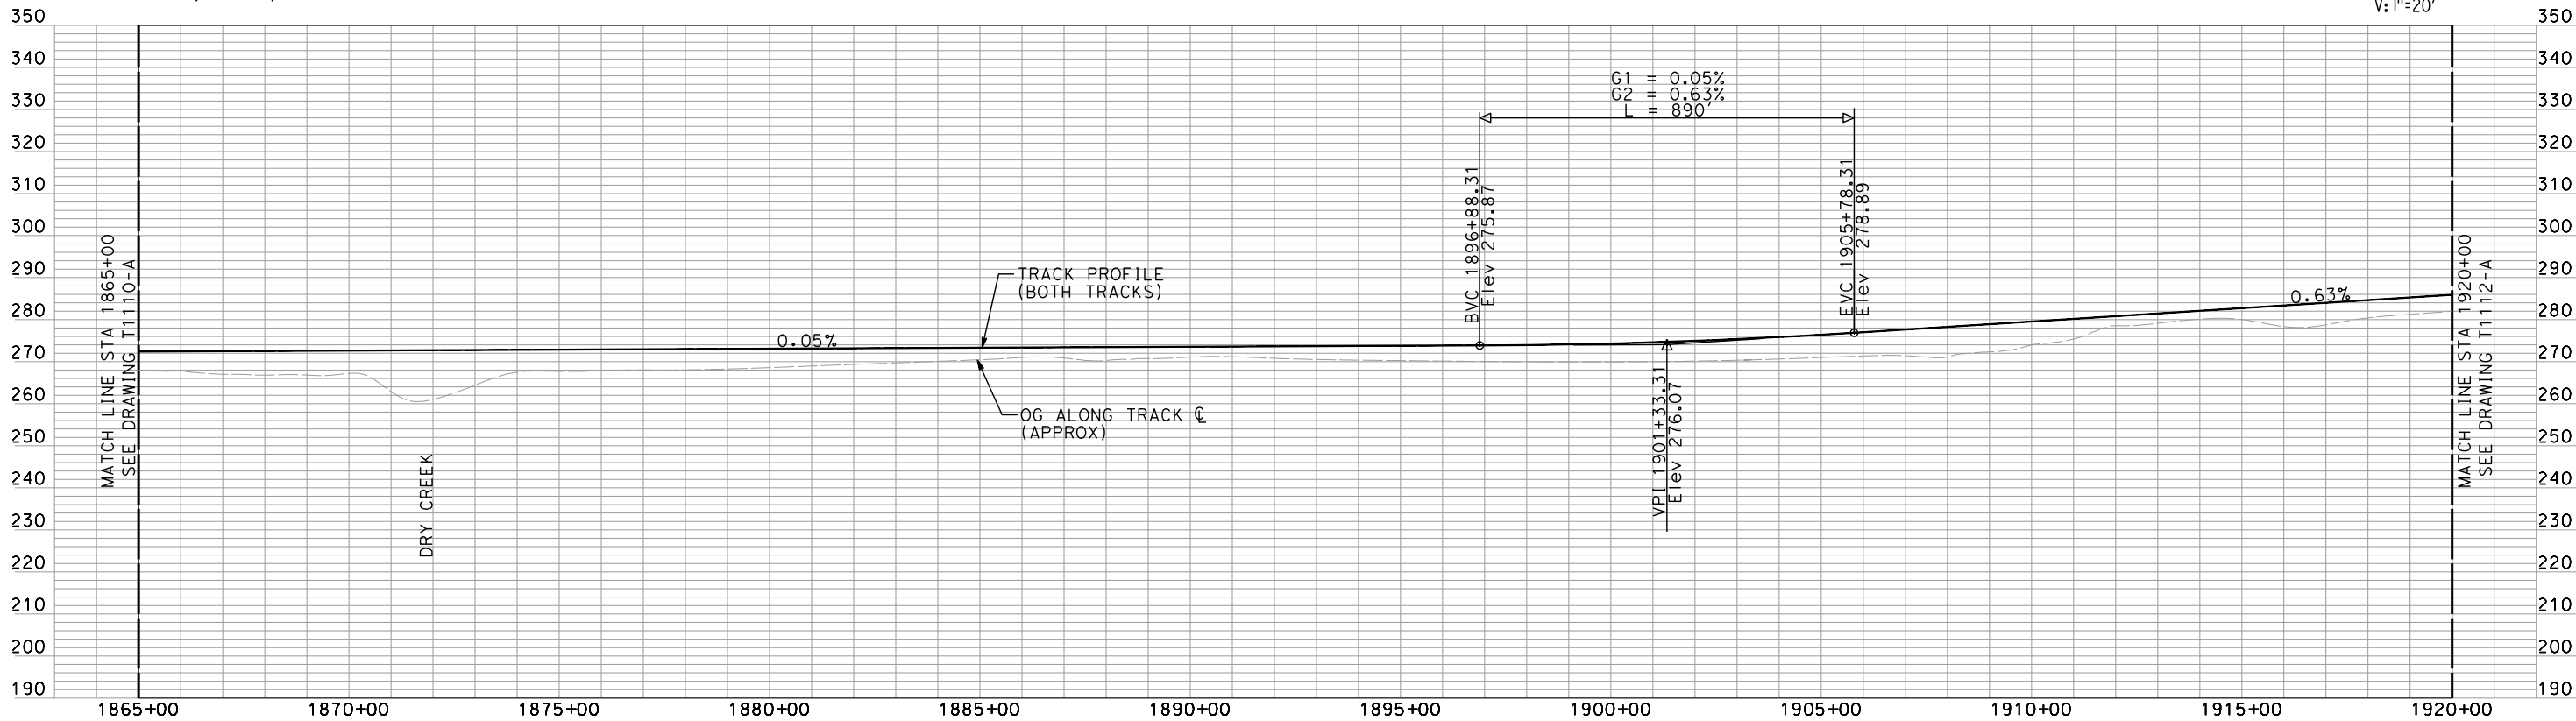
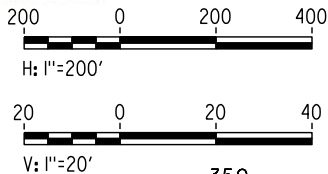


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shieldsa



- NOTES:
1. ALL UTILITIES SHOWN ARE EXISTING UTILITY LINES BASED ON RECORD DRAWINGS AND ARE SHOWN FOR INFORMATIONAL PURPOSES ONLY.
  2. TRACKS CLOSER THAN 102 FT TO THE NEAREST EXISTING FREIGHT TRACKS WILL INCLUDE SAFETY BARRIERS, BERMS, OR WALLS AS REQUIRED.

PLAN



PROFILE

"SEE T3000-T3017 DRAWINGS FOR  
TYPICAL SECTION LIMITS AND DETAILS"

REV	DATE	BY	CHK	APP	DESCRIPTION
1	02/21/12				NOISE BARRIER LIMITS

DESIGNED BY  
A. SHIELDS  
DRAWN BY  
H. SULLIVAN  
CHECKED BY  
A. BOONE  
IN CHARGE  
A. BOONE  
DATE  
07/27/2011

RECORD SET  
15% DESIGN  
SUBMITTAL

NOT FOR  
CONSTRUCTION

**AECOM**  
Technical Services, Inc.  
2020 L Street, Suite 300  
Sacramento, CA 95811  
**CH2MHILL**



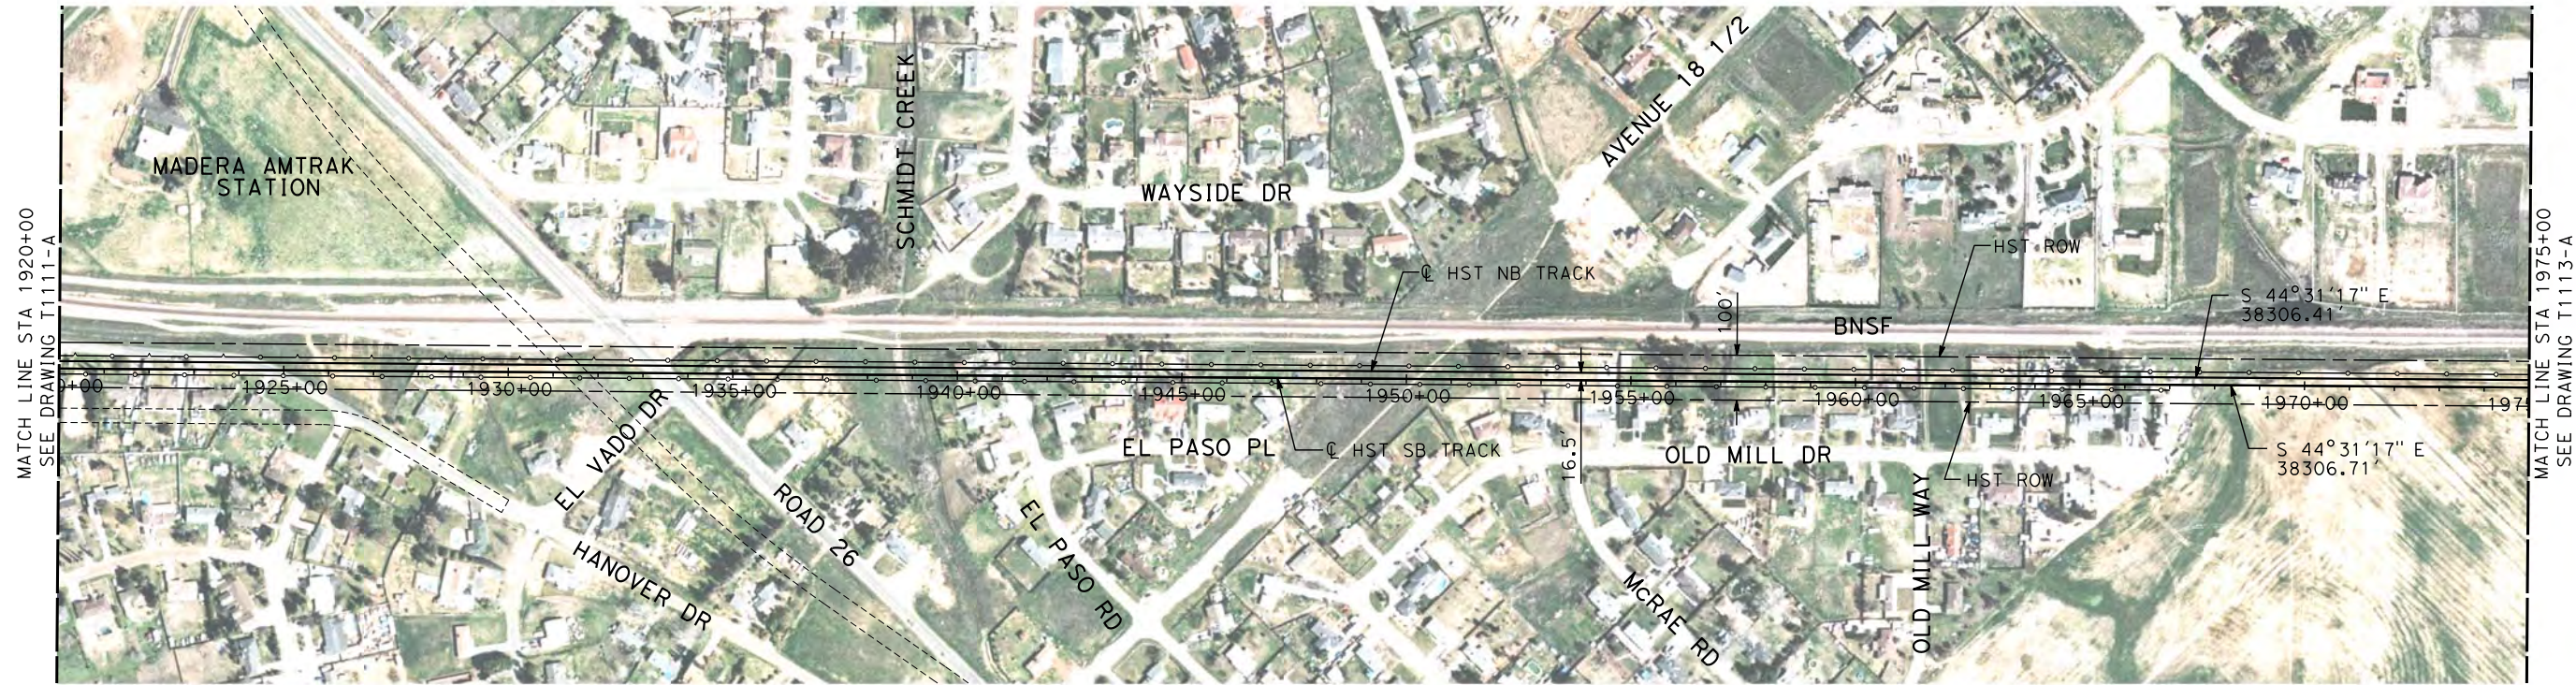
**CALIFORNIA HIGH-SPEED TRAIN PROJECT  
MERCED TO FRESNO**  
HYBRID

PLAN AND PROFILE  
STA 1865+00 TO STA 1920+00

CONTRACT NO.  
HSR06-007  
DRAWING NO.  
T1111-A  
SCALE  
AS SHOWN  
SHEET NO.  
### OF ###

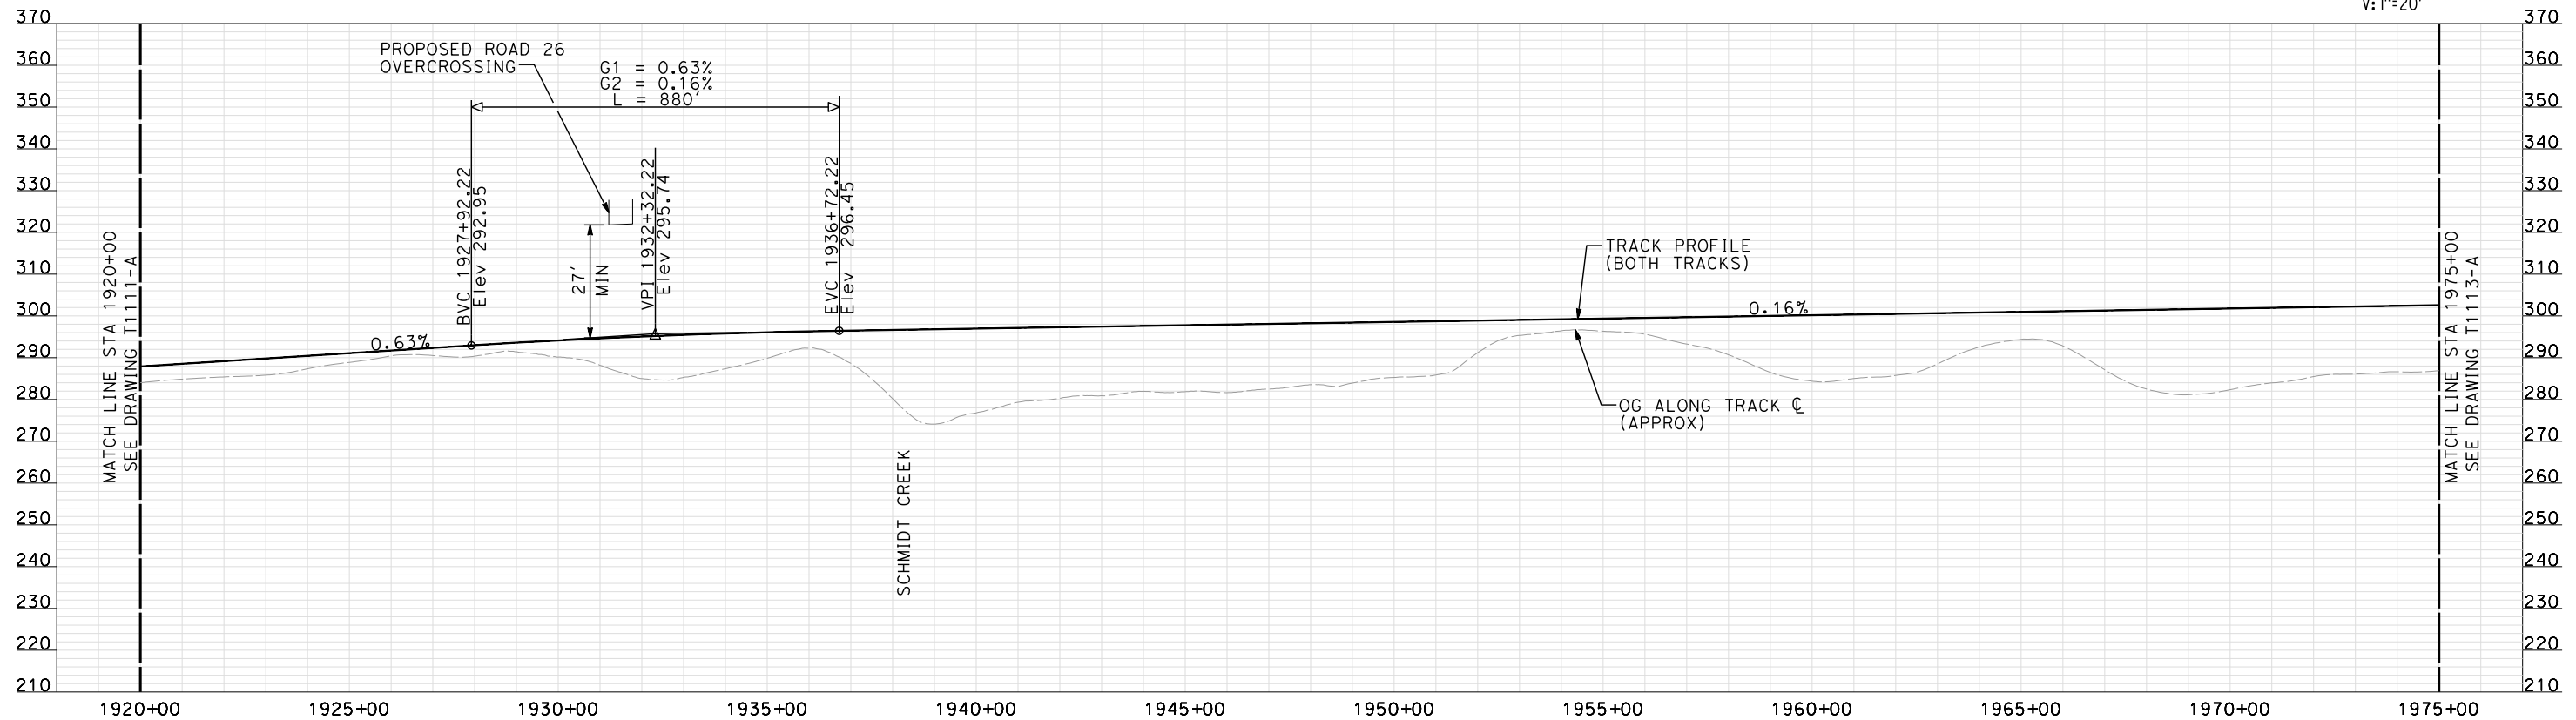
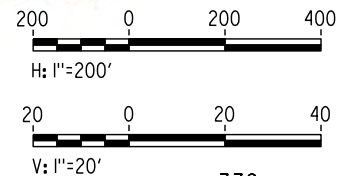


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NOTE:  
ALL UTILITIES SHOWN ARE EXISTING UTILITY LINES  
BASED ON RECORD DRAWINGS AND ARE SHOWN FOR  
INFORMATIONAL PURPOSES ONLY.

PLAN



PROFILE

"SEE T3000-T3017 DRAWINGS FOR  
TYPICAL SECTION LIMITS AND DETAILS"

REV	DATE	BY	CHK	APP	DESCRIPTION

DESIGNED BY A. SHIELDS
DRAWN BY H. SULLIVAN
CHECKED BY A. BOONE
IN CHARGE A. BOONE
DATE 02/17/2012

RECORD SET  
15% DESIGN  
SUBMITTAL

NOT FOR  
CONSTRUCTION

**AECOM**  
Technical Services, Inc.  
2020 L Street, Suite 300  
Sacramento, CA 95811  
**CH2MHILL**



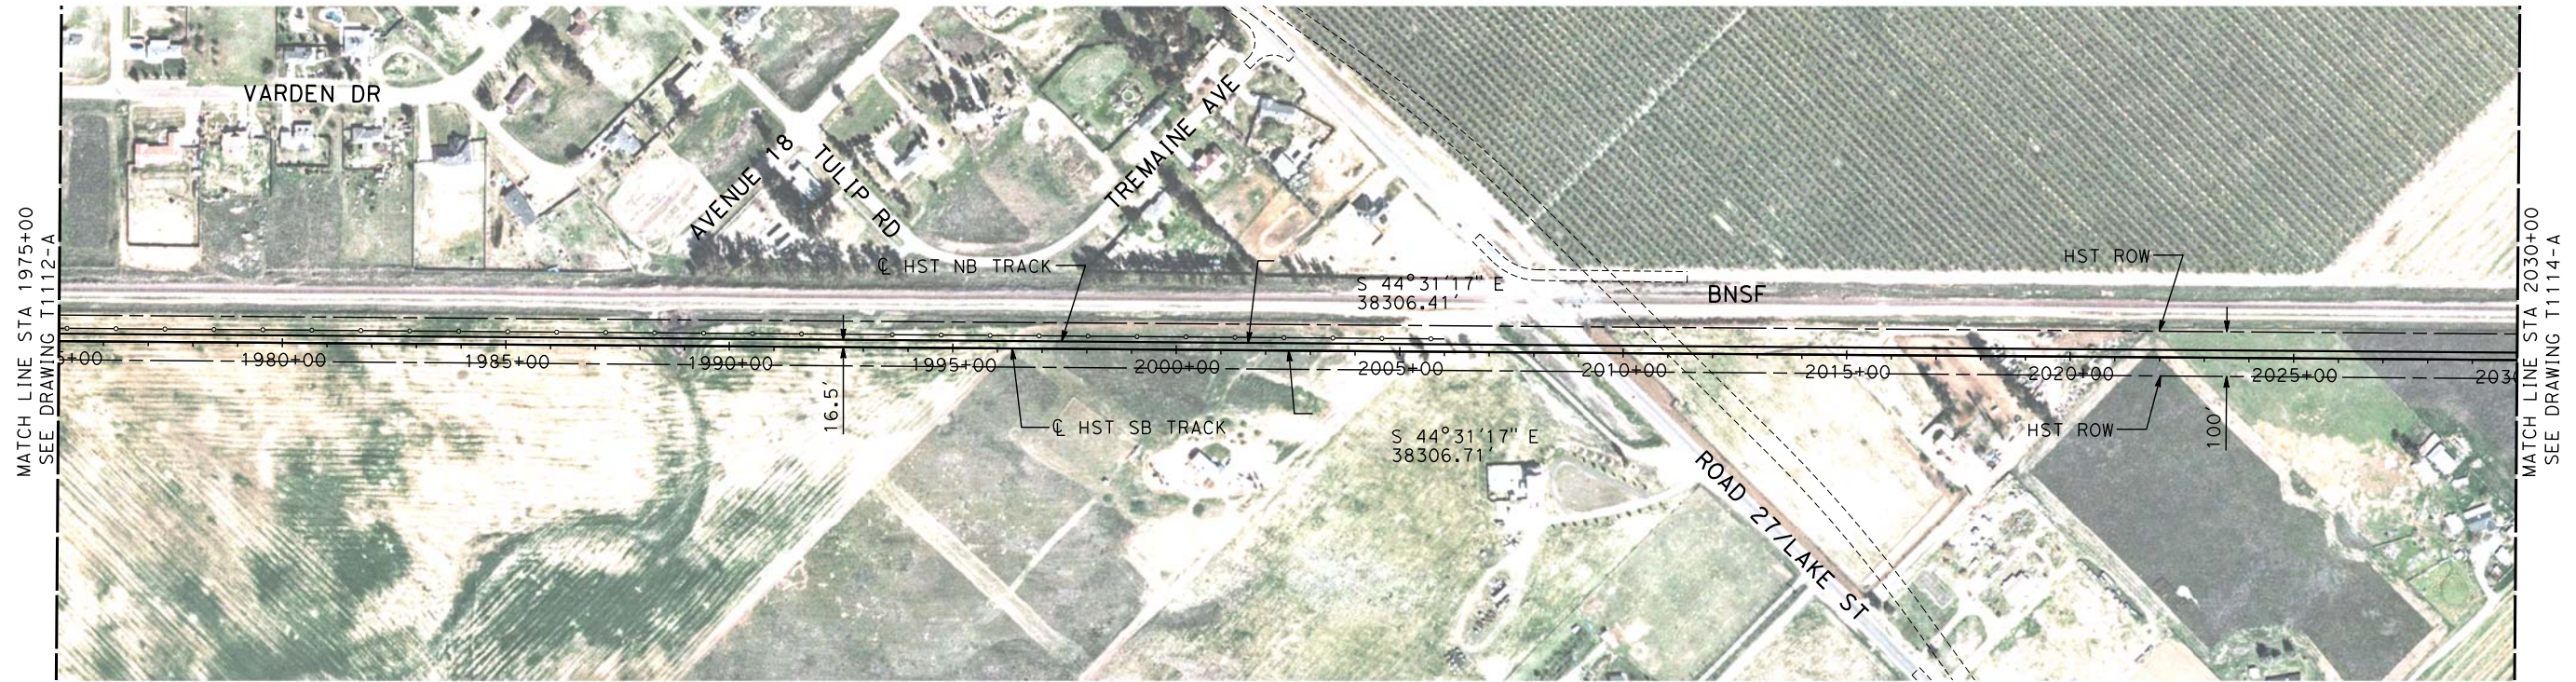
**CALIFORNIA HIGH-SPEED TRAIN PROJECT**  
**MERCED TO FRESNO**  
HYBRID

PLAN AND PROFILE  
STA 1920+00 TO STA 1975+00

CONTRACT NO. HSR06-007
DRAWING NO. T1112-A
SCALE AS SHOWN
SHEET NO. ### OF ###

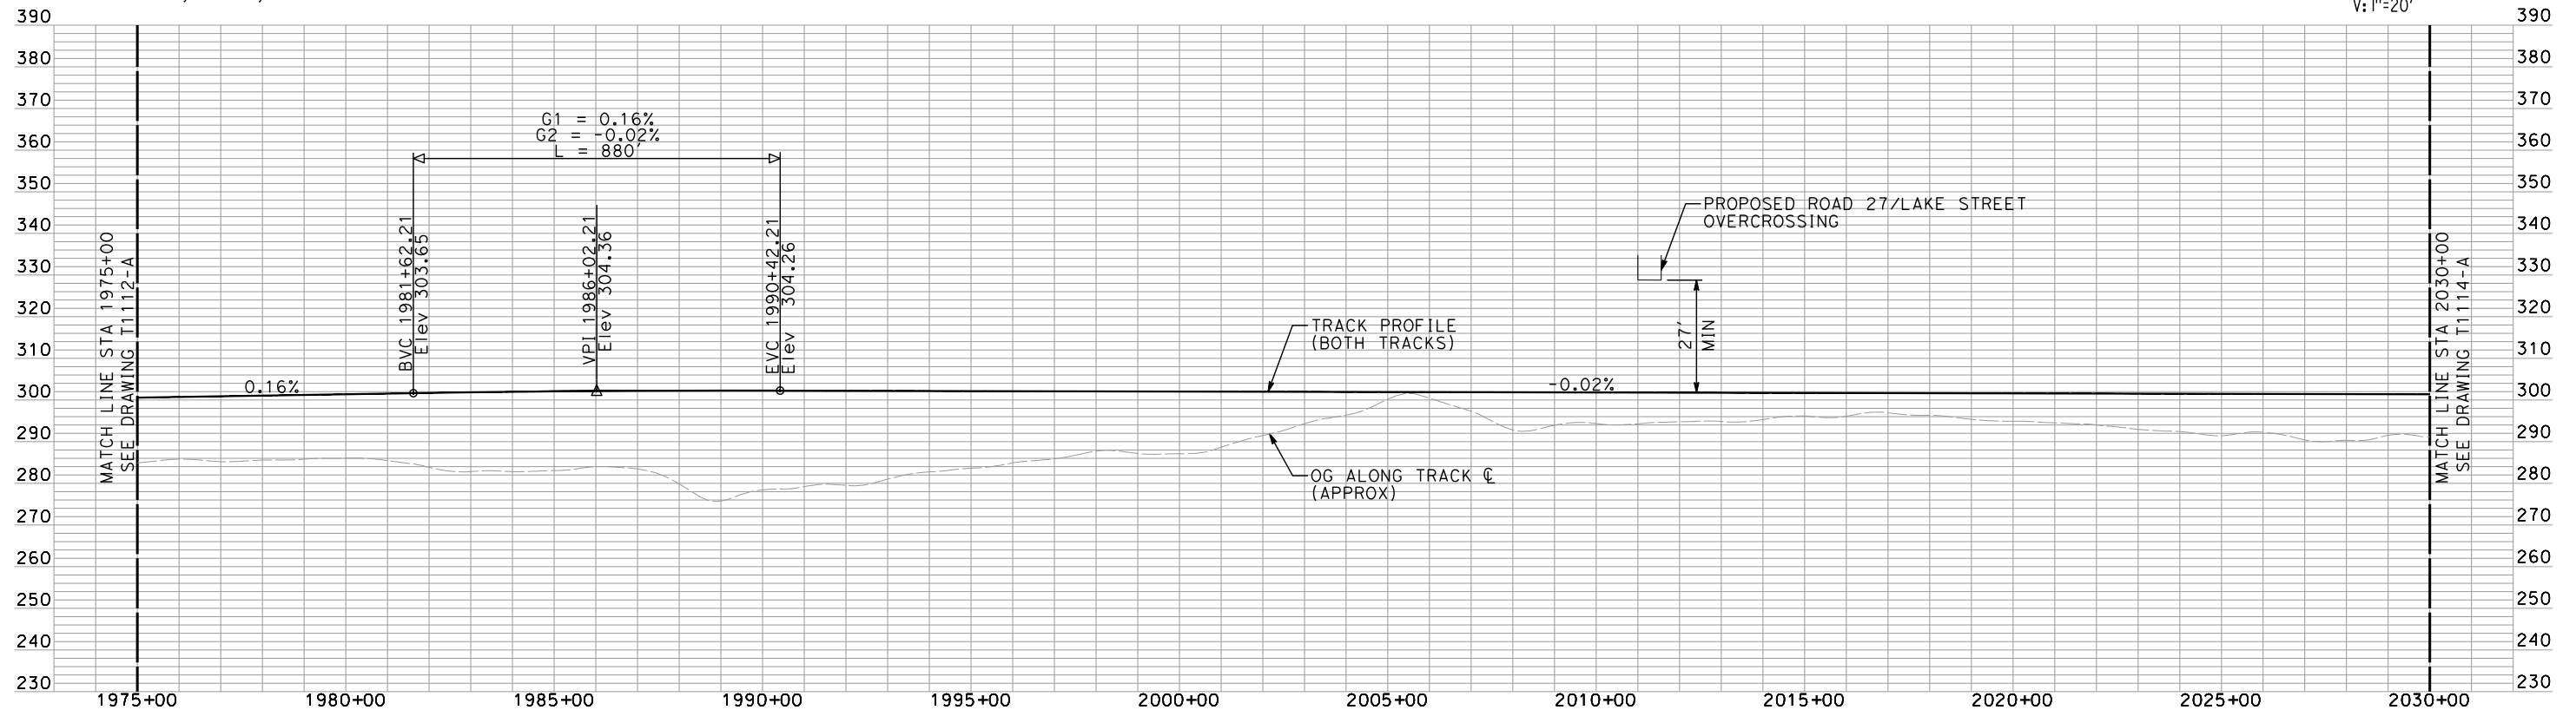
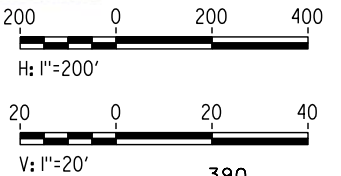


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shieldsa



- NOTES:
1. ALL UTILITIES SHOWN ARE EXISTING UTILITY LINES BASED ON RECORD DRAWINGS AND ARE SHOWN FOR INFORMATIONAL PURPOSES ONLY.
  2. TRACKS CLOSER THAN 102 FT TO THE NEAREST EXISTING FREIGHT TRACKS WILL INCLUDE SAFETY BARRIERS, BERMS, OR WALLS AS REQUIRED.

PLAN



PROFILE

"SEE T3000-T3017 DRAWINGS FOR  
TYPICAL SECTION LIMITS AND DETAILS"

REV	DATE	BY	CHK	APP	DESCRIPTION
1	02/17/12				NOISE BARRIER LIMITS

DESIGNED BY  
A. SHIELDS  
DRAWN BY  
H. SULLIVAN  
CHECKED BY  
A. BOONE  
IN CHARGE  
A. BOONE  
DATE  
07/27/2011

RECORD SET  
15% DESIGN  
SUBMITTAL  
  
NOT FOR  
CONSTRUCTION

**AECOM**  
Technical Services, Inc.  
2020 L Street, Suite 300  
Sacramento, CA 95811  
**CH2MHILL**



**CALIFORNIA HIGH-SPEED TRAIN PROJECT  
MERCED TO FRESNO**

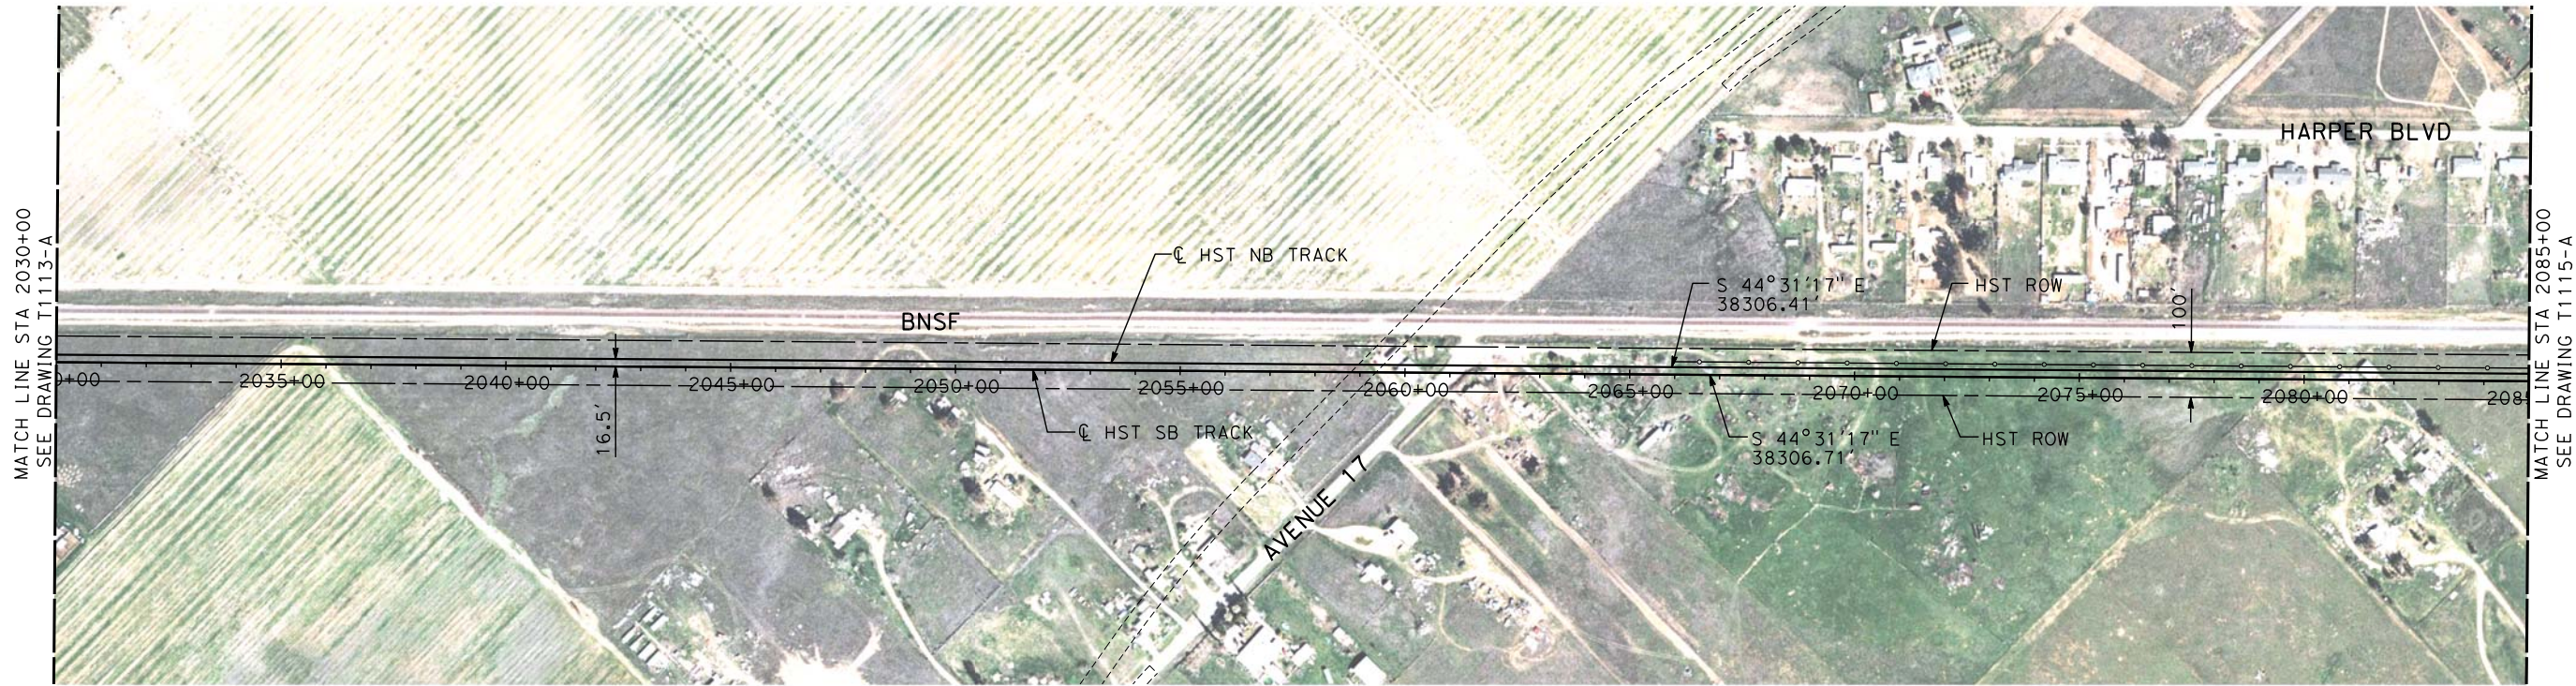
HYBRID

PLAN AND PROFILE  
STA 1975+00 TO STA 2030+00

CONTRACT NO.  
HSR06-007  
DRAWING NO.  
T1113-A  
SCALE  
AS SHOWN  
SHEET NO.  
### OF ###

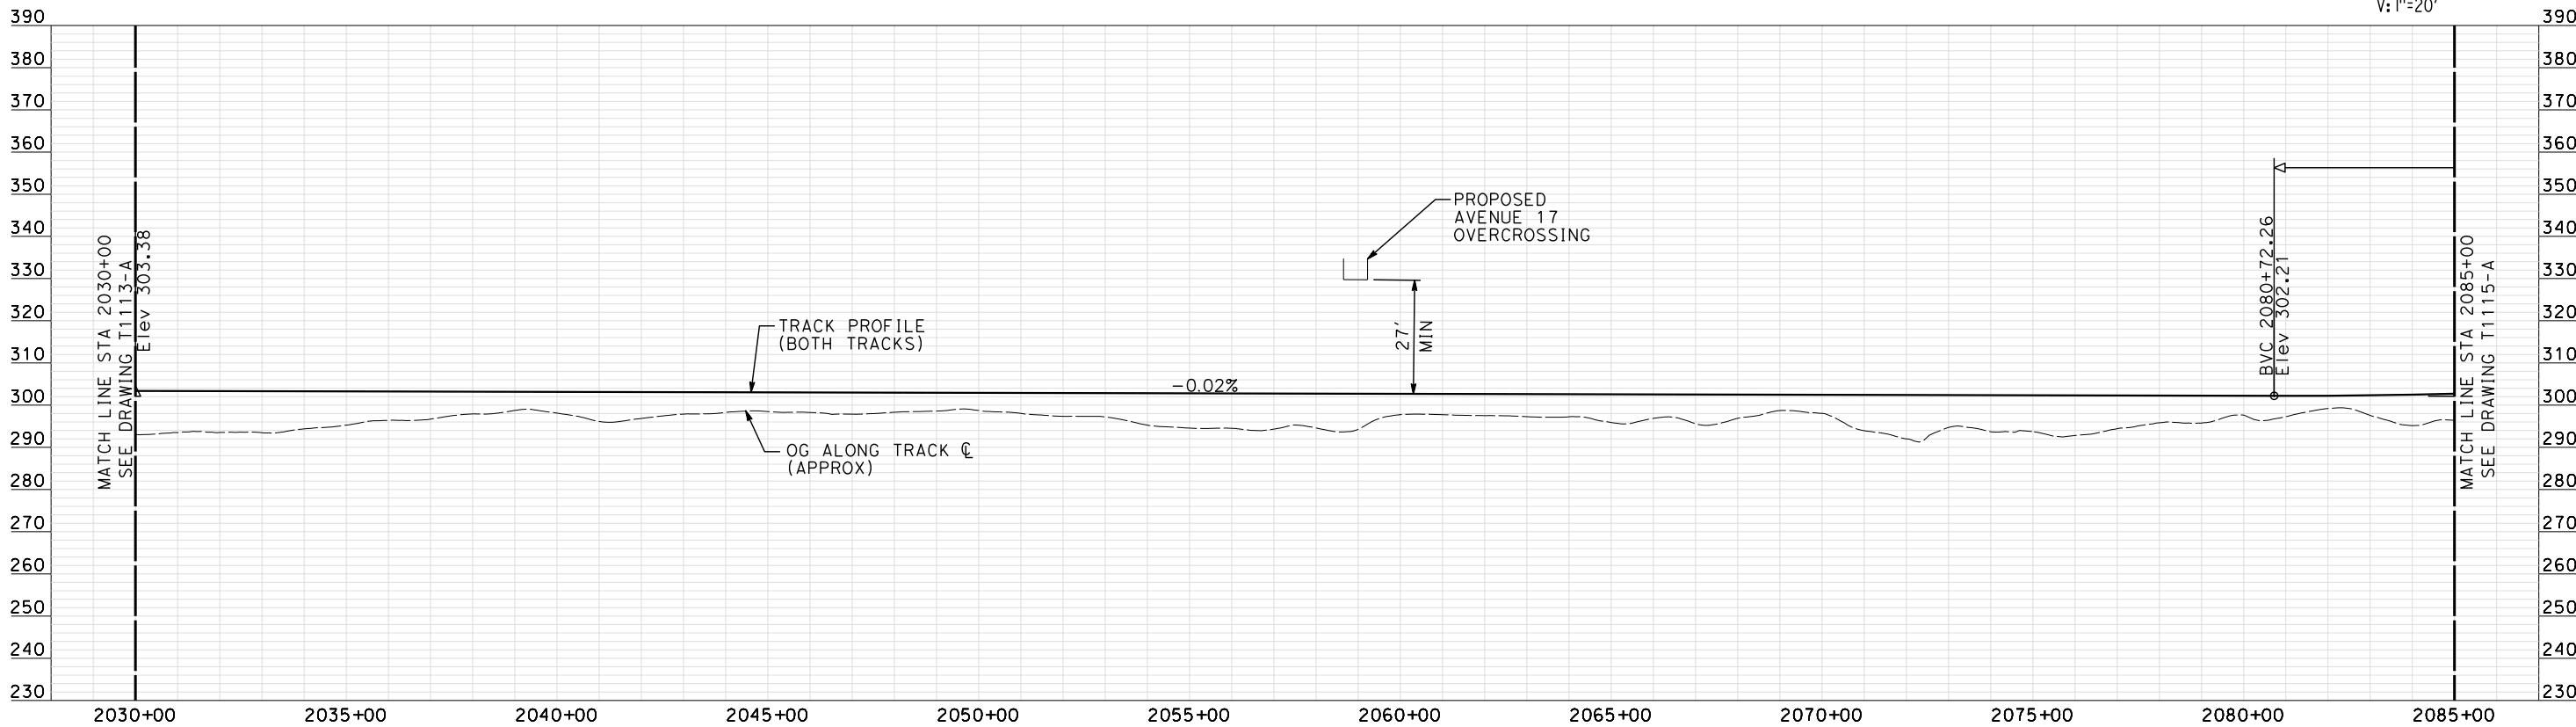
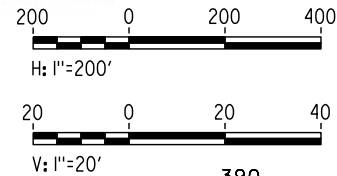


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shieldsa



NOTE:  
ALL UTILITIES SHOWN ARE EXISTING UTILITY LINES  
BASED ON RECORD DRAWINGS AND ARE SHOWN FOR  
INFORMATIONAL PURPOSES ONLY.

PLAN



PROFILE

"SEE T3000-T3017 DRAWINGS FOR  
TYPICAL SECTION LIMITS AND DETAILS"

REV	DATE	BY	CHK	APP	DESCRIPTION
1	02/21/2012	AS			SR 145 REDESIGN

DESIGNED BY A. SHIELDS
DRAWN BY H. SULLIVAN
CHECKED BY A. BOONE
IN CHARGE A. BOONE
DATE 07/27/2011

RECORD SET  
15% DESIGN  
SUBMITTAL

NOT FOR  
CONSTRUCTION

**AECOM**  
Technical Services, Inc.  
2020 L Street, Suite 300  
Sacramento, CA 95811  
**CH2MHILL**



**CALIFORNIA**  
HIGH-SPEED RAIL AUTHORITY

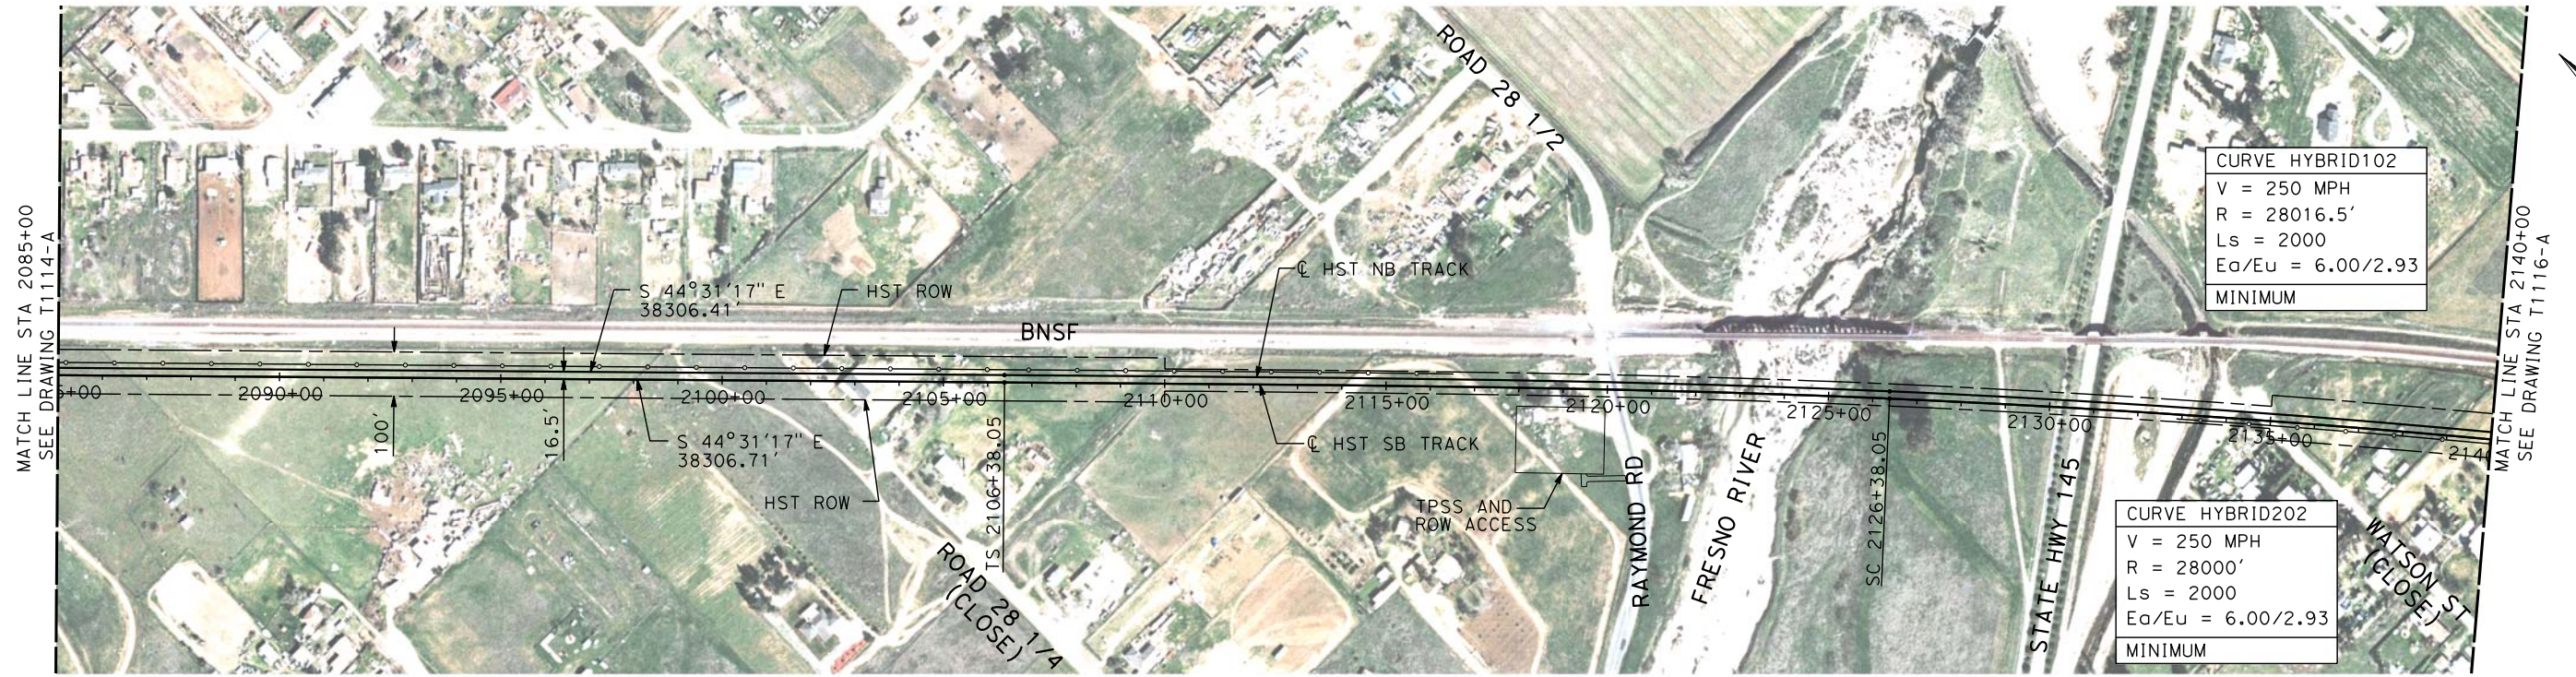
**CALIFORNIA HIGH-SPEED TRAIN PROJECT  
MERCED TO FRESNO**  
HYBRID

PLAN AND PROFILE  
STA 2030+00 TO STA 2085+00

CONTRACT NO. HSR06-007
DRAWING NO. T1114-A
SCALE AS SHOWN
SHEET NO. ### OF ###

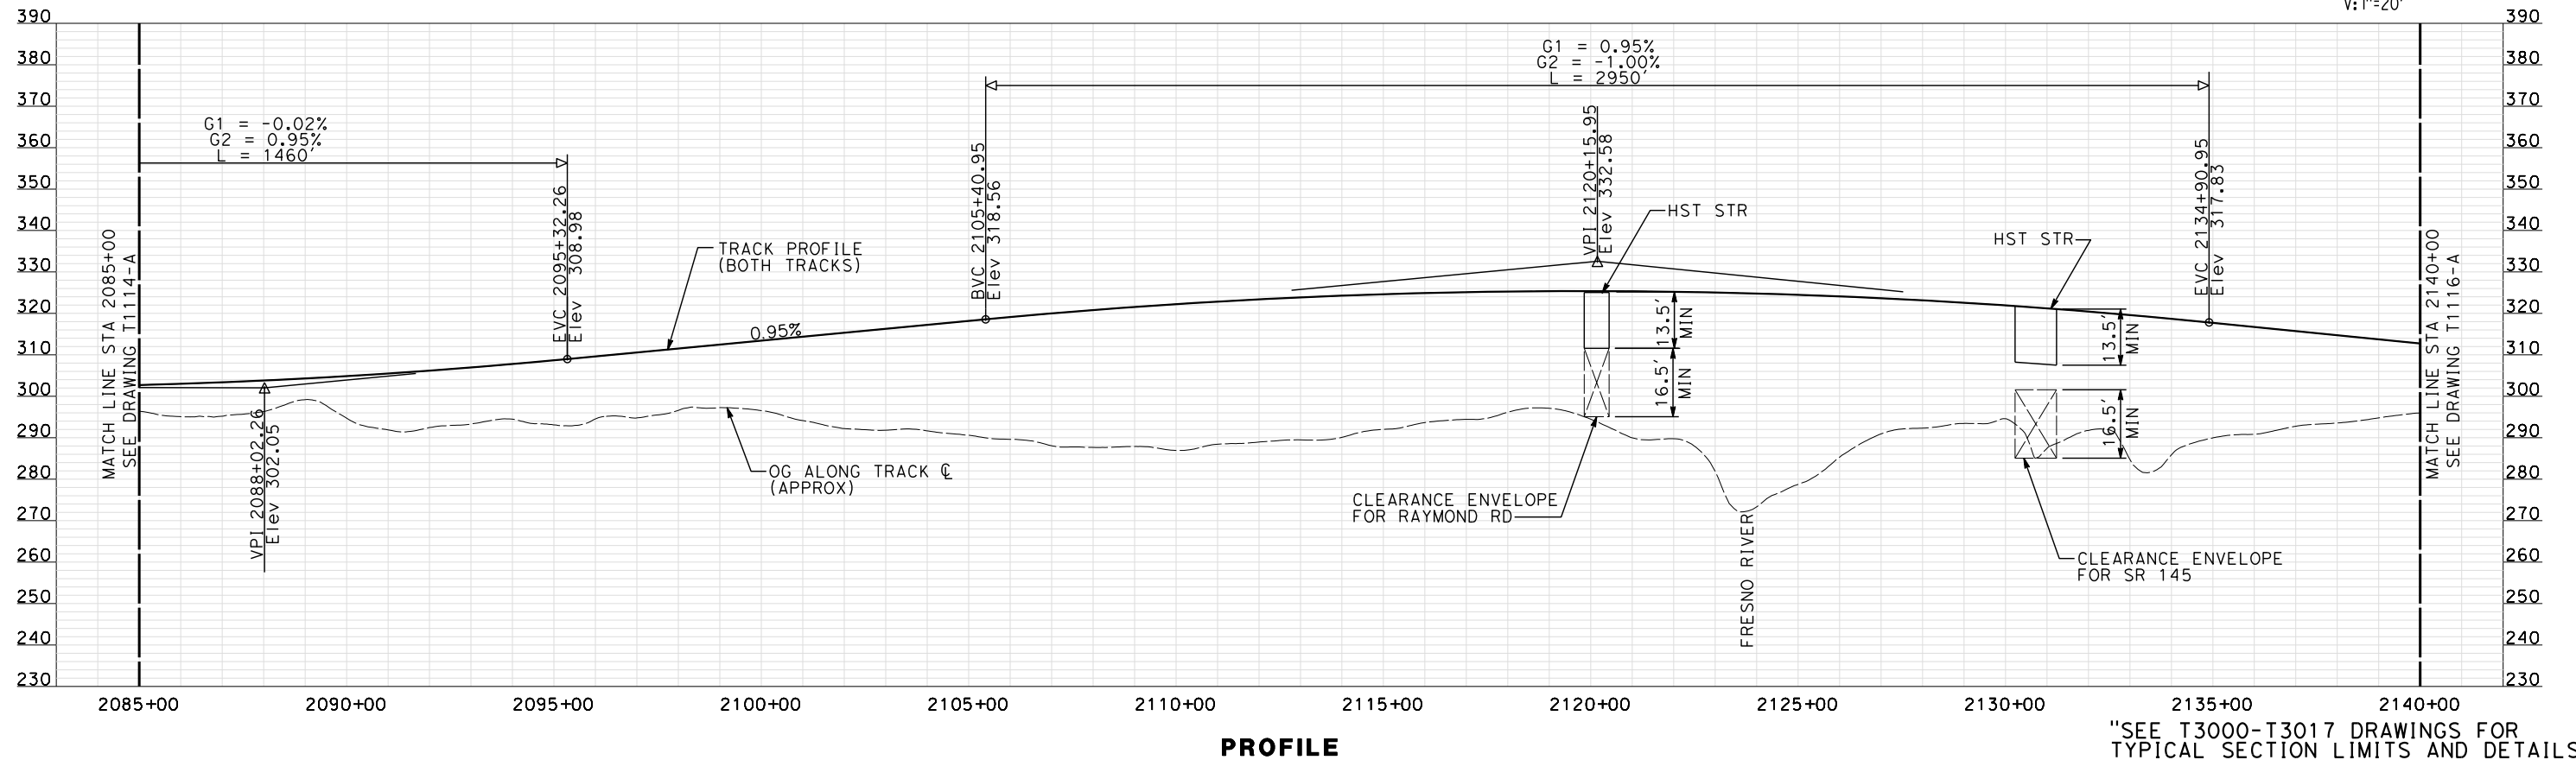
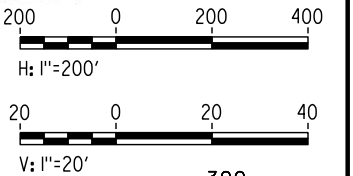


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shieldsa




NOTE:  
ALL UTILITIES SHOWN ARE EXISTING UTILITY LINES  
BASED ON RECORD DRAWINGS AND ARE SHOWN FOR  
INFORMATIONAL PURPOSES ONLY.

PLAN

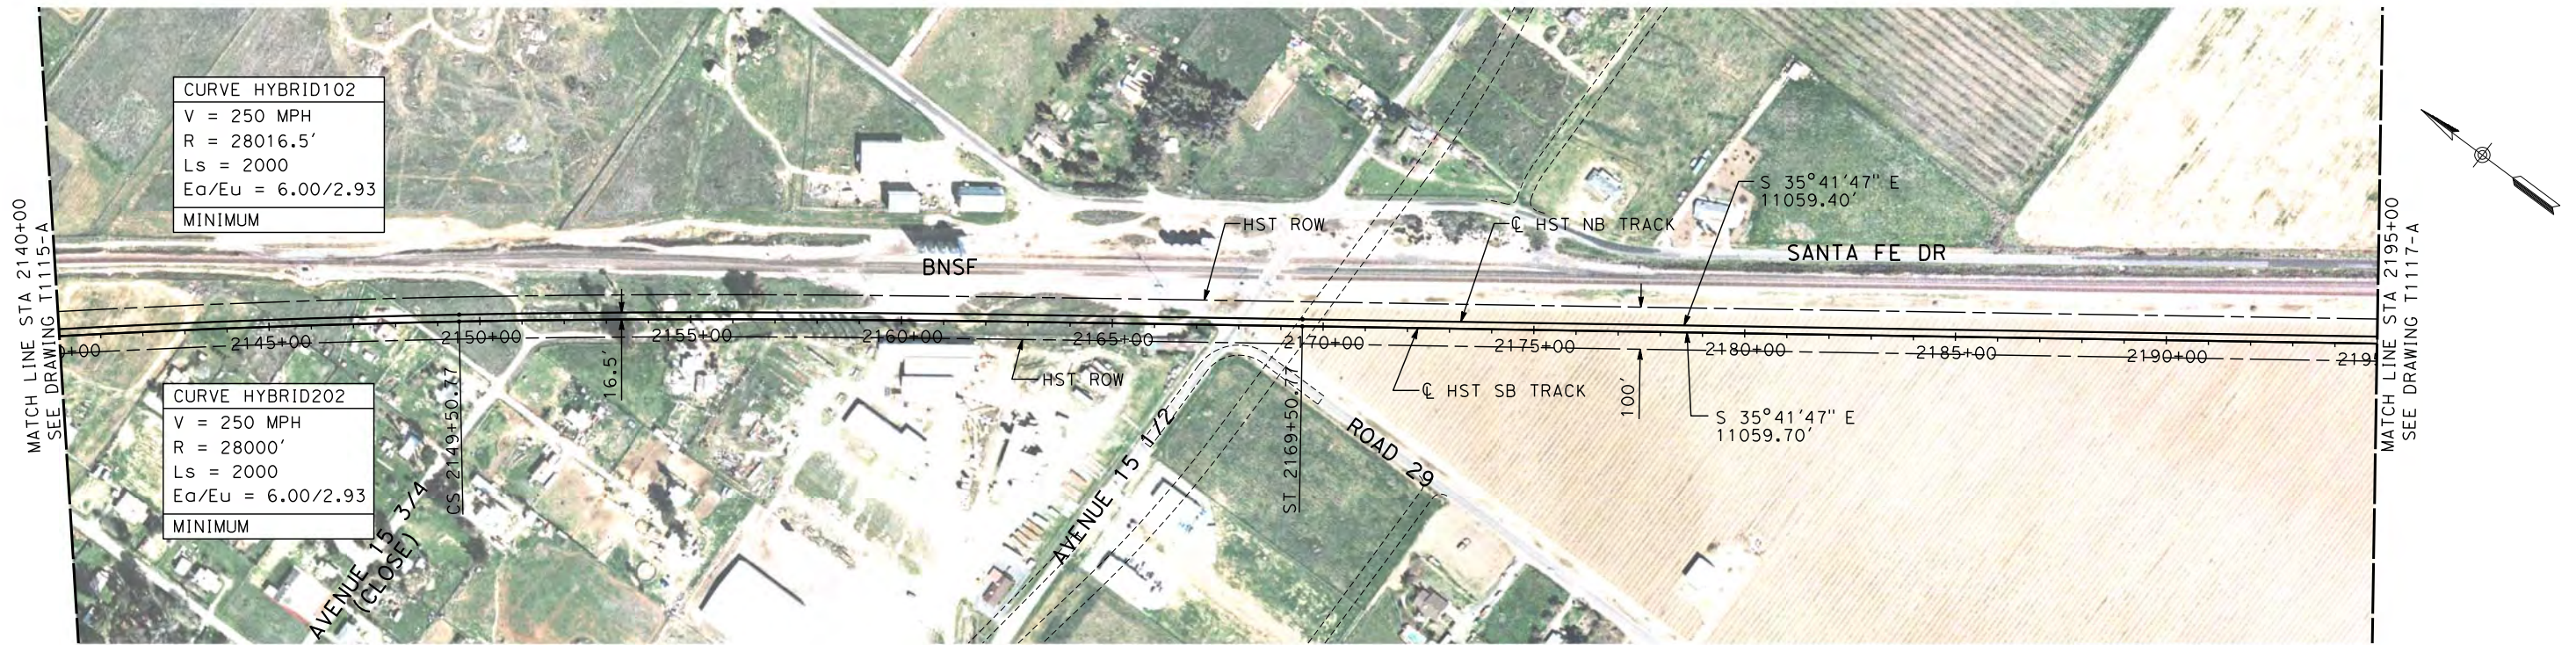


"SEE T3000-T3017 DRAWINGS FOR  
TYPICAL SECTION LIMITS AND DETAILS"

						DESIGNED BY A. SHIELDS	RECORD SET 15% DESIGN SUBMITTAL	<div><div><div>AECOM</div><div>Technical Services, Inc.</div><div>2020 L Street, Suite 300 Sacramento, CA 95811</div></div><div><div>CH2MHILL</div></div></div>	<div><div></div><div><div>CALIFORNIA</div><div>HIGH-SPEED RAIL AUTHORITY</div></div></div>	CALIFORNIA HIGH-SPEED TRAIN PROJECT MERCED TO FRESNO  HYBRID  PLAN AND PROFILE STA 2085+00 TO STA 2140+00		CONTRACT NO. HSR06-007
DRAWN BY H. SULLIVAN	DRAWING NO. T1115-A											
CHECKED BY A. BOONE	SCALE AS SHOWN											
IN CHARGE A. BOONE	SHEET NO. ### OF ###											
DATE 07/27/2011												
11	002/017/2012	AS			SR 145 REDESIGN							
REV	DATE	BY	CHK	APP	DESCRIPTION							

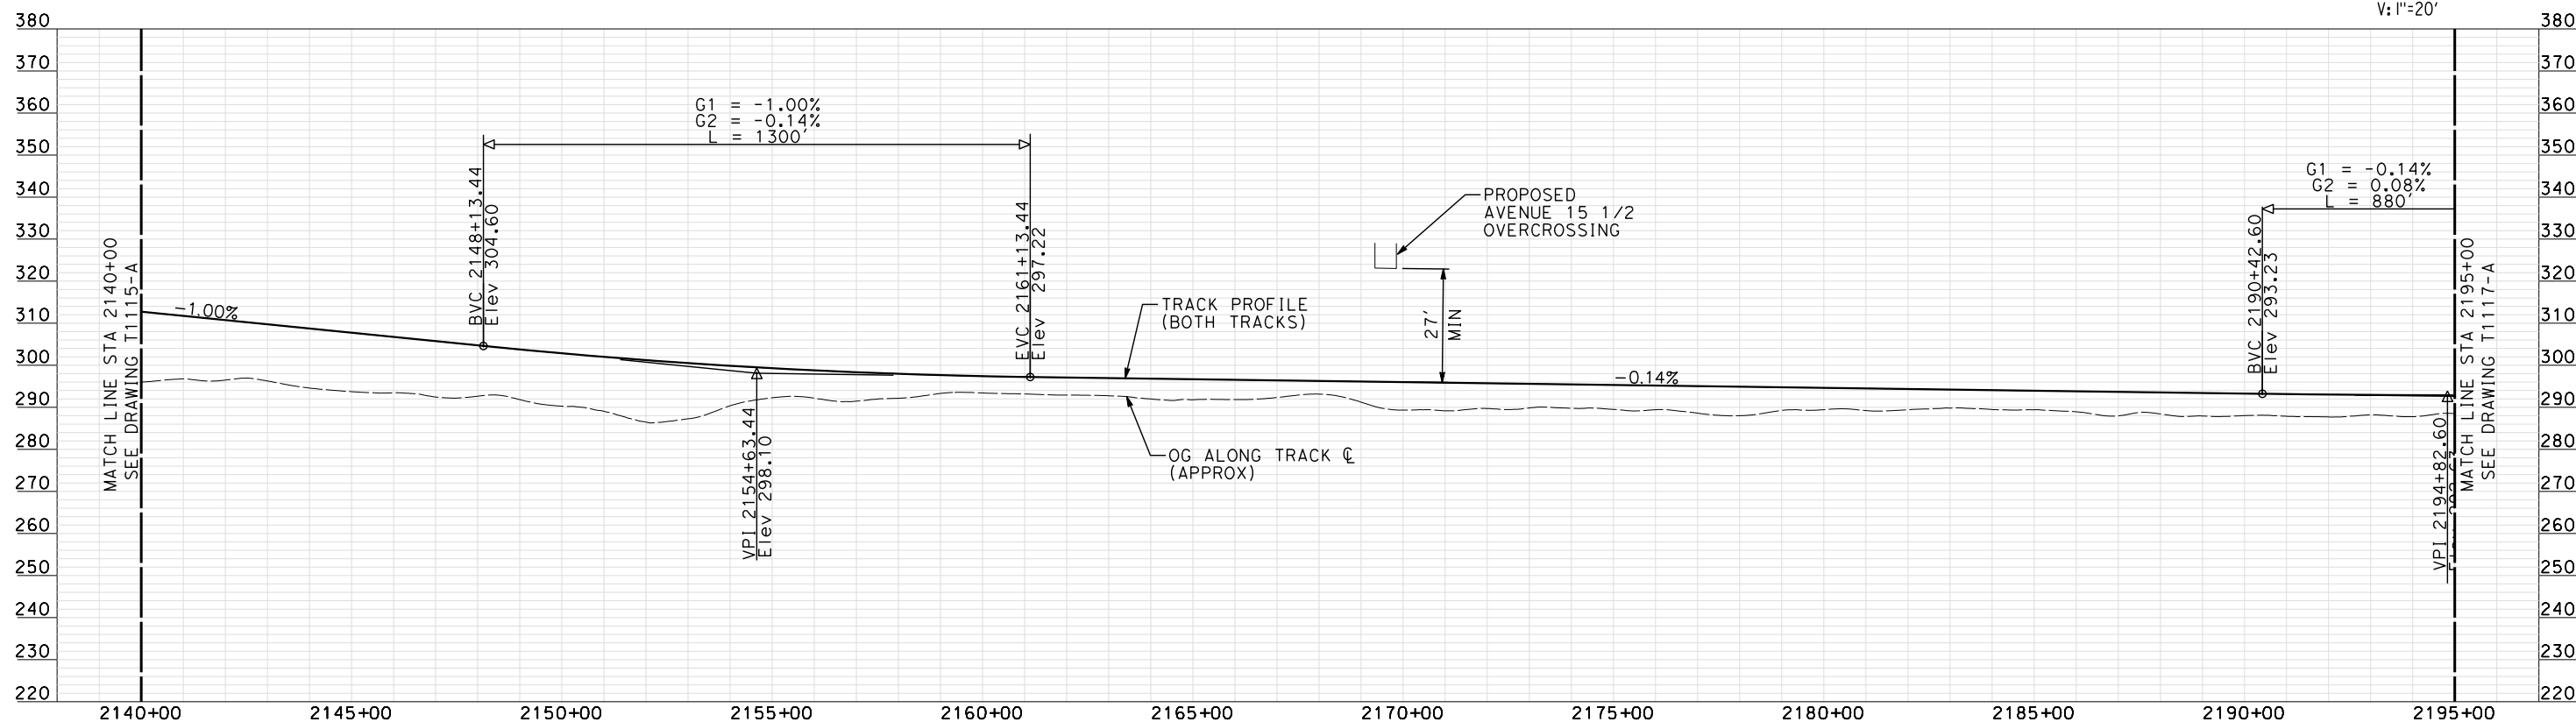
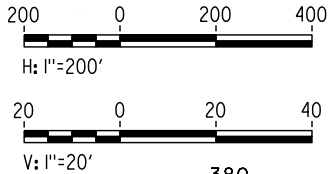


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shieldsa






PLAN

NOTE:  
ALL UTILITIES SHOWN ARE EXISTING UTILITY LINES  
BASED ON RECORD DRAWINGS AND ARE SHOWN FOR  
INFORMATIONAL PURPOSES ONLY.



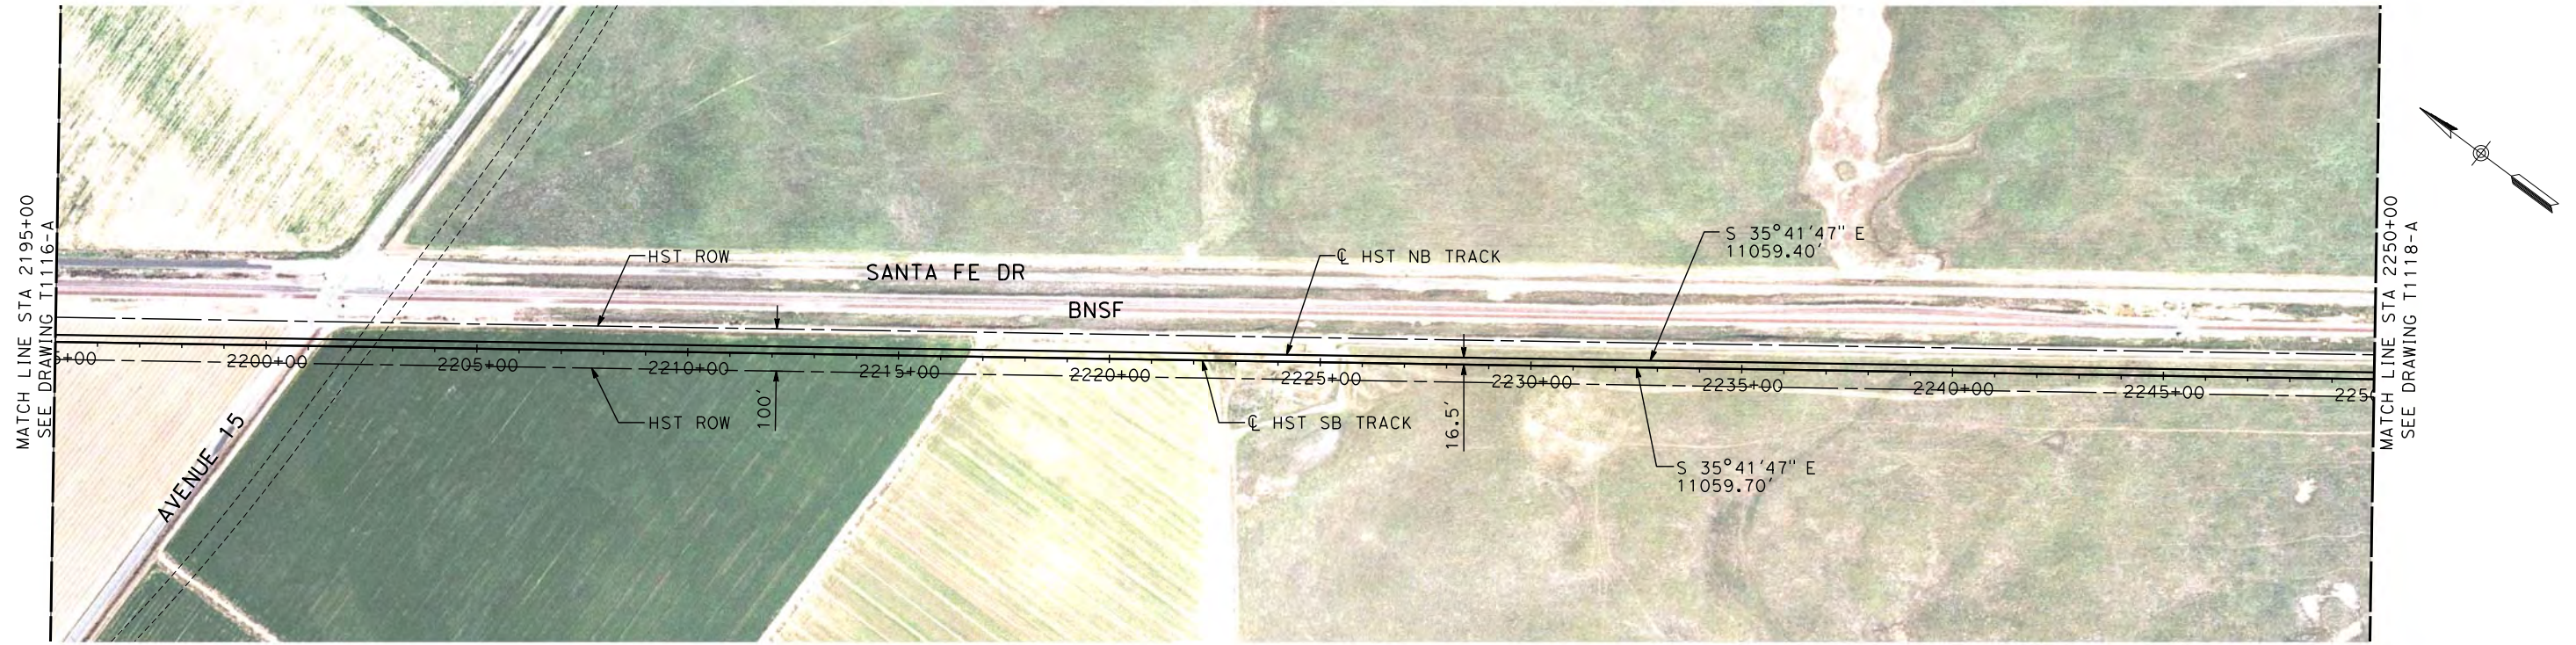
PROFILE

"SEE T3000-T3017 DRAWINGS FOR  
TYPICAL SECTION LIMITS AND DETAILS"

						DESIGNED BY A. SHIELDS	RECORD SET 15% DESIGN SUBMITTAL  NOT FOR CONSTRUCTION	<div> Technical Services, Inc. 2020 L Street, Suite 300 Sacramento, CA 95811</div> <div></div>	<div> CALIFORNIA HIGH-SPEED RAIL AUTHORITY</div>	CALIFORNIA HIGH-SPEED TRAIN PROJECT MERCED TO FRESNO HYBRID				CONTRACT NO. HSR06-007
					DRAWN BY H. SULLIVAN	DRAWING NO. T1116-A								
					CHECKED BY A. BOONE	SCALE AS SHOWN								
					IN CHARGE A. BOONE	SHEET NO. ### OF ###								
1	02/12/12				TRACK REALIGNMENT / SR 145 REDESIGN	DATE 02/17/2012								
REV	DATE	BY	CHK	APP	DESCRIPTION									

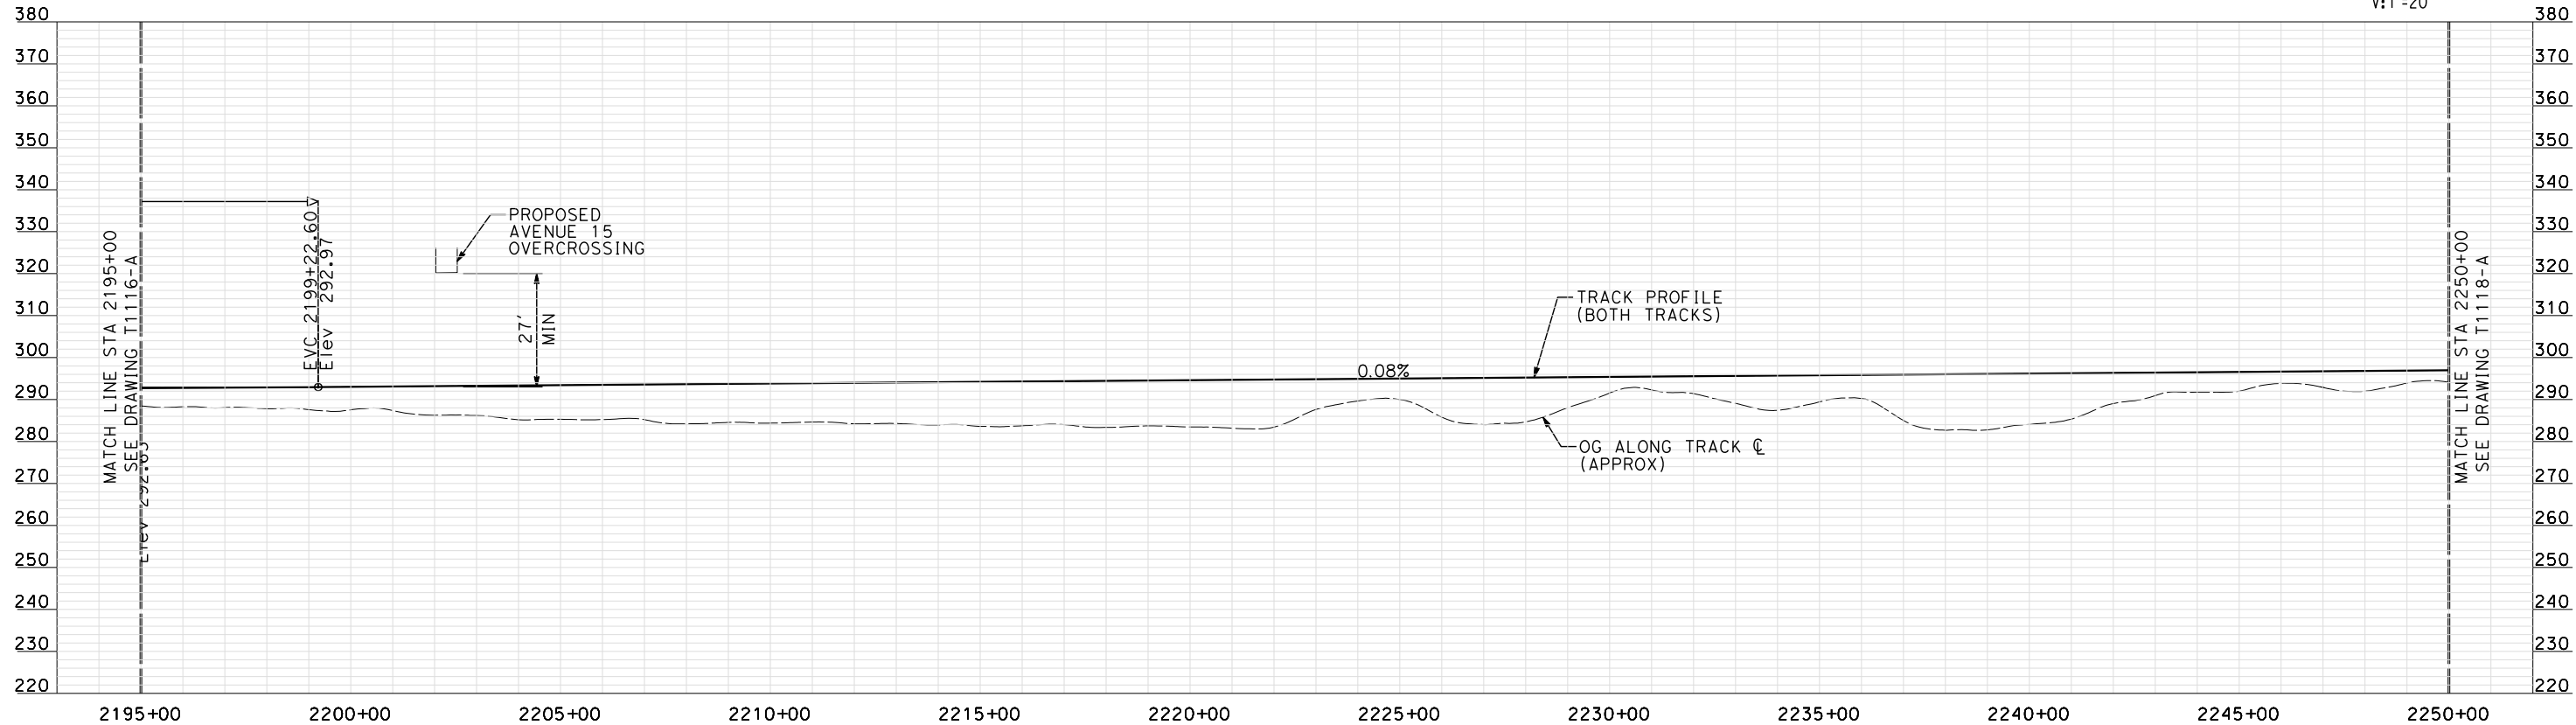


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


PLAN

NOTE:  
ALL UTILITIES SHOWN ARE EXISTING UTILITY LINES  
BASED ON RECORD DRAWINGS AND ARE SHOWN FOR  
INFORMATIONAL PURPOSES ONLY.



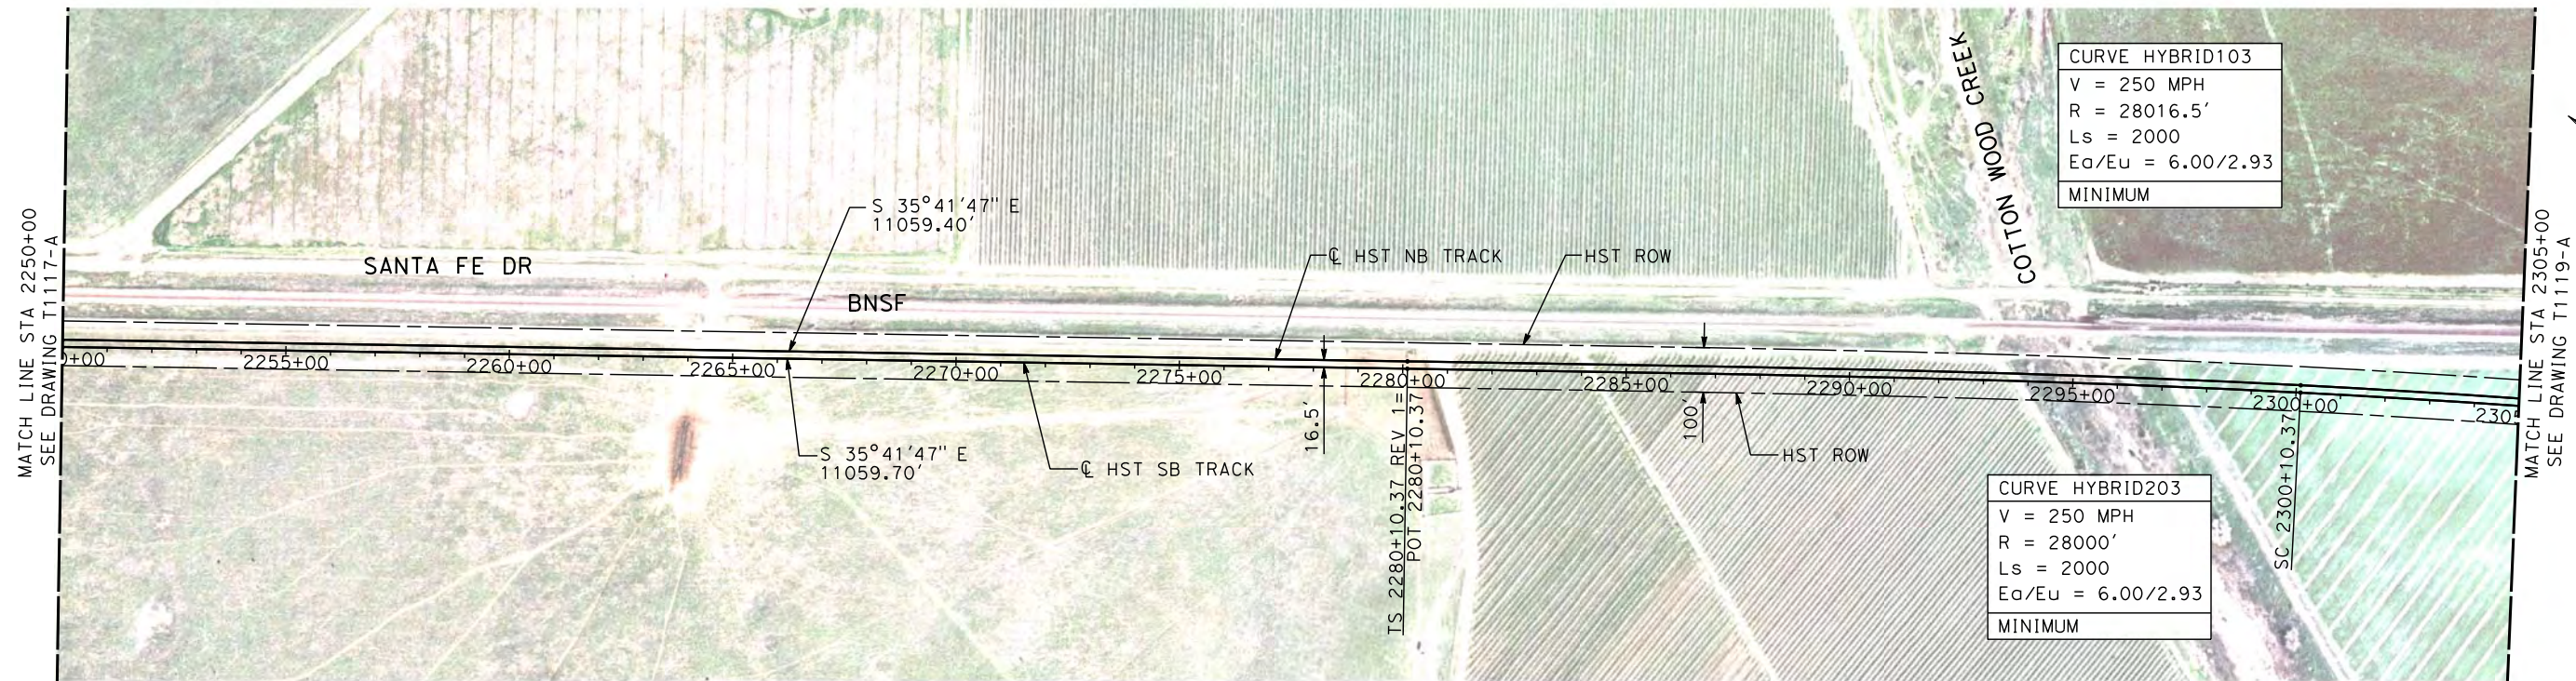
PROFILE

"SEE T3000-T3017 DRAWINGS FOR  
TYPICAL SECTION LIMITS AND DETAILS"

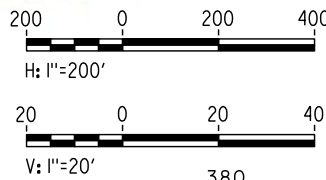
					DESIGNED BY A. SHIELDS	RECORD SET 15% DESIGN SUBMITTAL  NOT FOR CONSTRUCTION	 Technical Services, Inc. 2020 L Street, Suite 300 Sacramento, CA 95811 	 CALIFORNIA HIGH-SPEED RAIL AUTHORITY	CALIFORNIA HIGH-SPEED TRAIN PROJECT MERCED TO FRESNO HYBRID  PLAN AND PROFILE STA 2195+00 TO STA 2250+00		CONTRACT NO. HSR06-007
					DRAWN BY H. SULLIVAN						DRAWING NO. T1117-A
					CHECKED BY A. BOONE						SCALE AS SHOWN
					IN CHARGE A. BOONE						SHEET NO. ### OF ###
1	02/01/2012	AS			DATE 07/27/2011						
REV	DATE	BY	CHK	APP	DESCRIPTION						



1/6/2012 10:50:01 AM \\usscrlfp001\Cadd\CHSR\60022962\Task-03\_Merced-Fresno\CADD\Rail\Design\SHIELDS\Rev 1 - 15% Plans\Hybrid 24 WF-T-1118-A.dgn shieldsa



PLAN



NOTE:  
ALL UTILITIES SHOWN ARE EXISTING UTILITY LINES  
BASED ON RECORD DRAWINGS AND ARE SHOWN FOR  
INFORMATIONAL PURPOSES ONLY.



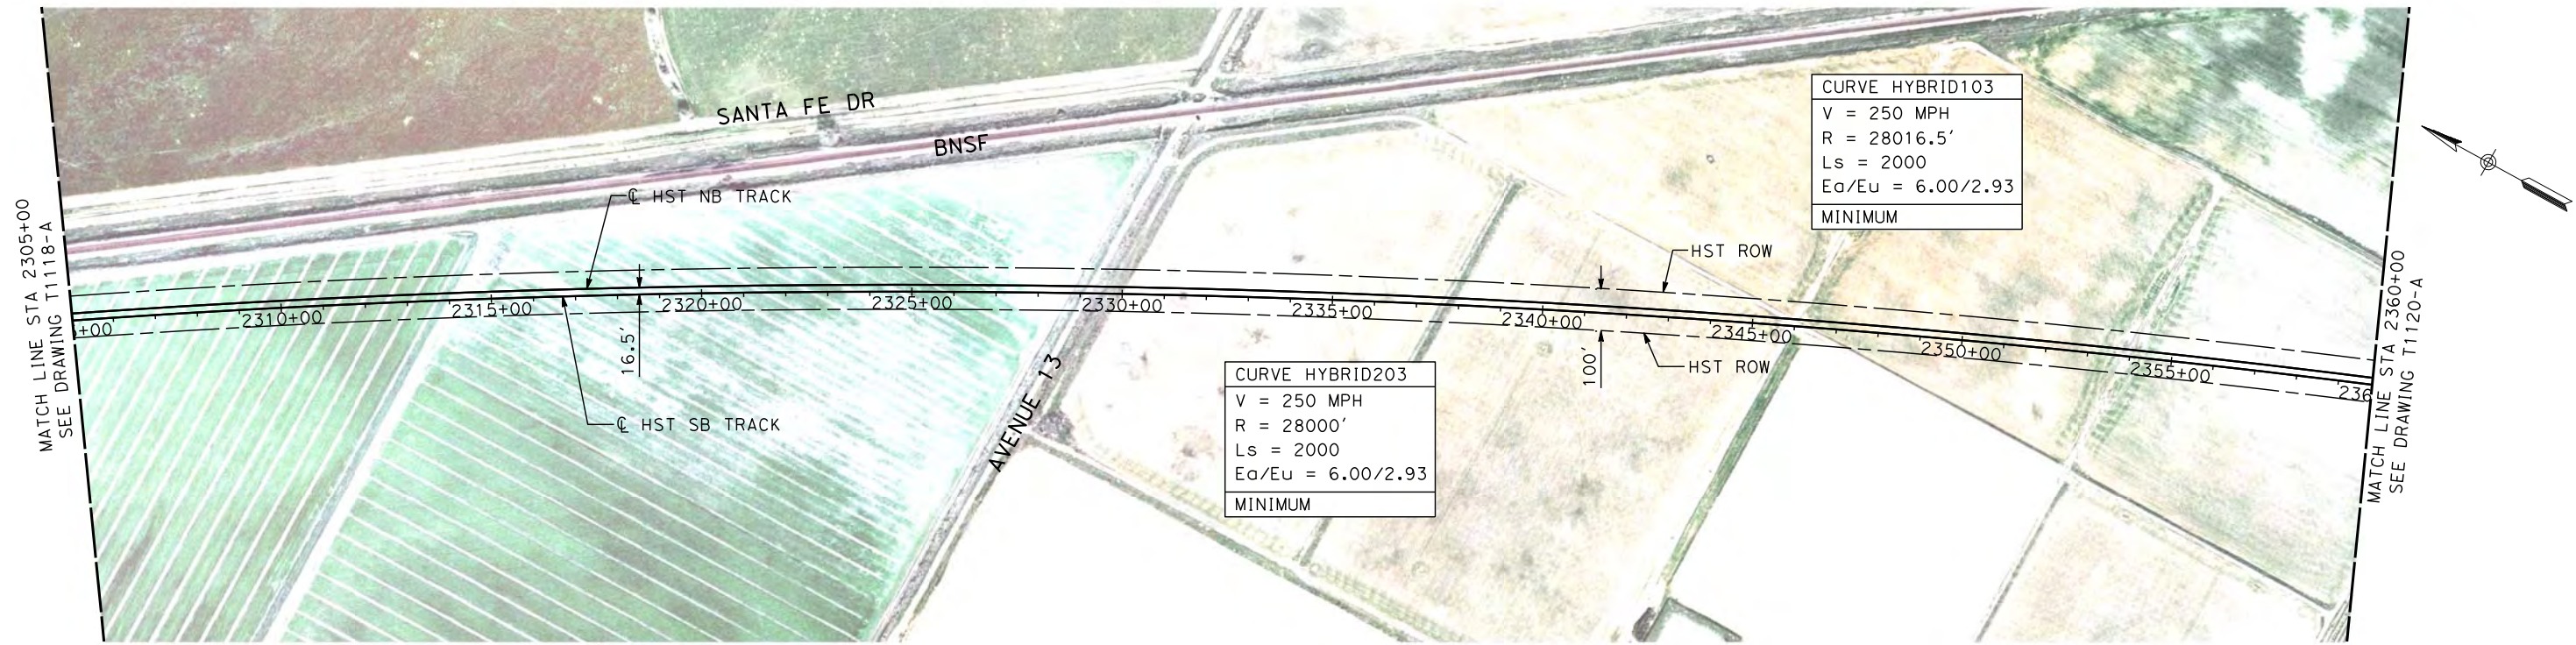
PROFILE

"SEE T3000-T3017 DRAWINGS FOR  
TYPICAL SECTION LIMITS AND DETAILS"

					DESIGNED BY A. SHIELDS	RECORD SET 15% DESIGN SUBMITTAL  NOT FOR CONSTRUCTION	 Technical Services, Inc. 2020 L Street, Suite 300 Sacramento, CA 95811 		CALIFORNIA HIGH-SPEED TRAIN PROJECT MERCED TO FRESNO  HYBRID  PLAN AND PROFILE STA 2250+00 TO STA 2305+00		CONTRACT NO. HSR06-007
					DRAWN BY H. SULLIVAN						DRAWING NO. T1118-A
					CHECKED BY A. BOONE						SCALE AS SHOWN
					IN CHARGE A. BOONE						SHEET NO. ### OF ###
1	12/12/2011	AS			DATE 07/27/2011						
REV	DATE	BY	CHK	APP	DESCRIPTION						

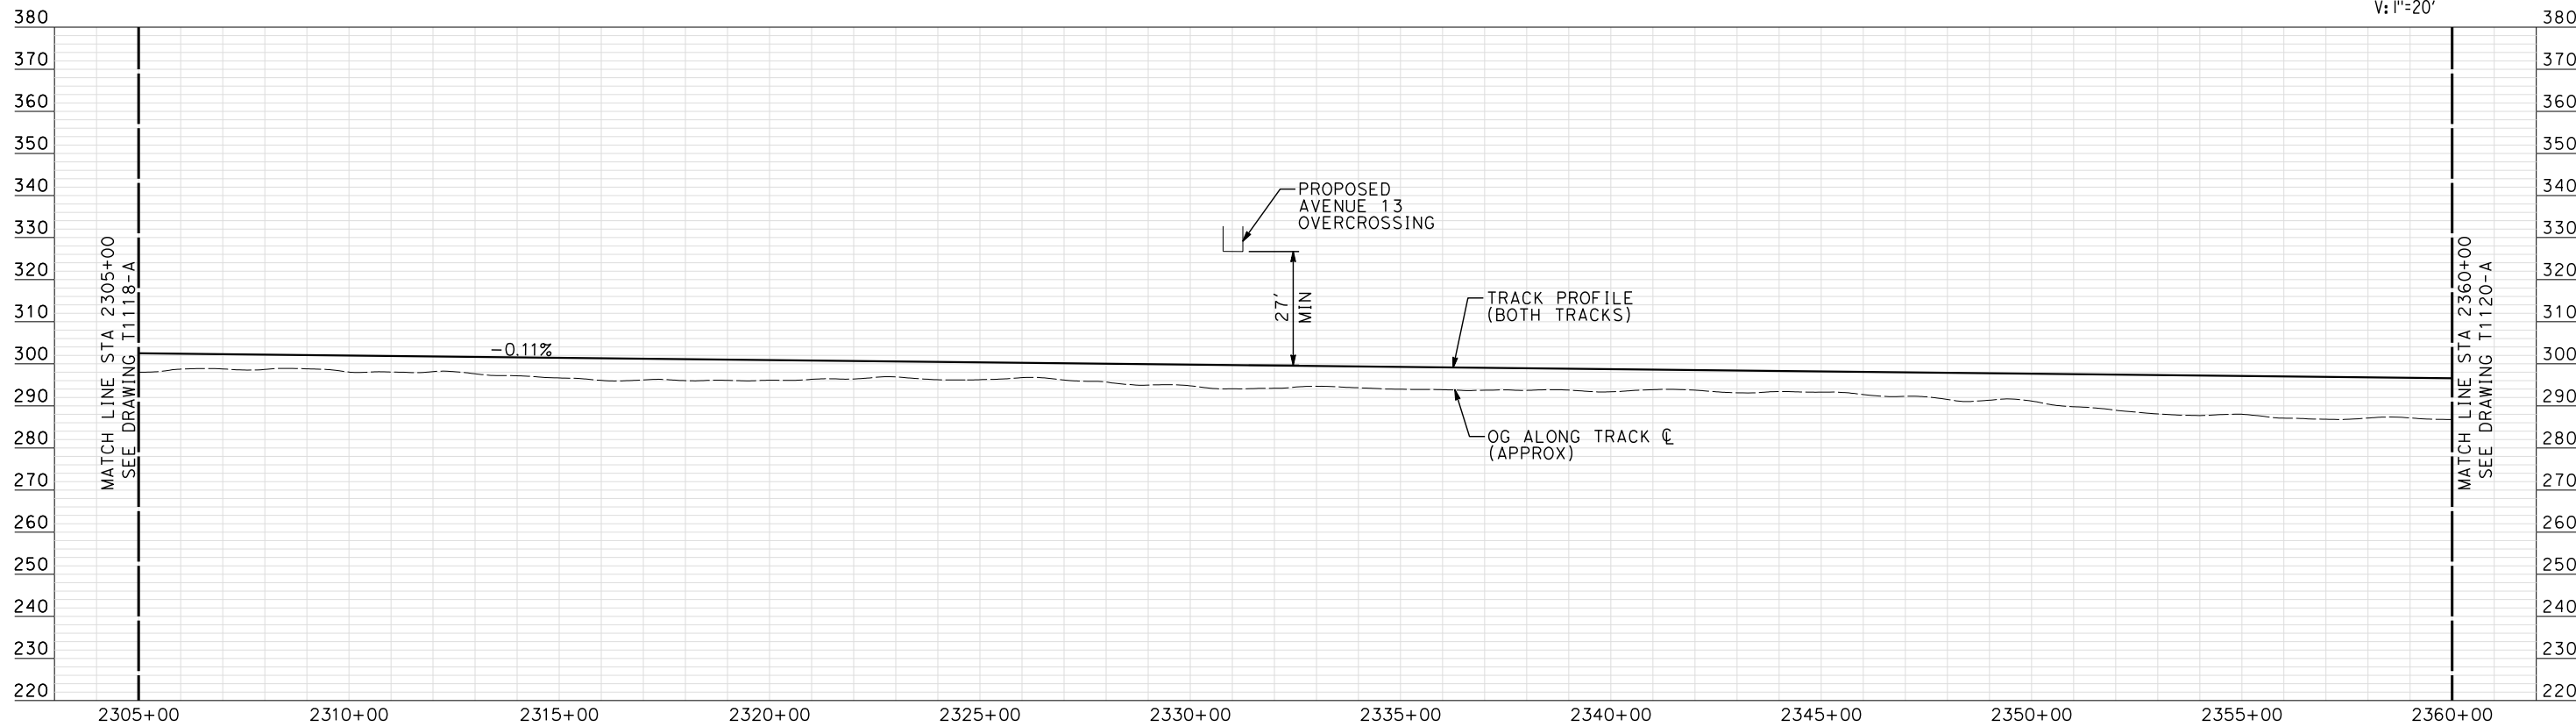
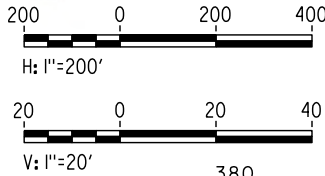


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NOTE:  
ALL UTILITIES SHOWN ARE EXISTING UTILITY LINES  
BASED ON RECORD DRAWINGS AND ARE SHOWN FOR  
INFORMATIONAL PURPOSES ONLY.

PLAN



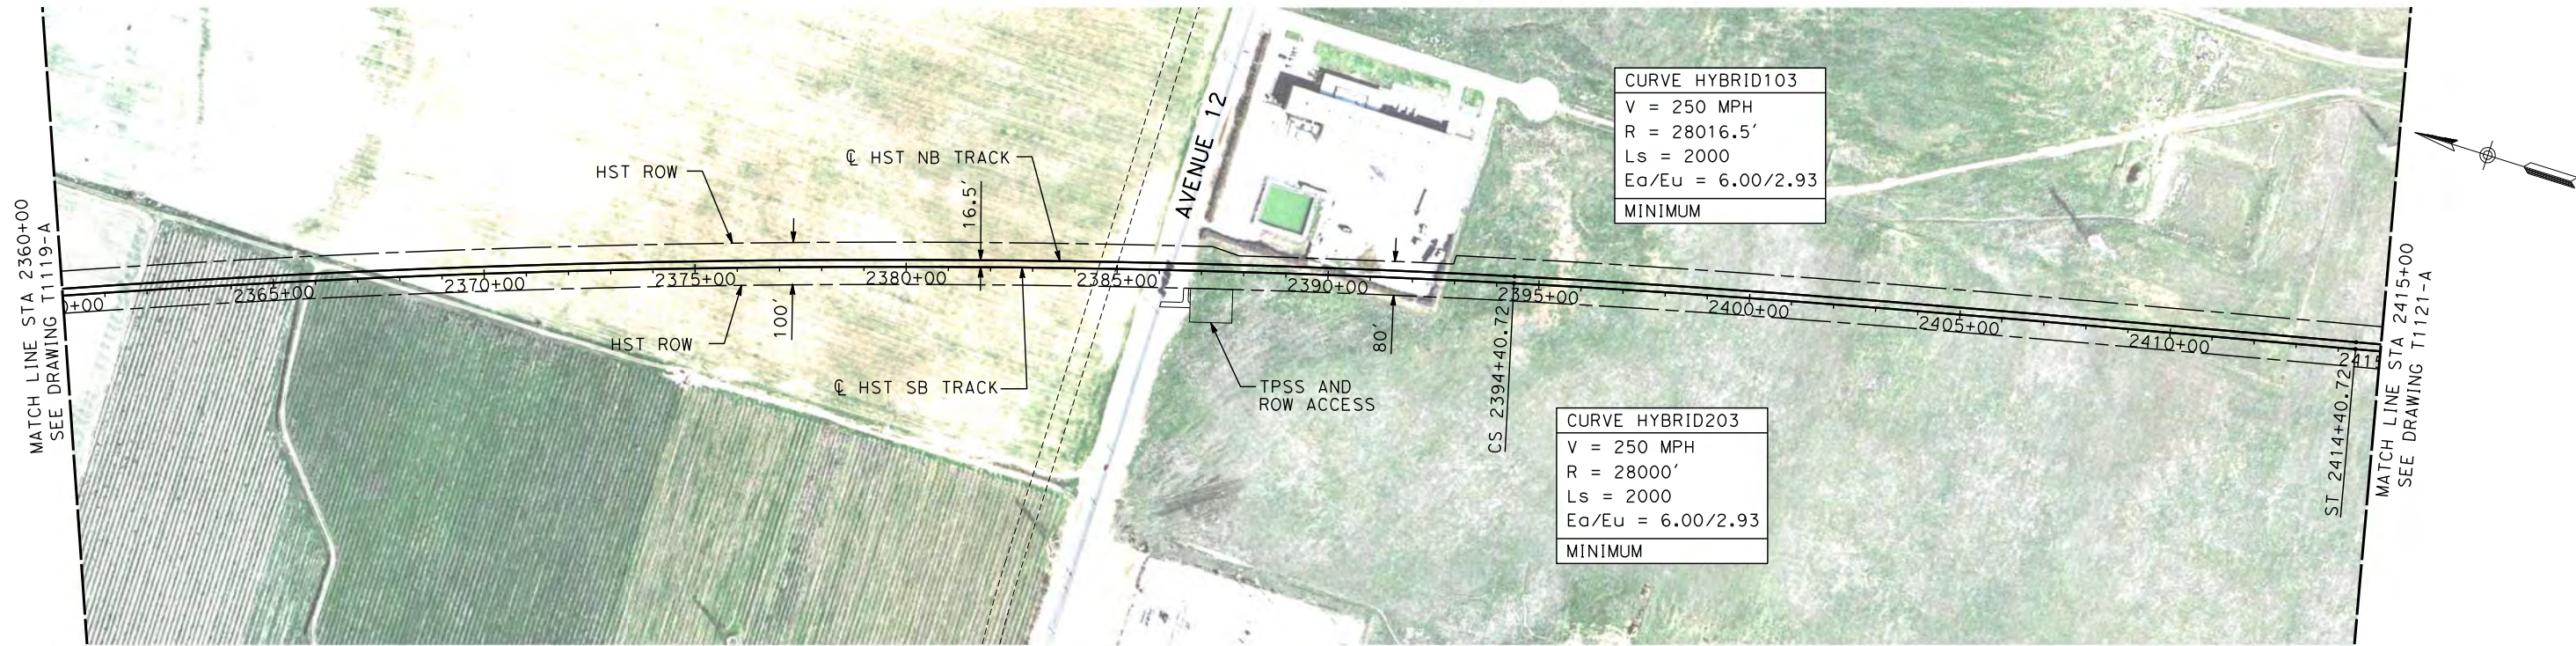
PROFILE

"SEE T3000-T3017 DRAWINGS FOR  
TYPICAL SECTION LIMITS AND DETAILS"

					DESIGNED BY A. SHIELDS	RECORD SET 15% DESIGN SUBMITTAL  NOT FOR CONSTRUCTION	<div><div>AECOM</div><div>Technical Services, Inc. 2020 L Street, Suite 300 Sacramento, CA 95811</div><div>CH2MHILL</div></div>	<div><div></div><div>CALIFORNIA HIGH-SPEED RAIL AUTHORITY</div></div>	CALIFORNIA HIGH-SPEED TRAIN PROJECT MERCED TO FRESNO  HYBRID  PLAN AND PROFILE STA 2305+00 TO STA 2360+00		CONTRACT NO. HSR06-007
					DRAWN BY H. SULLIVAN						DRAWING NO. T1119-A
					CHECKED BY A. BOONE						SCALE AS SHOWN
					IN CHARGE A. BOONE						SHEET NO. ### OF ###
1	12/12/2011	AS			DATE 07/27/2011						
REV	DATE	BY	CHK	APP	DESCRIPTION						

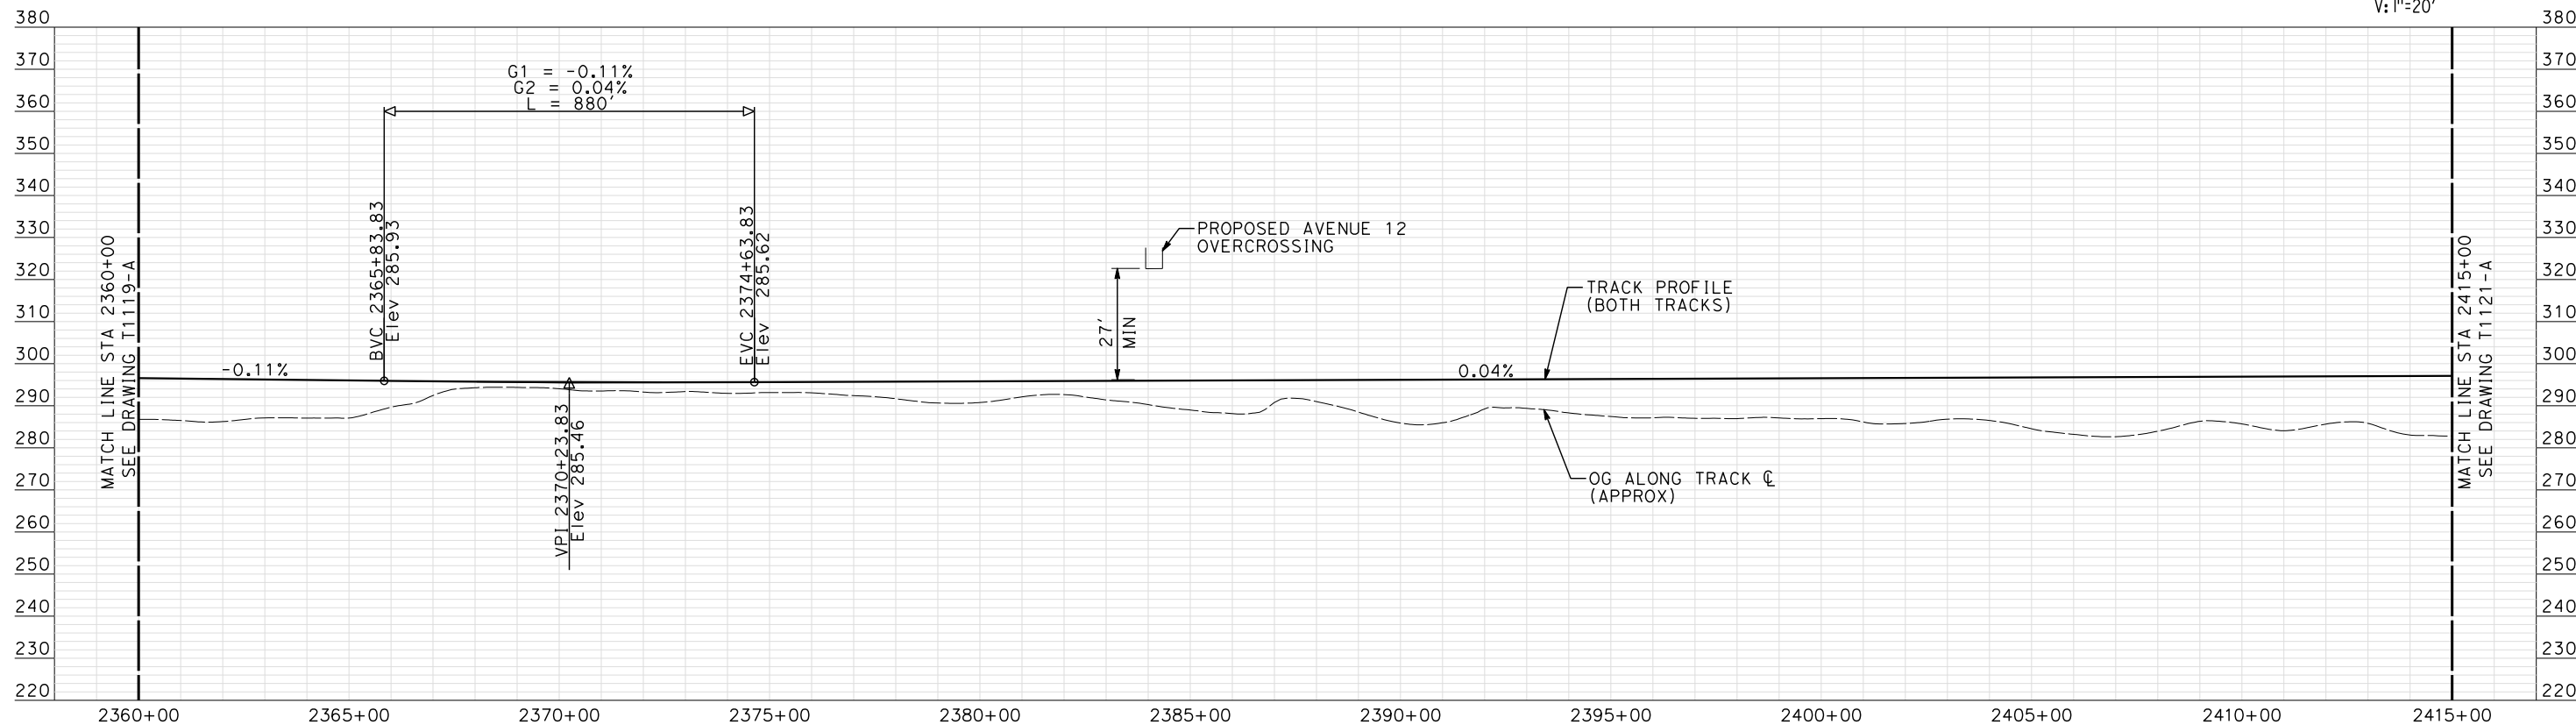
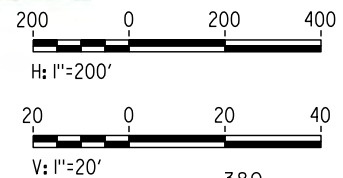


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NOTE:  
ALL UTILITIES SHOWN ARE EXISTING UTILITY LINES  
BASED ON RECORD DRAWINGS AND ARE SHOWN FOR  
INFORMATIONAL PURPOSES ONLY.

PLAN



PROFILE

"SEE T3000-T3017 DRAWINGS FOR  
TYPICAL SECTION LIMITS AND DETAILS"

REV	DATE	BY	CHK	APP	DESCRIPTION
1	12/12/2011	AS			TRACK REALIGNMENT

DESIGNED BY A. SHIELDS
DRAWN BY H. SULLIVAN
CHECKED BY A. BOONE
IN CHARGE A. BOONE
DATE 07/27/2011

RECORD SET  
15% DESIGN  
SUBMITTAL

NOT FOR  
CONSTRUCTION

**AECOM**  
Technical Services, Inc.  
2020 L Street, Suite 300  
Sacramento, CA 95811  
**CH2MHILL**



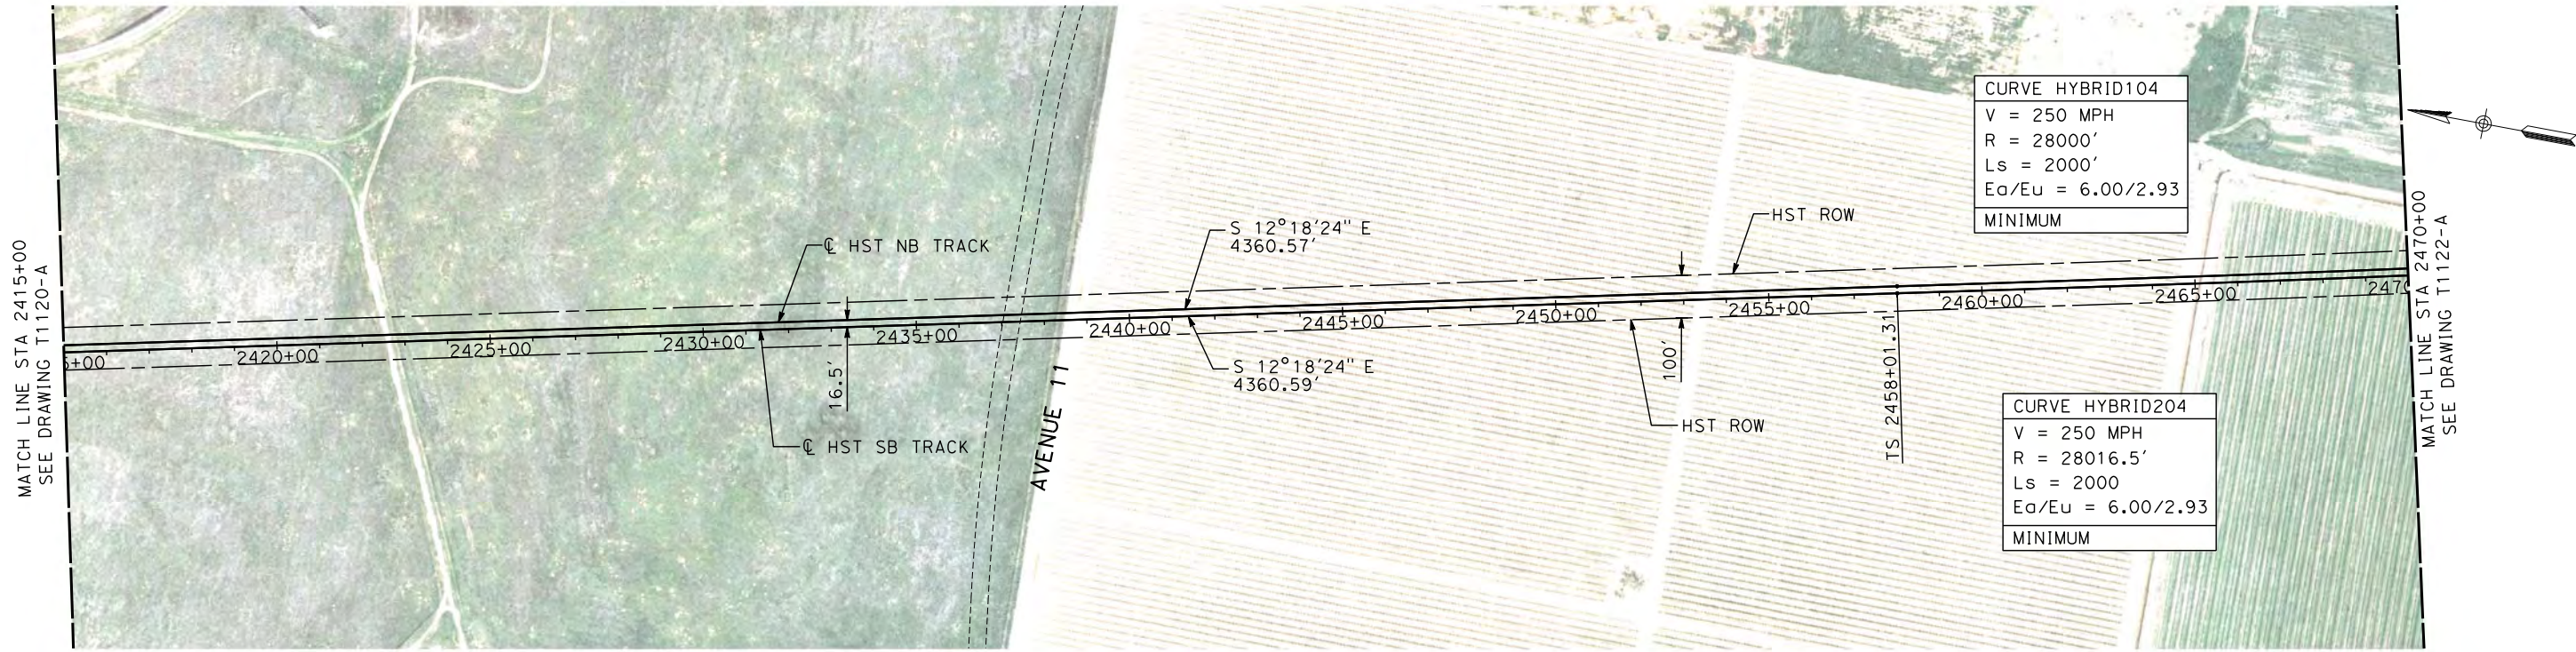
**CALIFORNIA HIGH-SPEED TRAIN PROJECT  
MERCED TO FRESNO**  
HYBRID

PLAN AND PROFILE  
STA 2360+00 TO STA 2415+00

CONTRACT NO. HSR06-007
DRAWING NO. T1120-A
SCALE AS SHOWN
SHEET NO. ### OF ###

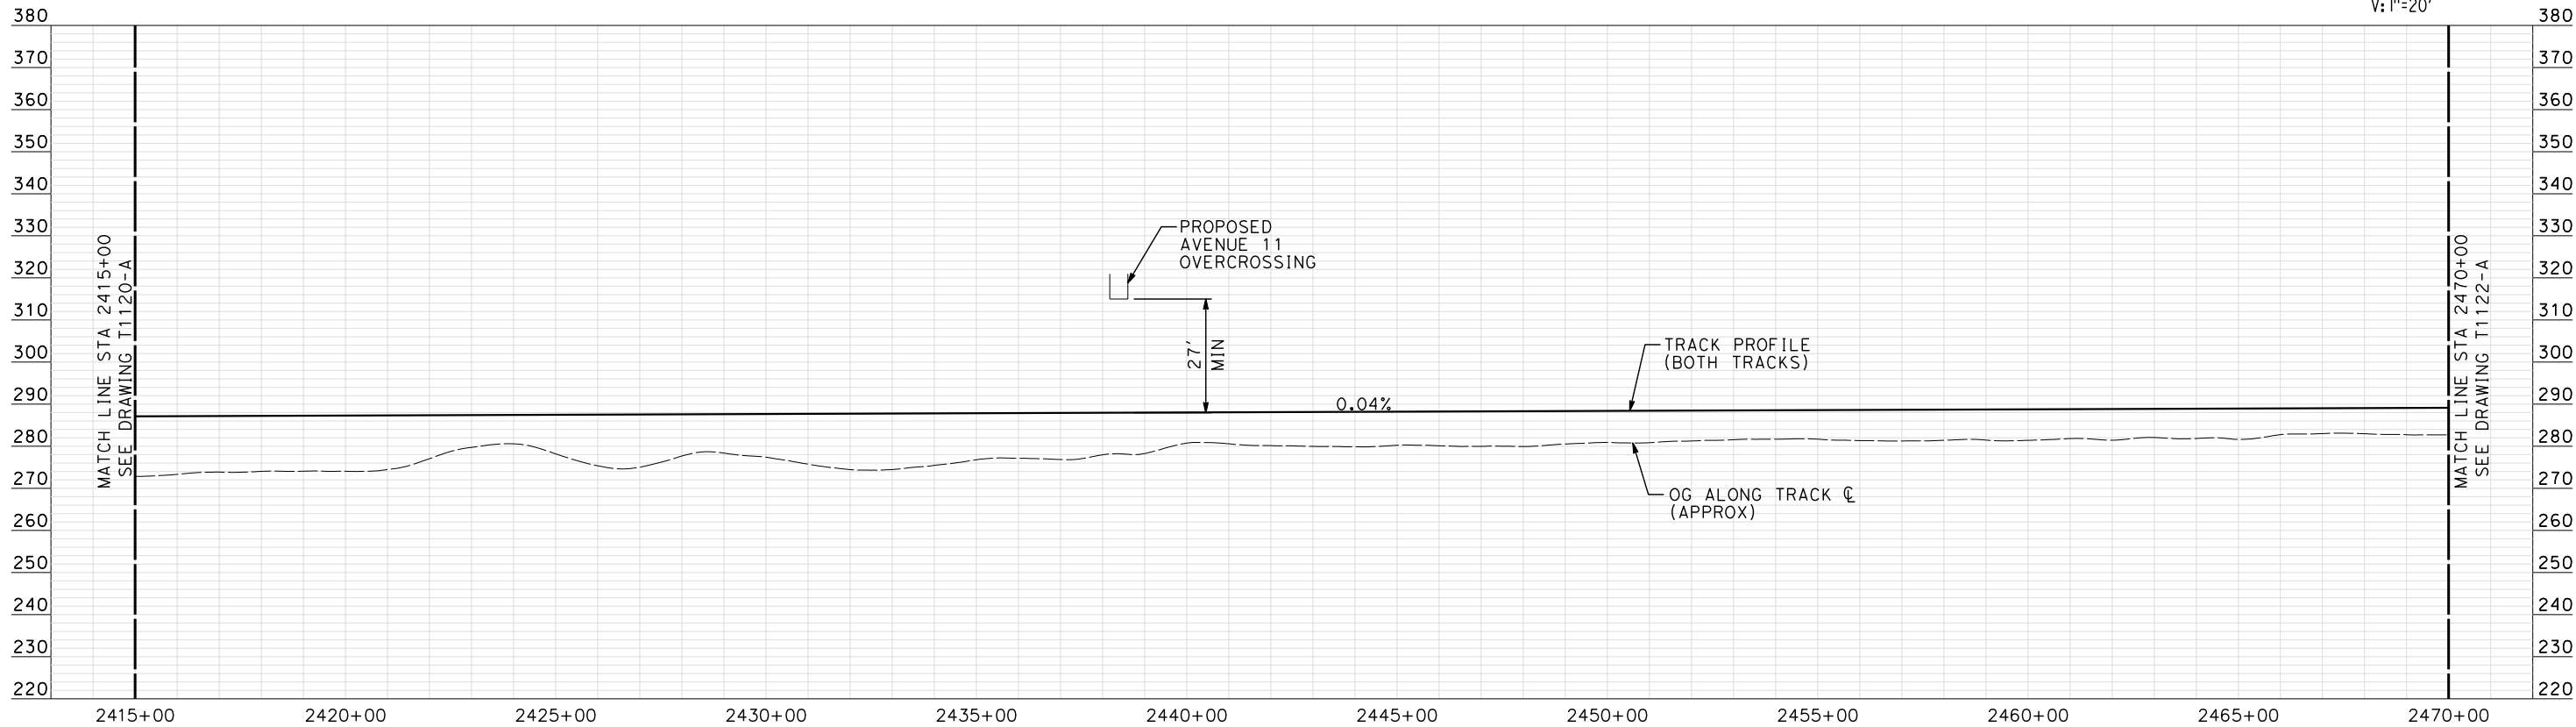
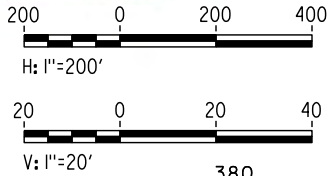


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


NOTE:  
ALL UTILITIES SHOWN ARE EXISTING UTILITY LINES  
BASED ON RECORD DRAWINGS AND ARE SHOWN FOR  
INFORMATIONAL PURPOSES ONLY.

PLAN



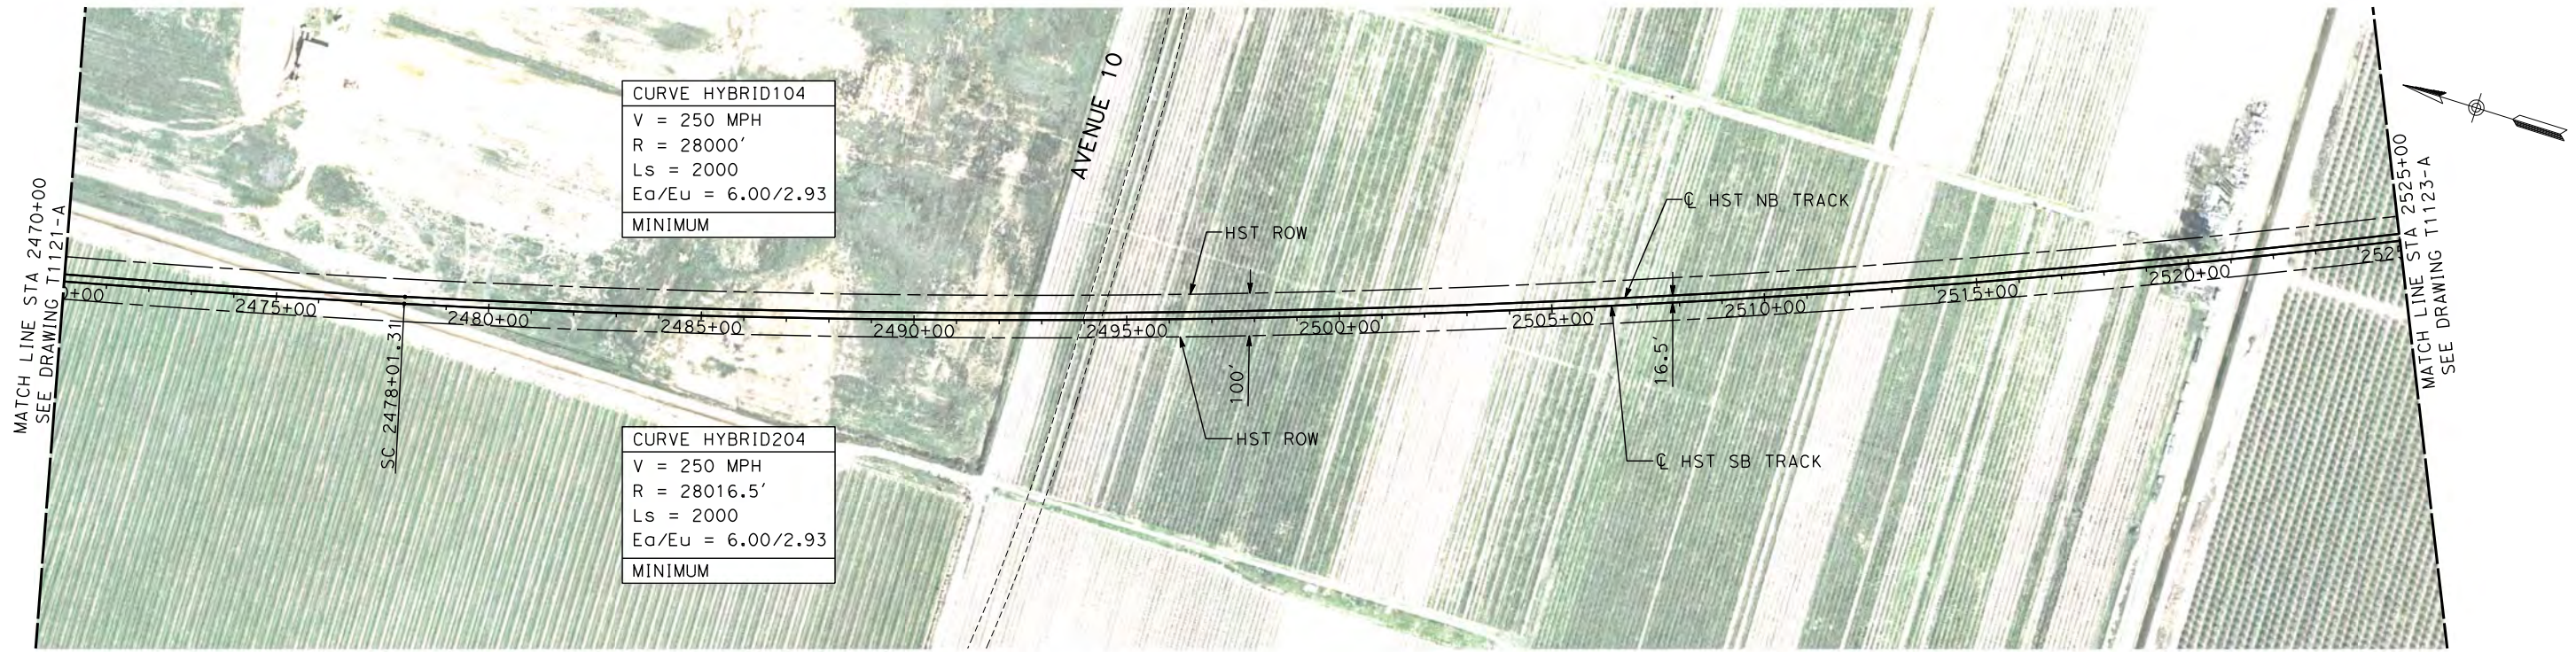
PROFILE

"SEE T3000-T3017 DRAWINGS FOR  
TYPICAL SECTION LIMITS AND DETAILS"

						DESIGNED BY A. SHIELDS	RECORD SET 15% DESIGN SUBMITTAL  NOT FOR CONSTRUCTION	 Technical Services, Inc. 2020 L Street, Suite 300 Sacramento, CA 95811 	 <i>CALIFORNIA</i> HIGH-SPEED RAIL AUTHORITY	CONTRACT NO. HSR06-007			
						DRAWN BY H. SULLIVAN				DRAWING NO. T1121-A			
						CHECKED BY A. BOONE				SCALE AS SHOWN			
						IN CHARGE A. BOONE				SHEET NO. ### OF ###			
1	12/12/2011	AS			TRACK REALIGNMENT	DATE 07/27/2011	CALIFORNIA HIGH-SPEED TRAIN PROJECT MERCED TO FRESNO HYBRID  PLAN AND PROFILE STA 2415+00 TO STA 2470+00						
REV	DATE	BY	CHK	APP	DESCRIPTION								

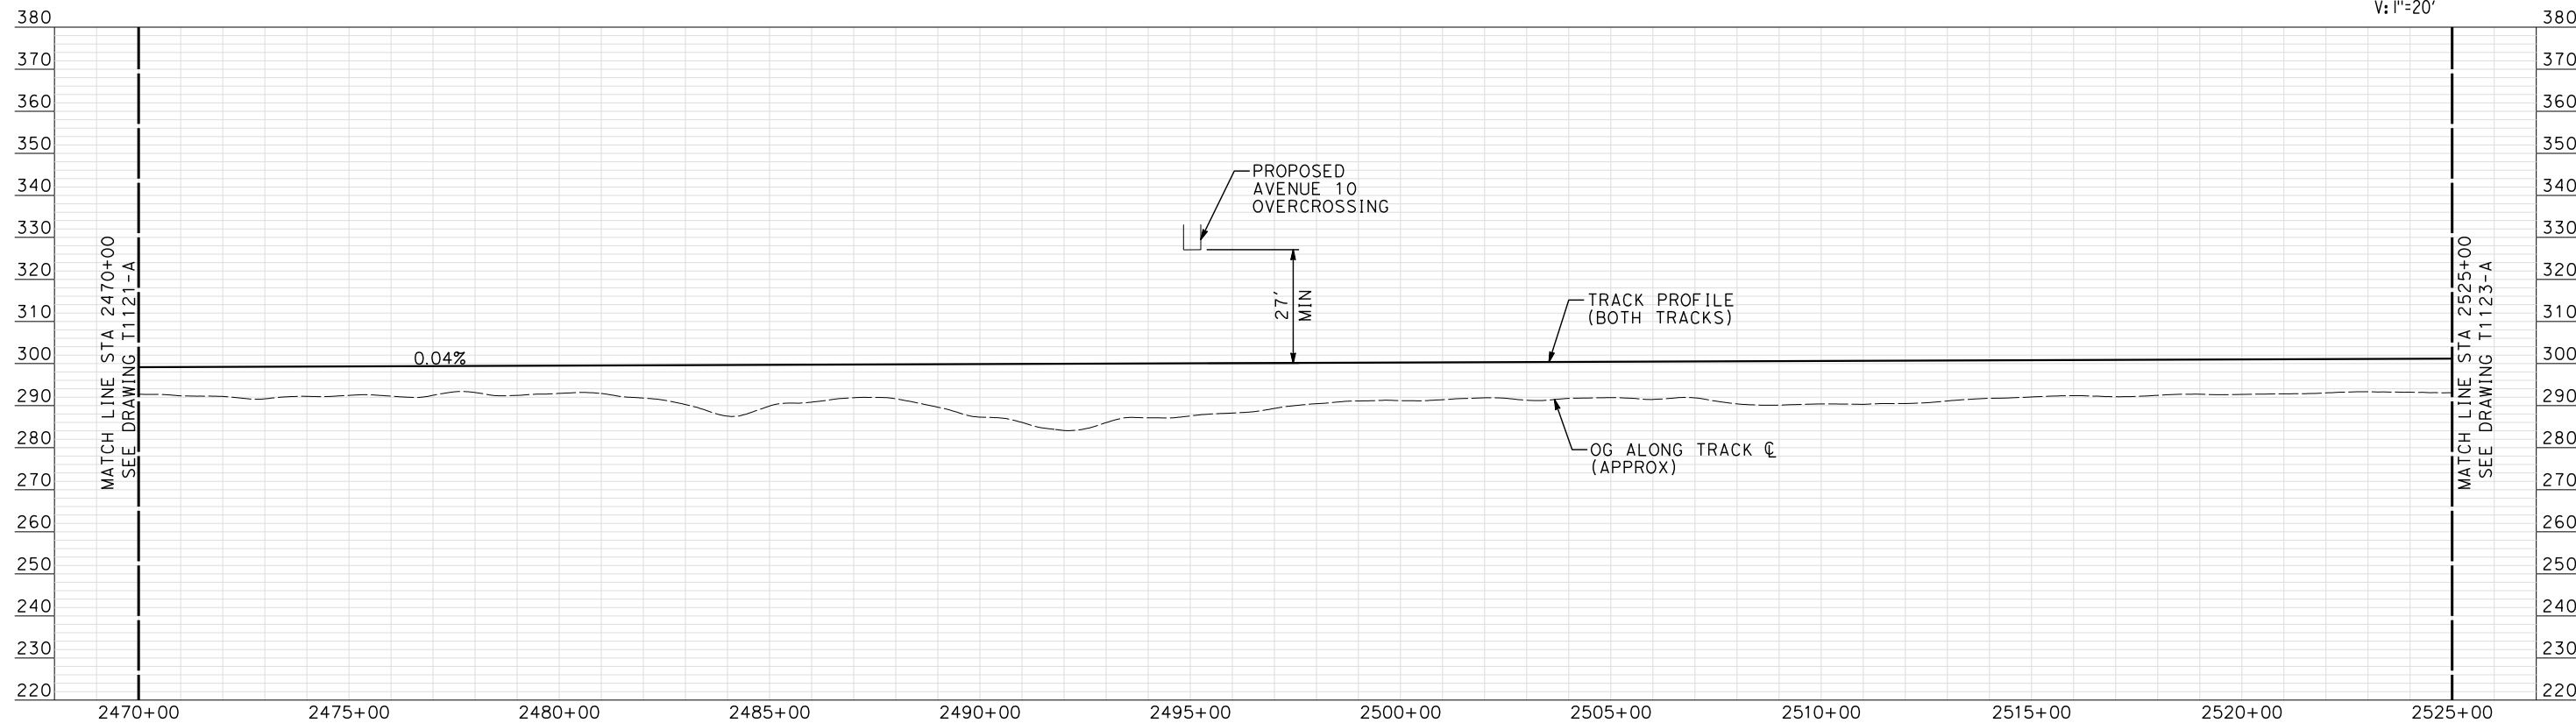
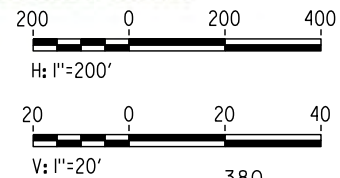


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
NOTE:  
ALL UTILITIES SHOWN ARE EXISTING UTILITY LINES  
BASED ON RECORD DRAWINGS AND ARE SHOWN FOR  
INFORMATIONAL PURPOSES ONLY.

PLAN



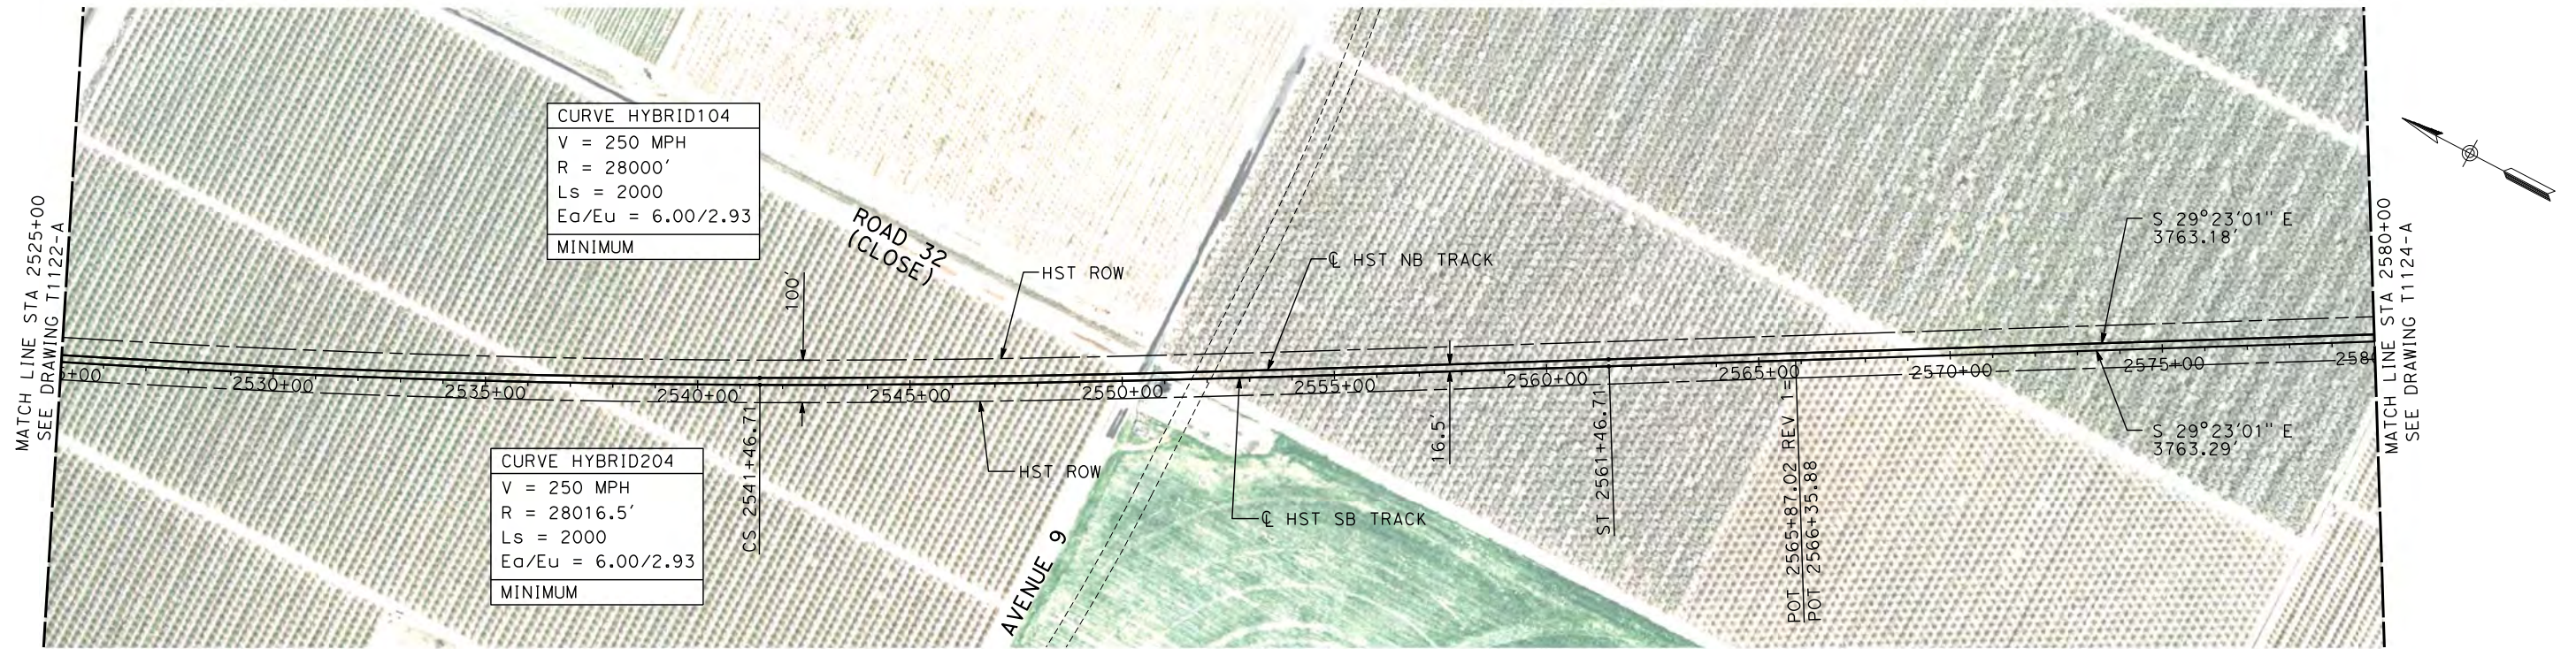
PROFILE

"SEE T3000-T3017 DRAWINGS FOR  
TYPICAL SECTION LIMITS AND DETAILS"

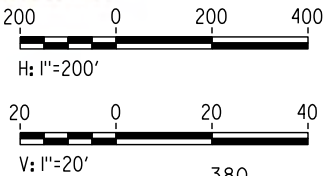
						DESIGNED BY A. SHIELDS	RECORD SET 15% DESIGN SUBMITTAL  NOT FOR CONSTRUCTION	<div><b>AECOM</b> Technical Services, Inc. 2020 L Street, Suite 300 Sacramento, CA 95811</div> <div><b>CH2MHILL</b></div>	<div><b>CALIFORNIA</b> HIGH-SPEED RAIL AUTHORITY</div>	<b>CALIFORNIA HIGH-SPEED TRAIN PROJECT</b>	CONTRACT NO. HSR06-007
						DRAWN BY H. SULLIVAN				DRAWING NO. T1122-A	
						CHECKED BY A. BOONE				SCALE AS SHOWN	
						IN CHARGE A. BOONE				SHEET NO. ### OF ###	
1	12/12/2011	AS			TRACK REALIGNMENT	DATE 07/27/2011					
REV	DATE	BY	CHK	APP	DESCRIPTION						



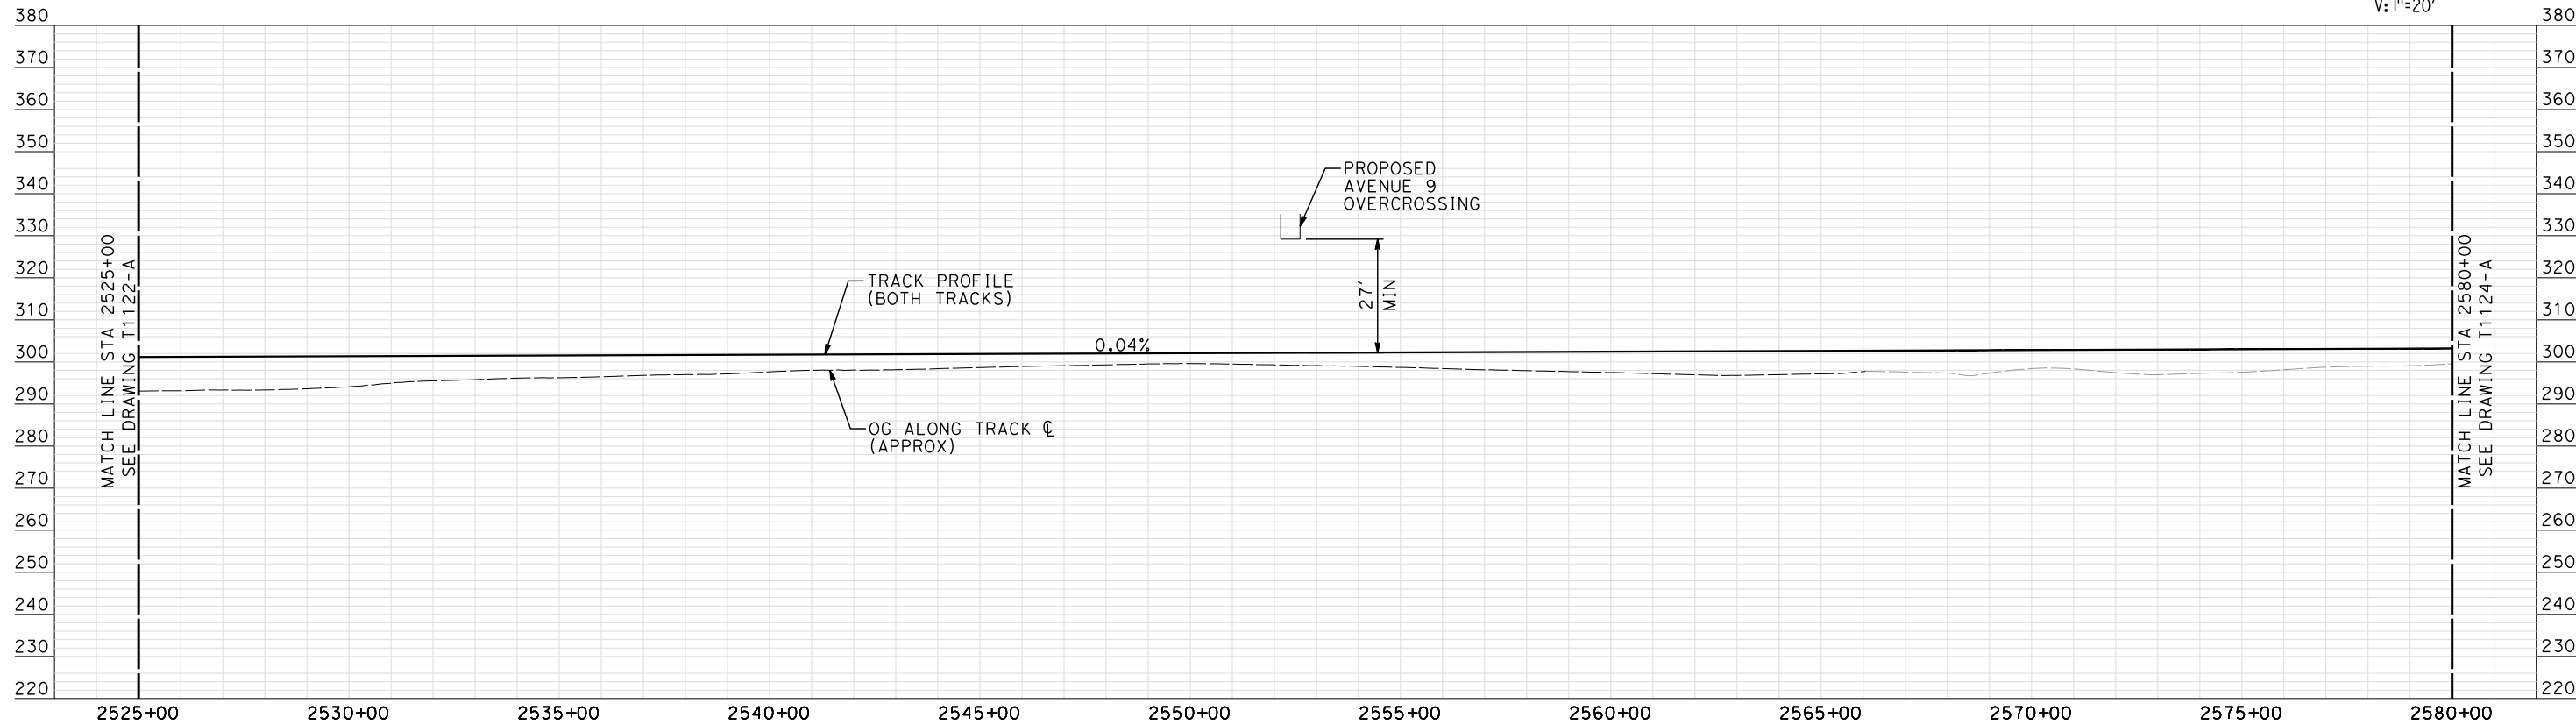
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NOTE:  
ALL UTILITIES SHOWN ARE EXISTING UTILITY LINES  
BASED ON RECORD DRAWINGS AND ARE SHOWN FOR  
INFORMATIONAL PURPOSES ONLY.




PLAN



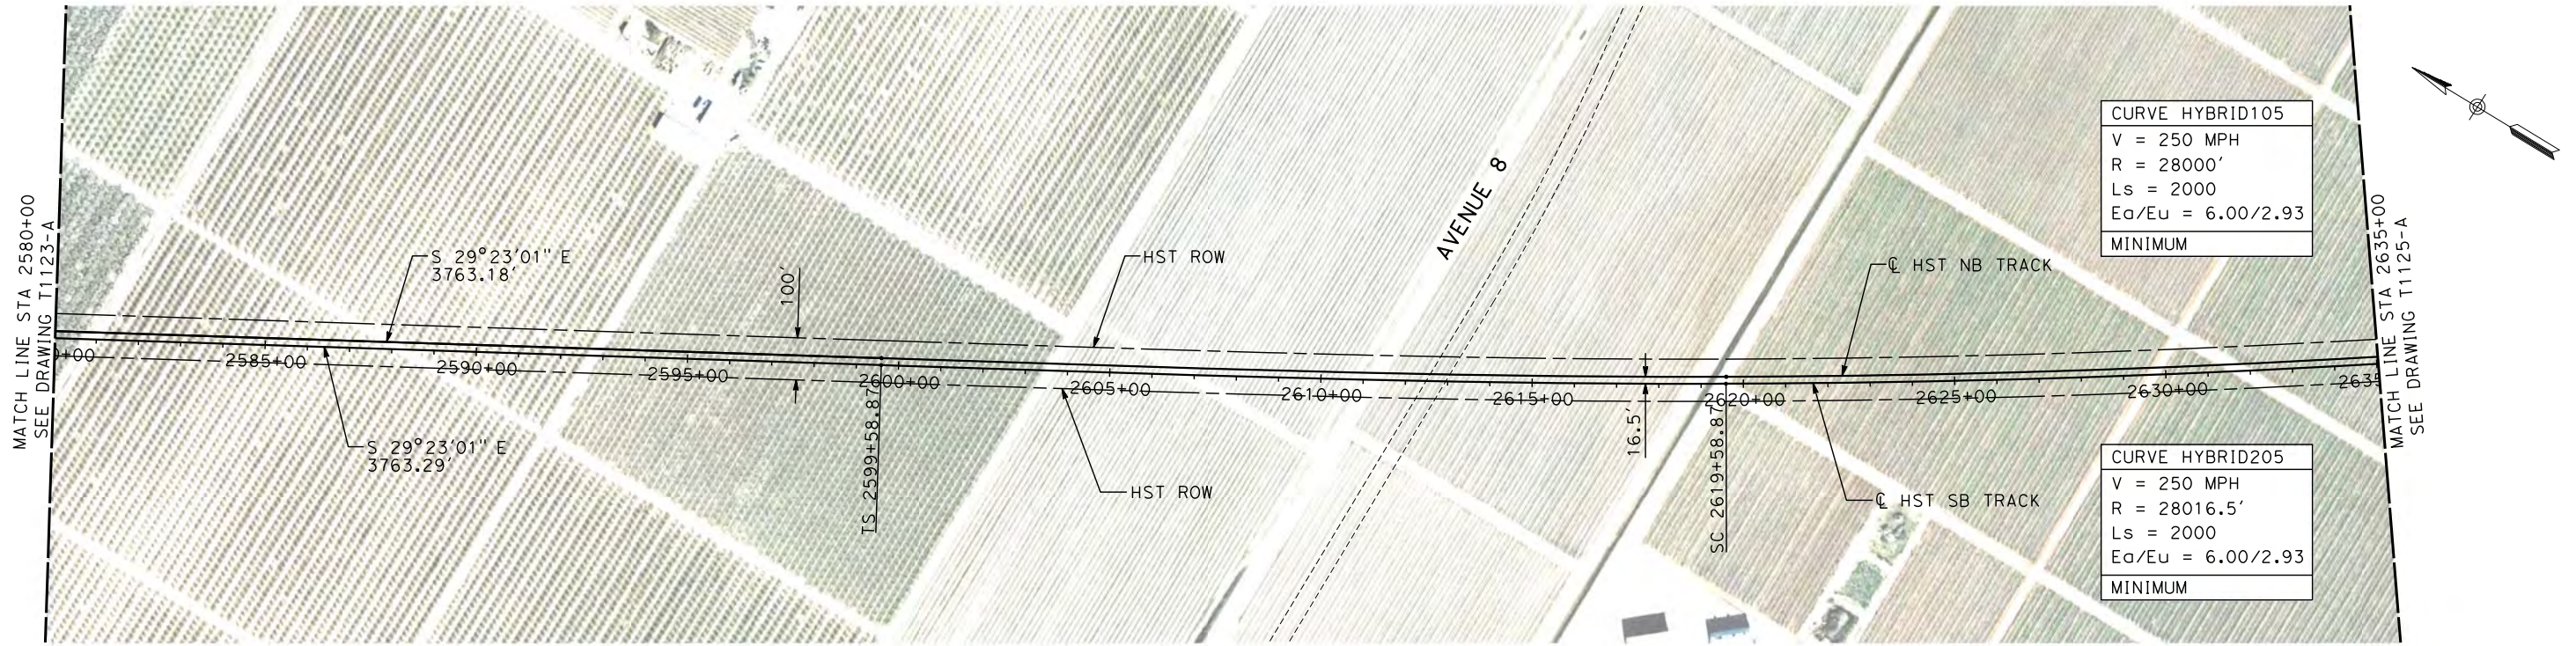
PROFILE

"SEE T3000-T3017 DRAWINGS FOR  
TYPICAL SECTION LIMITS AND DETAILS"

						DESIGNED BY A. SHIELDS	RECORD SET 15% DESIGN SUBMITTAL  NOT FOR CONSTRUCTION	<div>AECOM</div> <div>Technical Services, Inc. 2020 L Street, Suite 300 Sacramento, CA 95811</div> <div>CH2MHILL</div>	<div></div> <div>CALIFORNIA HIGH-SPEED RAIL AUTHORITY</div>	CALIFORNIA HIGH-SPEED TRAIN PROJECT MERCED TO FRESNO  HYBRID  PLAN AND PROFILE STA 2525+00 TO STA 2580+00	CONTRACT NO. HSR06-007
					DRAWN BY H. SULLIVAN	DRAWING NO. T1123-A					
					CHECKED BY A. BOONE	SCALE AS SHOWN					
					IN CHARGE A. BOONE	SHEET NO. ### OF ###					
1	12/12/2011	AS			TRACK REALIGNMENT	DATE 07/27/2011					
REV	DATE	BY	CHK	APP	DESCRIPTION						

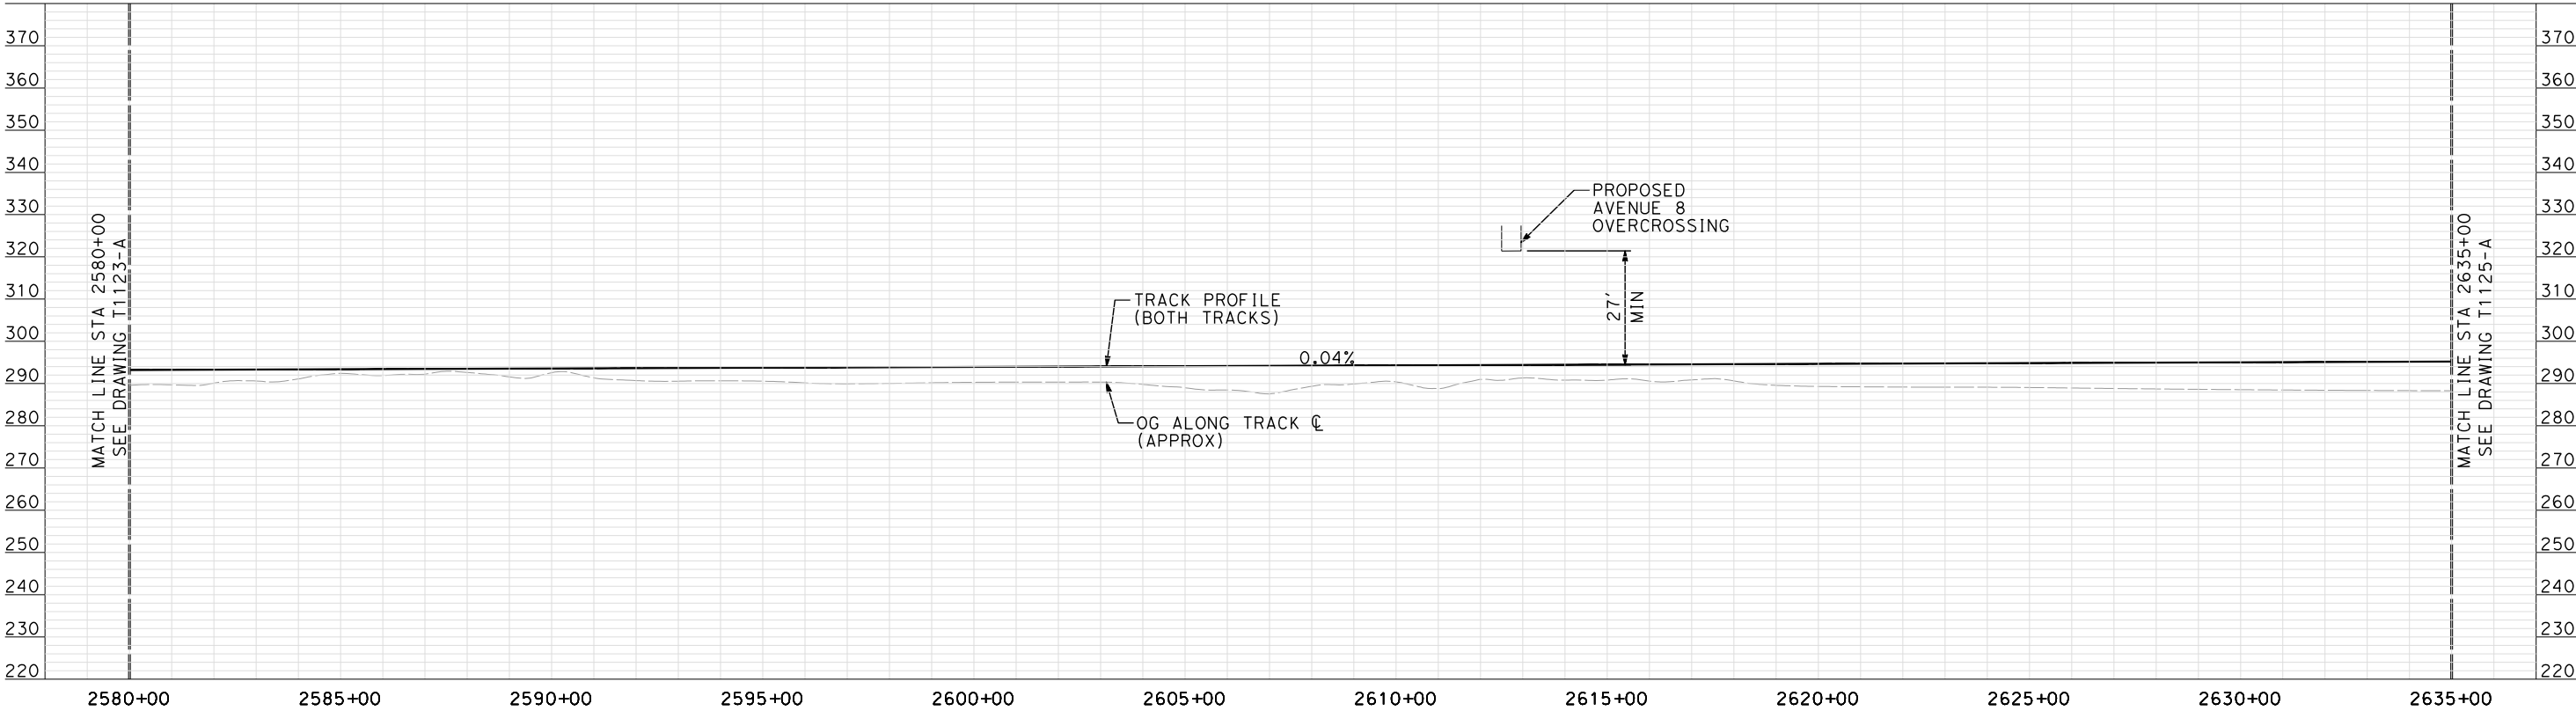
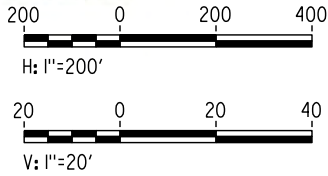


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
- NOTES:
1. ALL UTILITIES SHOWN ARE EXISTING UTILITY LINES BASED ON RECORD DRAWINGS AND ARE SHOWN FOR INFORMATIONAL PURPOSES ONLY.
  2. TRACKS CLOSER THAN 102 FT TO THE NEAREST EXISTING FREIGHT TRACKS WILL INCLUDE SAFETY BARRIERS, BERMS, OR WALLS AS REQUIRED.

PLAN



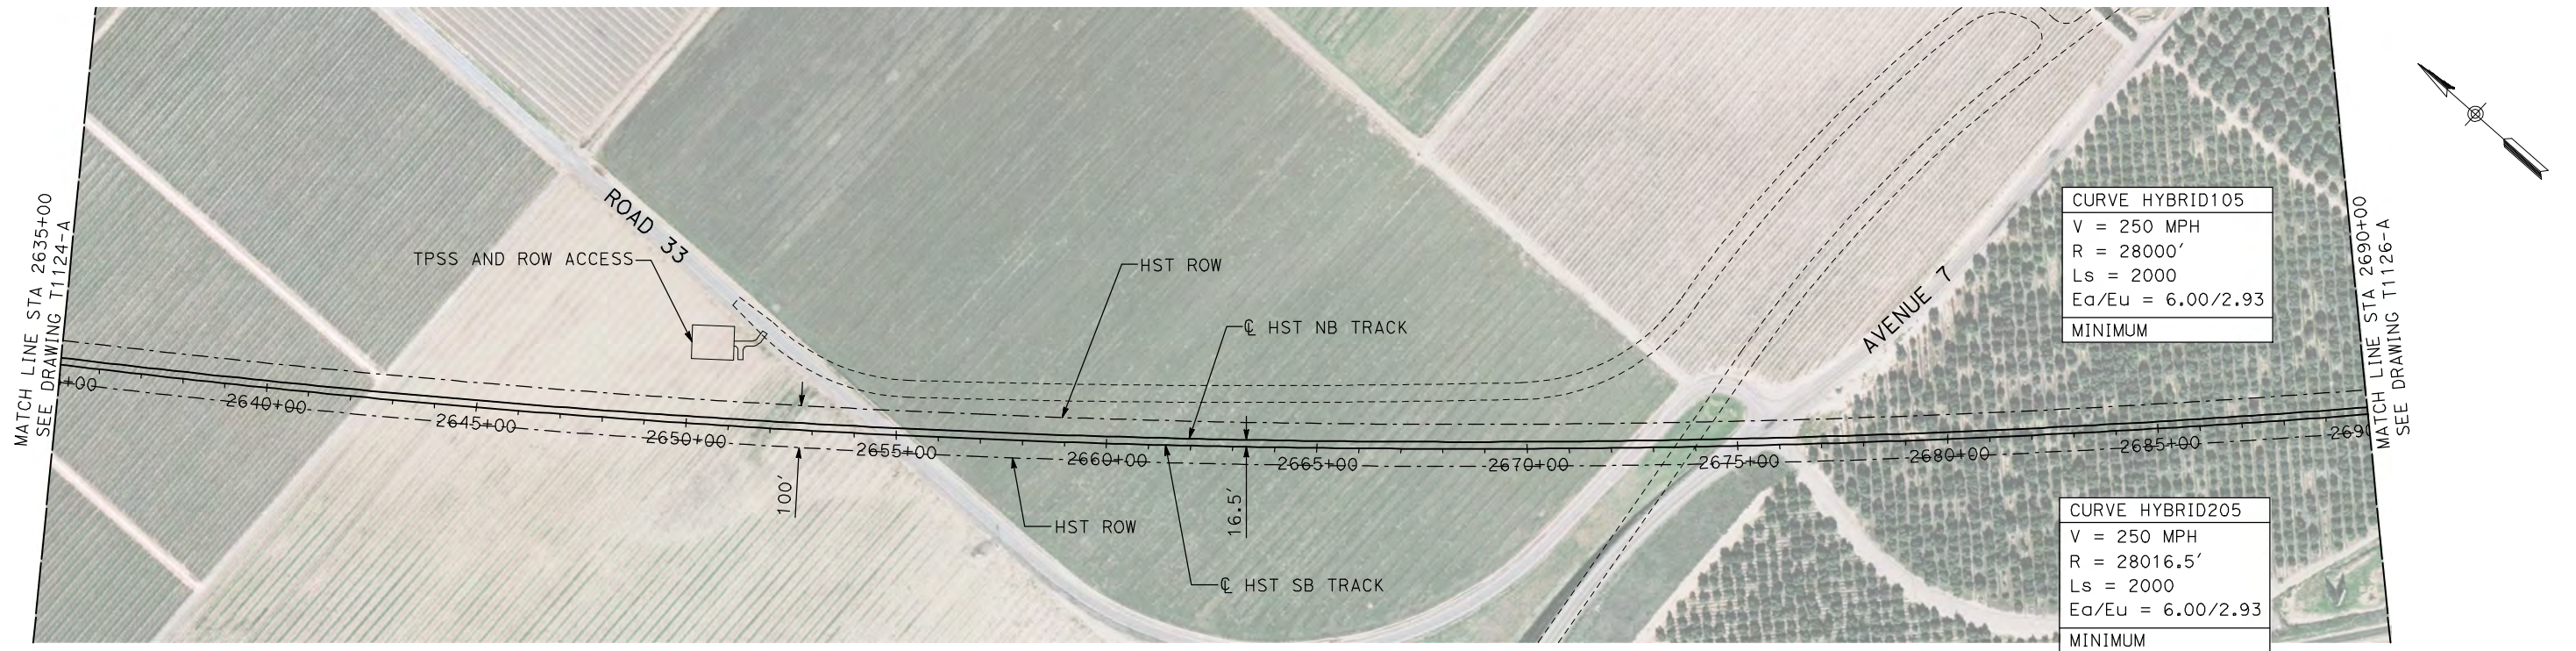
PROFILE

"SEE T3000-T3017 DRAWINGS FOR  
TYPICAL SECTION LIMITS AND DETAILS"

						DESIGNED BY A. SHIELDS	RECORD SET 15% DESIGN SUBMITTAL  NOT FOR CONSTRUCTION	AECOM Technical Services, Inc. 2020 L Street, Suite 300 Sacramento, CA 95811  CH2MHILL	 <i>CALIFORNIA</i> HIGH-SPEED RAIL AUTHORITY	CALIFORNIA HIGH-SPEED TRAIN PROJECT MERCED TO FRESNO  HYBRID  PLAN AND PROFILE STA 2580+00 TO STA 2635+00	CONTRACT NO. HSR06-007
						DRAWN BY H. SULLIVAN					DRAWING NO. T1124-A
						CHECKED BY A. BOONE					SCALE AS SHOWN
						IN CHARGE A. BOONE					SHEET NO. ### OF ###
1	12/12/2011	AS			TRACK REALIGNMENT	DATE 07/27/2011					
REV	DATE	BY	CHK	APP	DESCRIPTION						

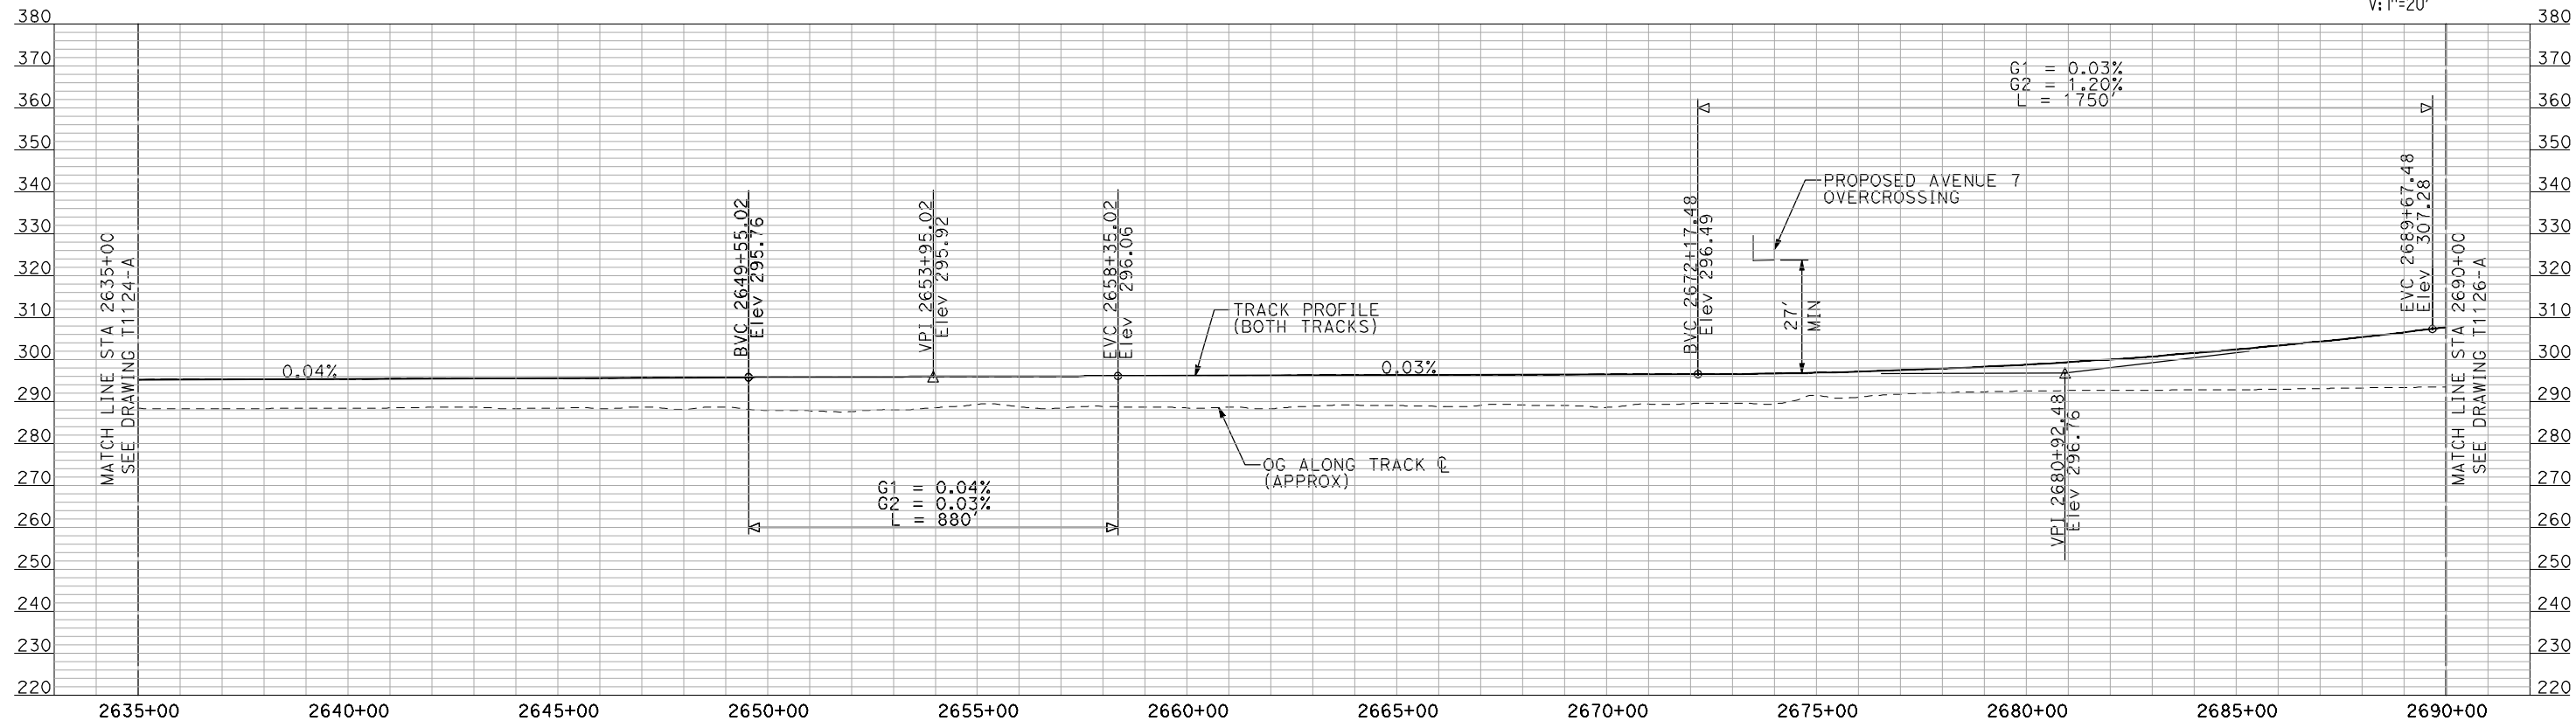
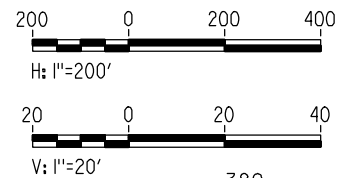


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- NOTES:
1. ALL UTILITIES SHOWN ARE EXISTING UTILITY LINES BASED ON RECORD DRAWINGS AND ARE SHOWN FOR INFORMATIONAL PURPOSES ONLY.
  2. TRACKS CLOSER THAN 102 FT TO THE NEAREST EXISTING FREIGHT TRACKS WILL INCLUDE SAFETY BARRIERS, BERMS, OR WALLS AS REQUIRED.

PLAN



PROFILE

"SEE T3000-T3017 DRAWINGS FOR  
TYPICAL SECTION LIMITS AND DETAILS"

REV	DATE	BY	CHK	APP	DESCRIPTION

DESIGNED BY A. SHIELDS
DRAWN BY H. SULLIVAN
CHECKED BY A. BOONE
IN CHARGE A. BOONE
DATE 07/20/2011

RECORD SET  
15% DESIGN  
SUBMITTAL

NOT FOR  
CONSTRUCTION



CALIFORNIA HIGH-SPEED TRAIN PROJECT  
MERCED TO FRESNO

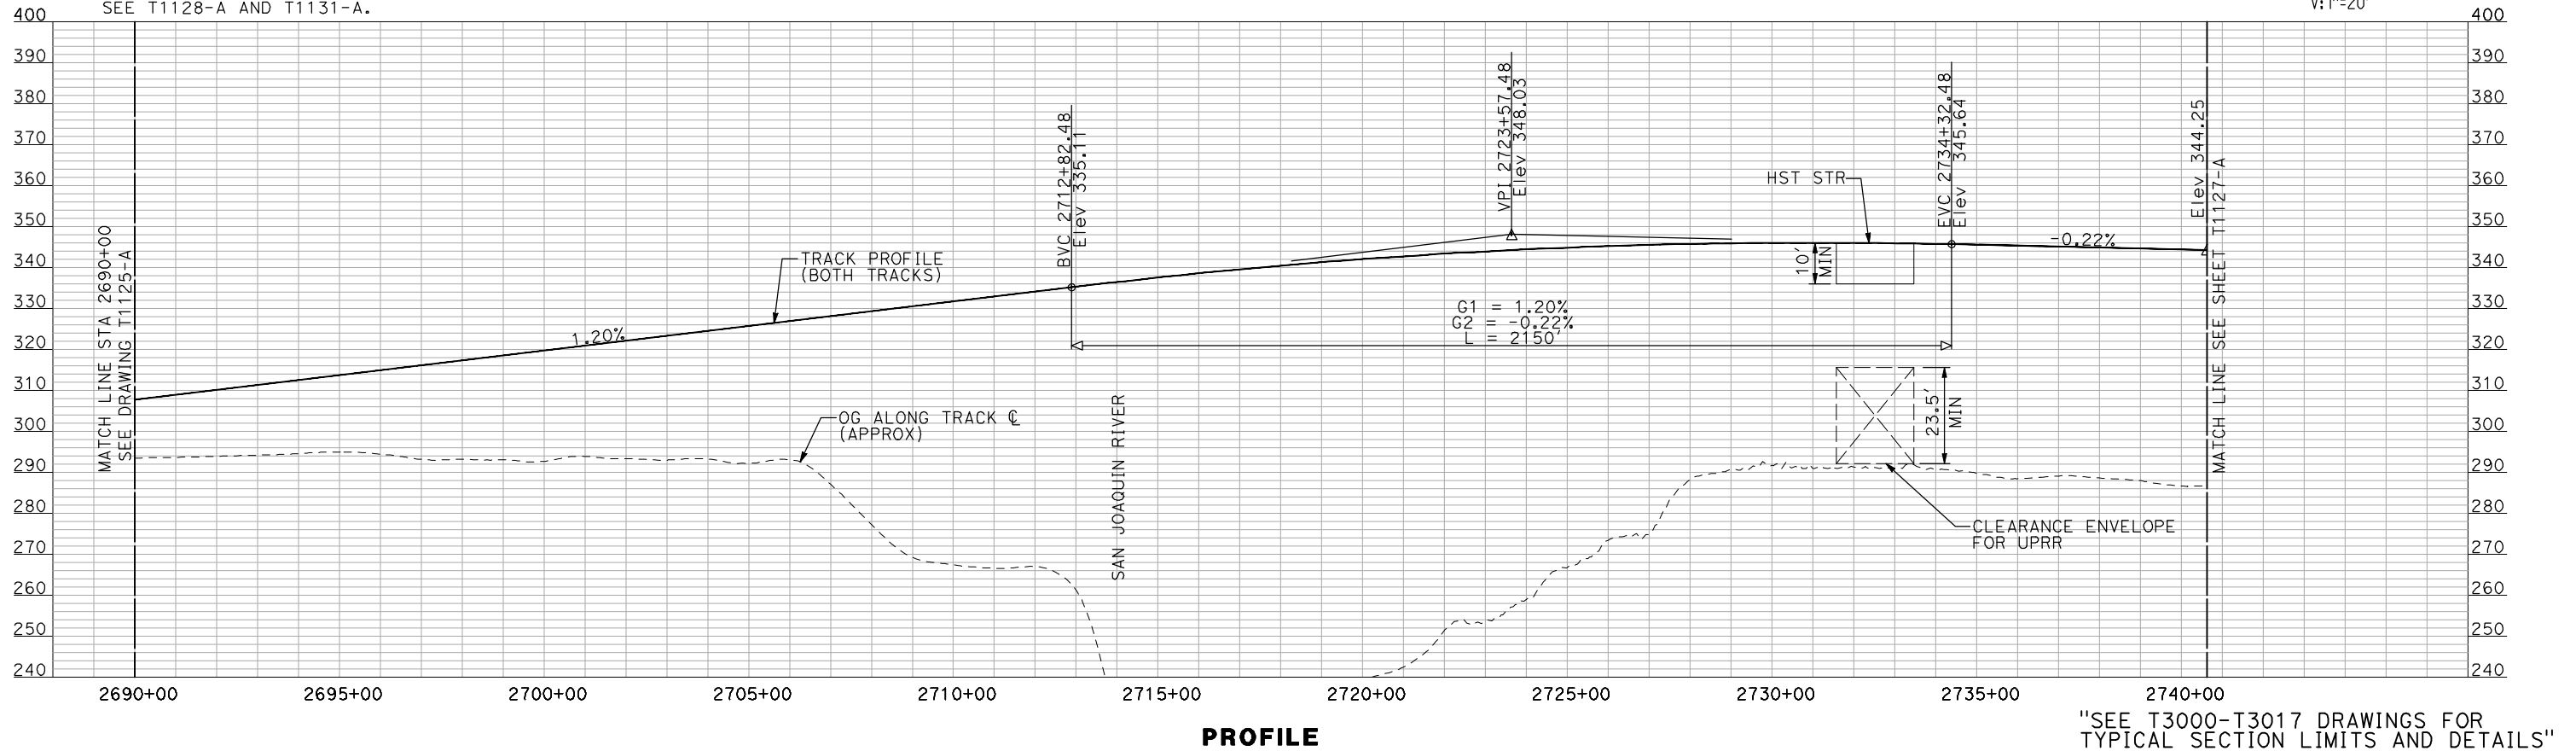
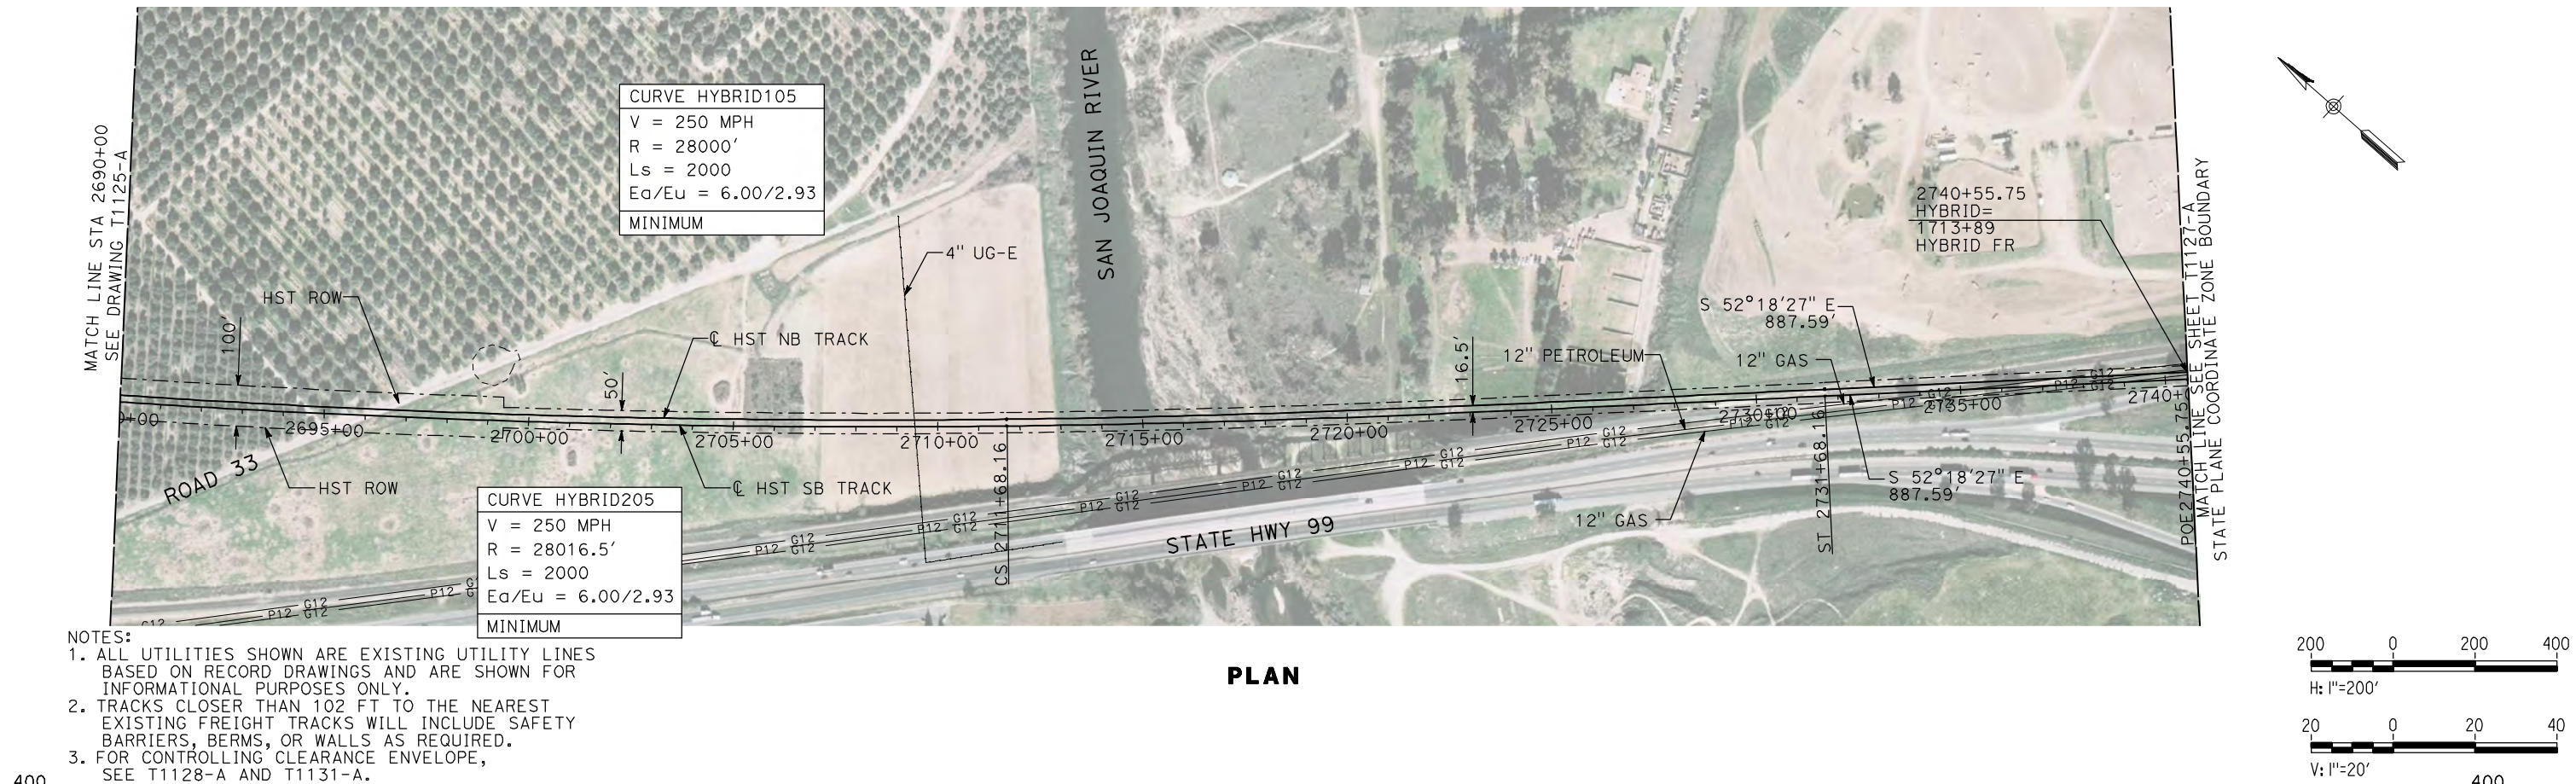
HYBRID

PLAN AND PROFILE  
STA 2635+00 TO STA 2690+00

CONTRACT NO. HSR06-007
DRAWING NO. T1125-A
SCALE AS SHOWN
SHEET NO. ### OF ###



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REV	DATE	BY	CHK	APP	DESCRIPTION

DESIGNED BY A. SHIELDS
DRAWN BY H. SULLIVAN
CHECKED BY A. BOONE
IN CHARGE A. BOONE
DATE 07/20/2011

RECORD SET  
15% DESIGN  
SUBMITTAL

NOT FOR  
CONSTRUCTION

**AECOM**  
Technical Services, Inc.  
2020 L Street, Suite 300  
Sacramento, CA 95811

**CH2M HILL**

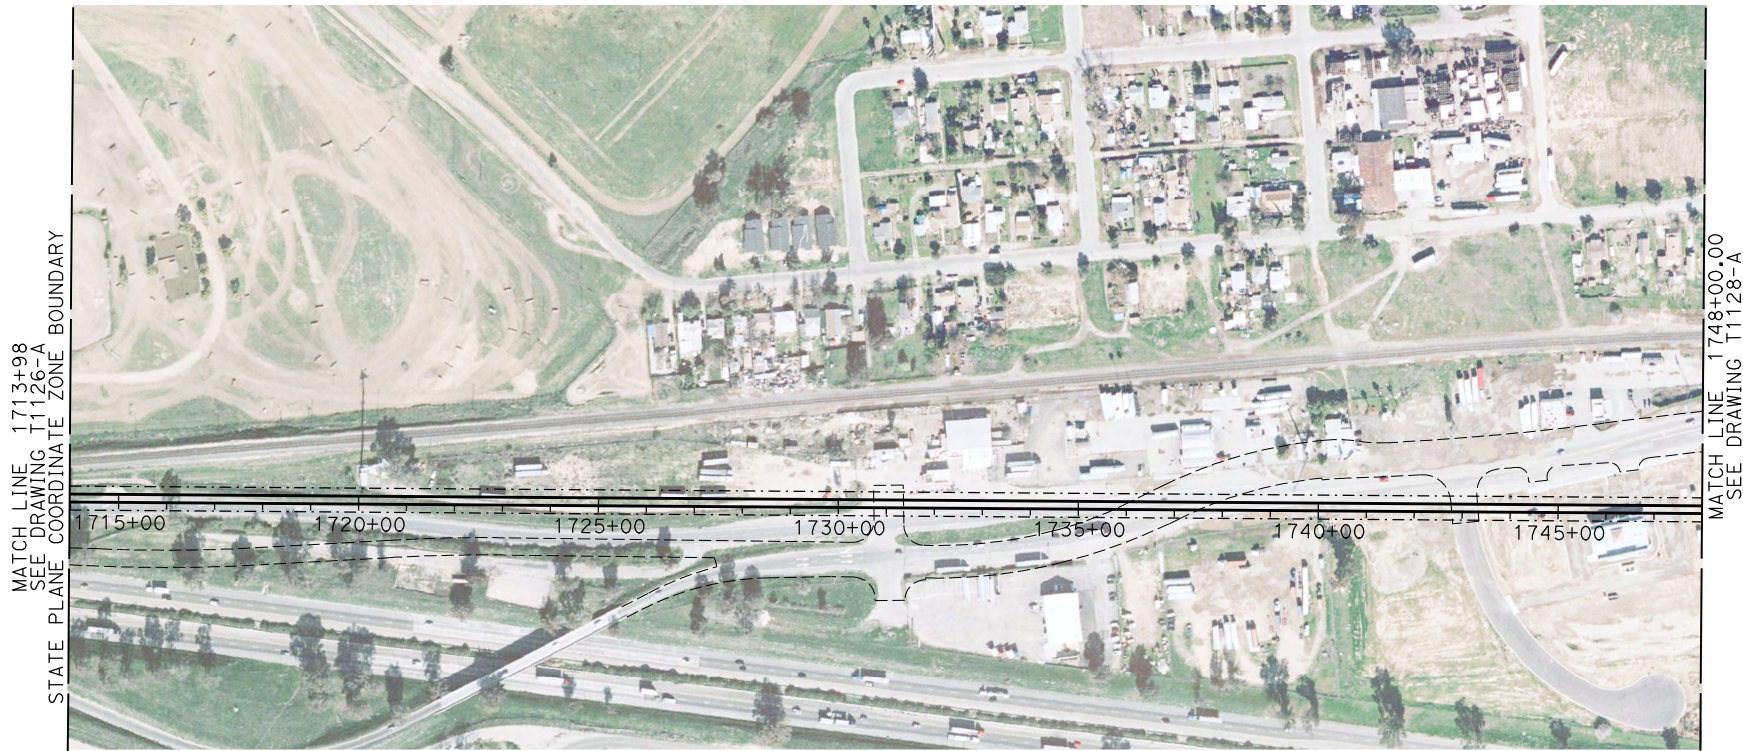


**CALIFORNIA HIGH-SPEED TRAIN PROJECT  
MERCED TO FRESNO**

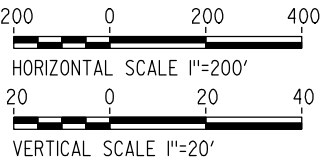
PLAN AND PROFILE  
STA 2690+00 TO STA 2740+55.75

CONTRACT NO. HSR06-007
DRAWING NO. T1126-A
SCALE AS SHOWN
SHEET NO. ### OF ###



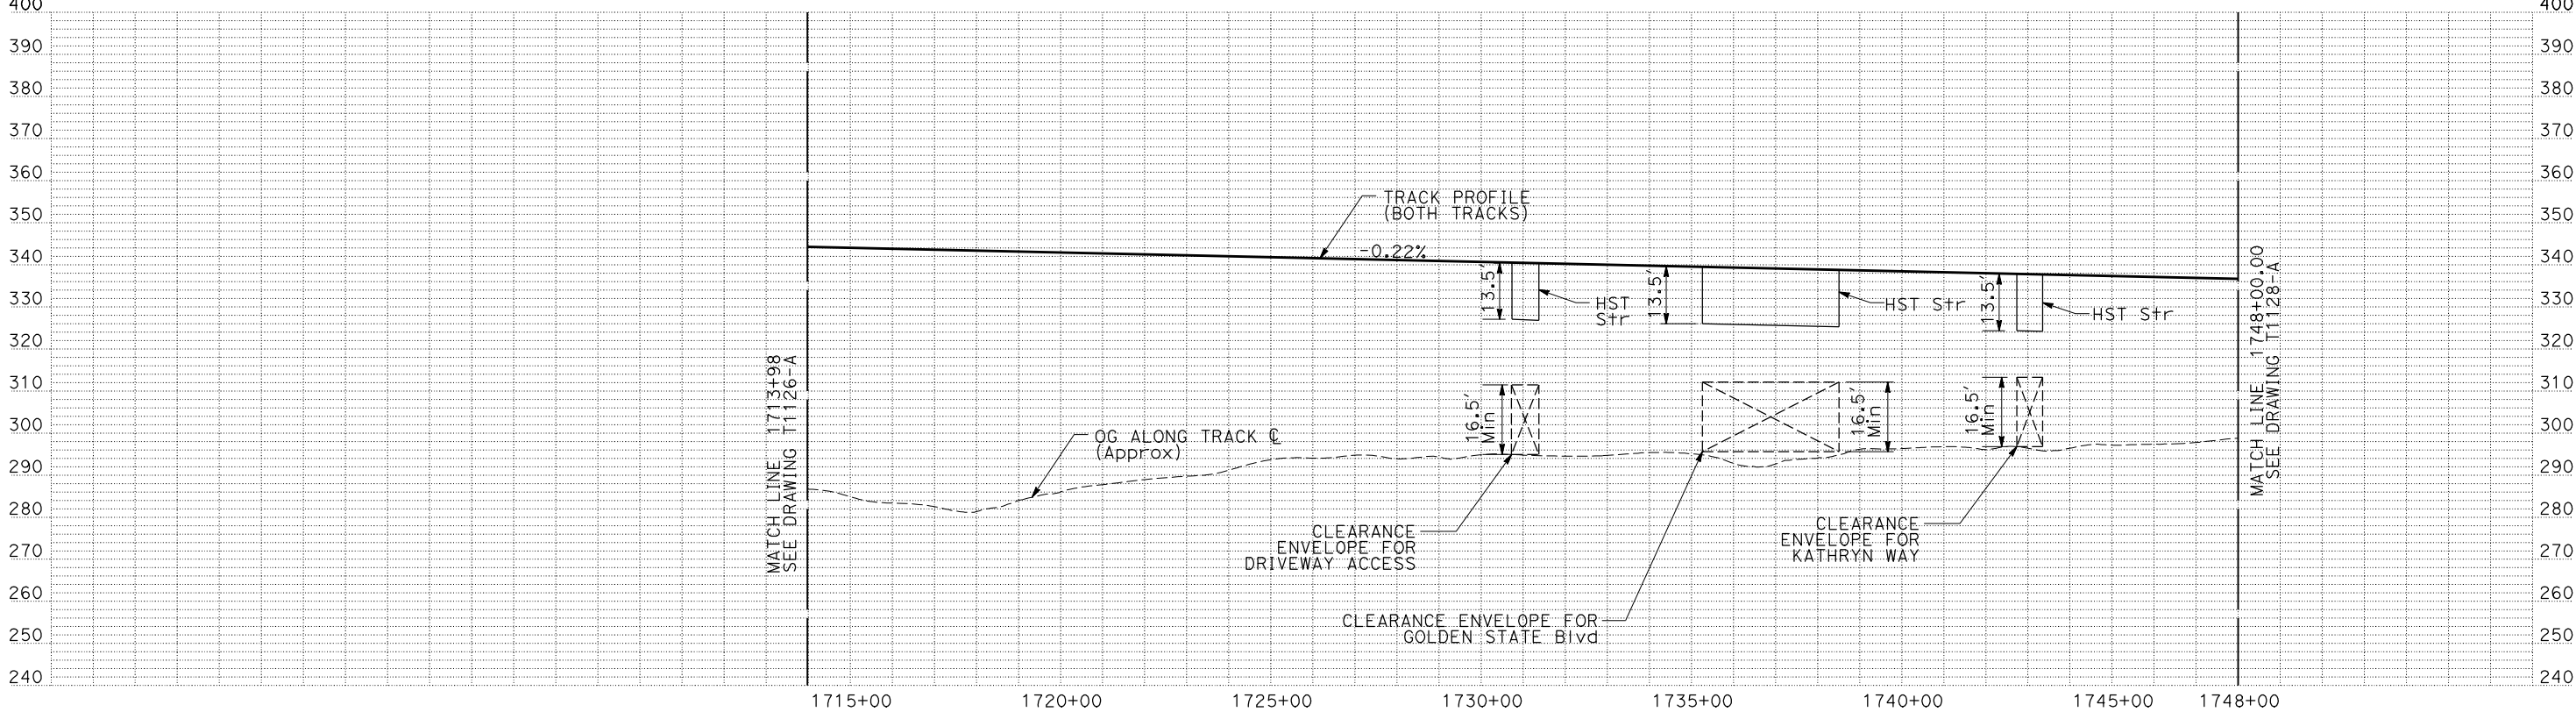


PLAN



NOTES:

1. ALL UTILITIES SHOWN ARE EXISTING UTILITY LINES  
BASED ON RECORD DRAWINGS AND ARE SHOWN FOR  
INFORMATIONAL PURPOSES ONLY.
2. TRACKS CLOSER THAN 102 FT TO THE NEAREST EXISTING FREIGHT TRACKS  
WILL INCLUDE SAFETY BARRIERS, BERMS, OR WALLS AS REQUIRED.



PROFILE

"SEE T3000-T3017 DRAWINGS FOR  
TYPICAL SECTION LIMITS AND DETAILS"

REV	DATE	BY	CHK	APP	DESCRIPTION

DESIGNED BY C. CHIU
DRAWN BY M. MCKEON
CHECKED BY V. CHIO
IN CHARGE J. VALSECCHI
DATE MAY 2011

RECORD SET 15% DESIGN SUBMITTAL
NOT FOR CONSTRUCTION

**AECOM**  
Technical Services, Inc.  
2020 L Street, Suite 300  
Sacramento, CA 95811

**CH2MHILL**



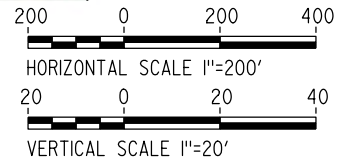
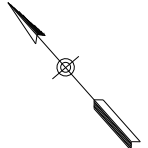
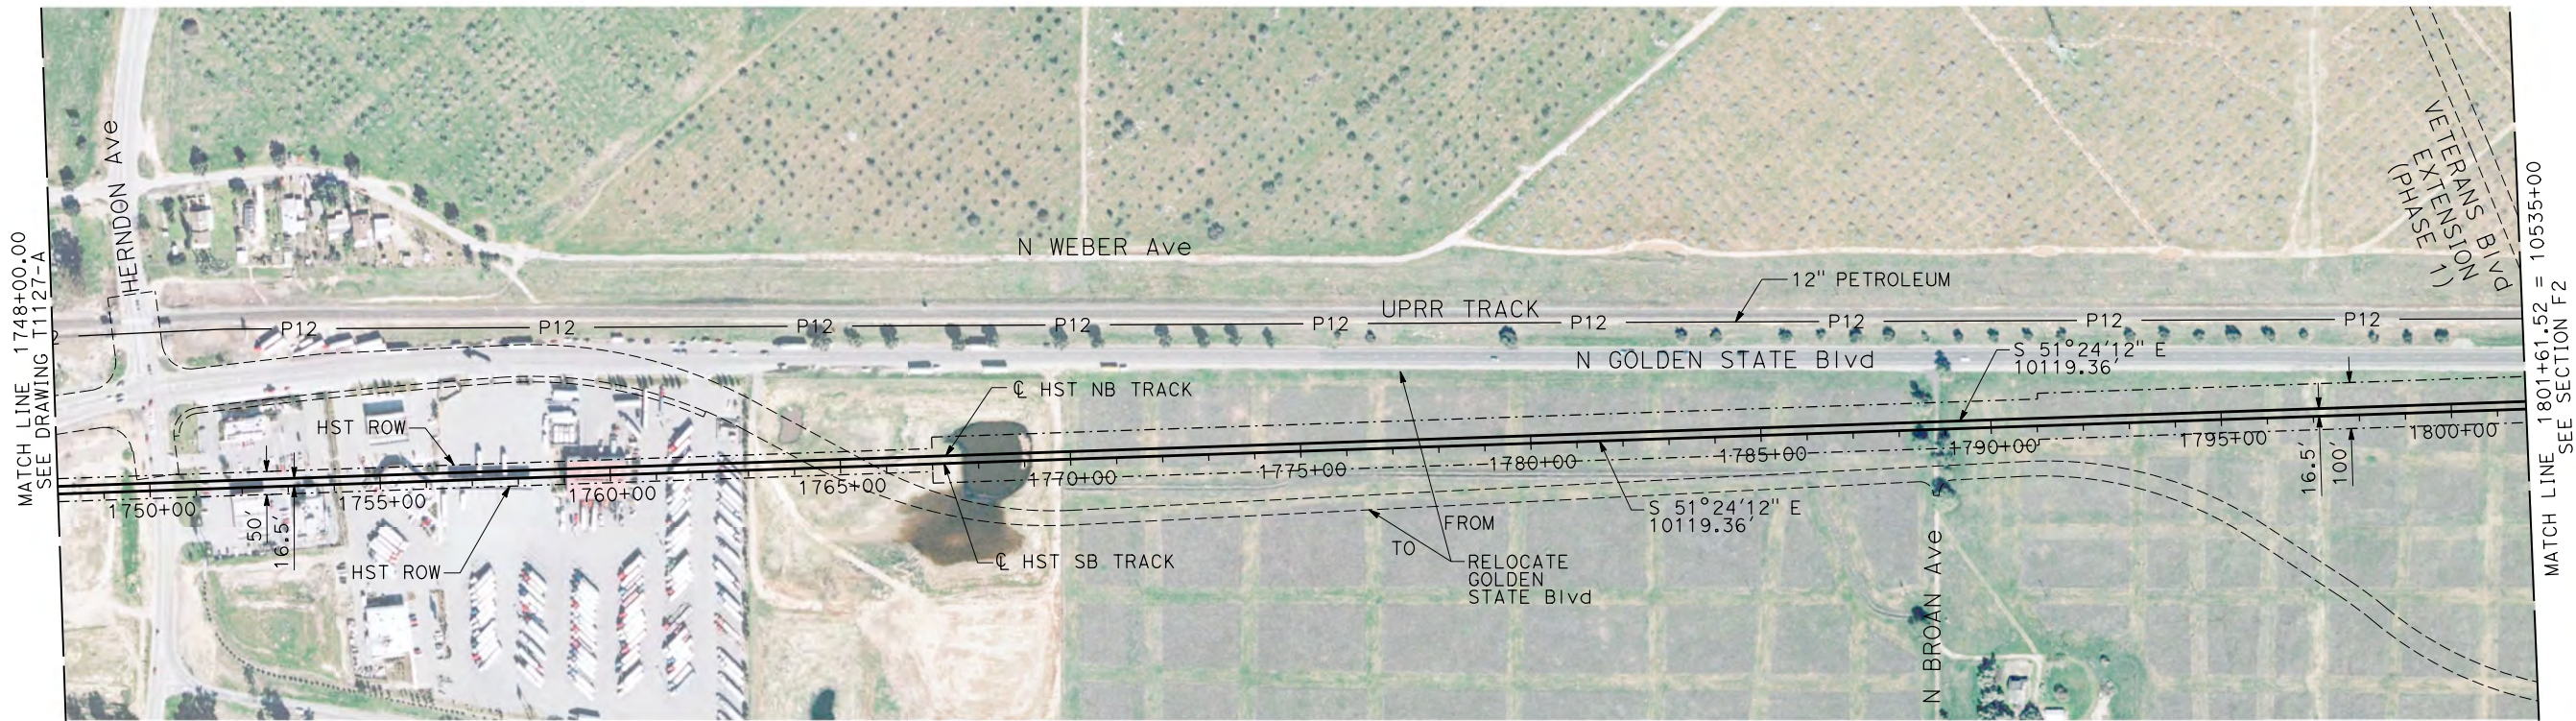
**CALIFORNIA HIGH-SPEED TRAIN PROJECT  
MERCED TO FRESNO**

HYBRID

PLAN AND PROFILE  
STA 1713+98 TO STA 1748+00

CONTRACT NO. HSR06-007
DRAWING NO. T1127-A
SCALE AS SHOWN
SHEET NO.

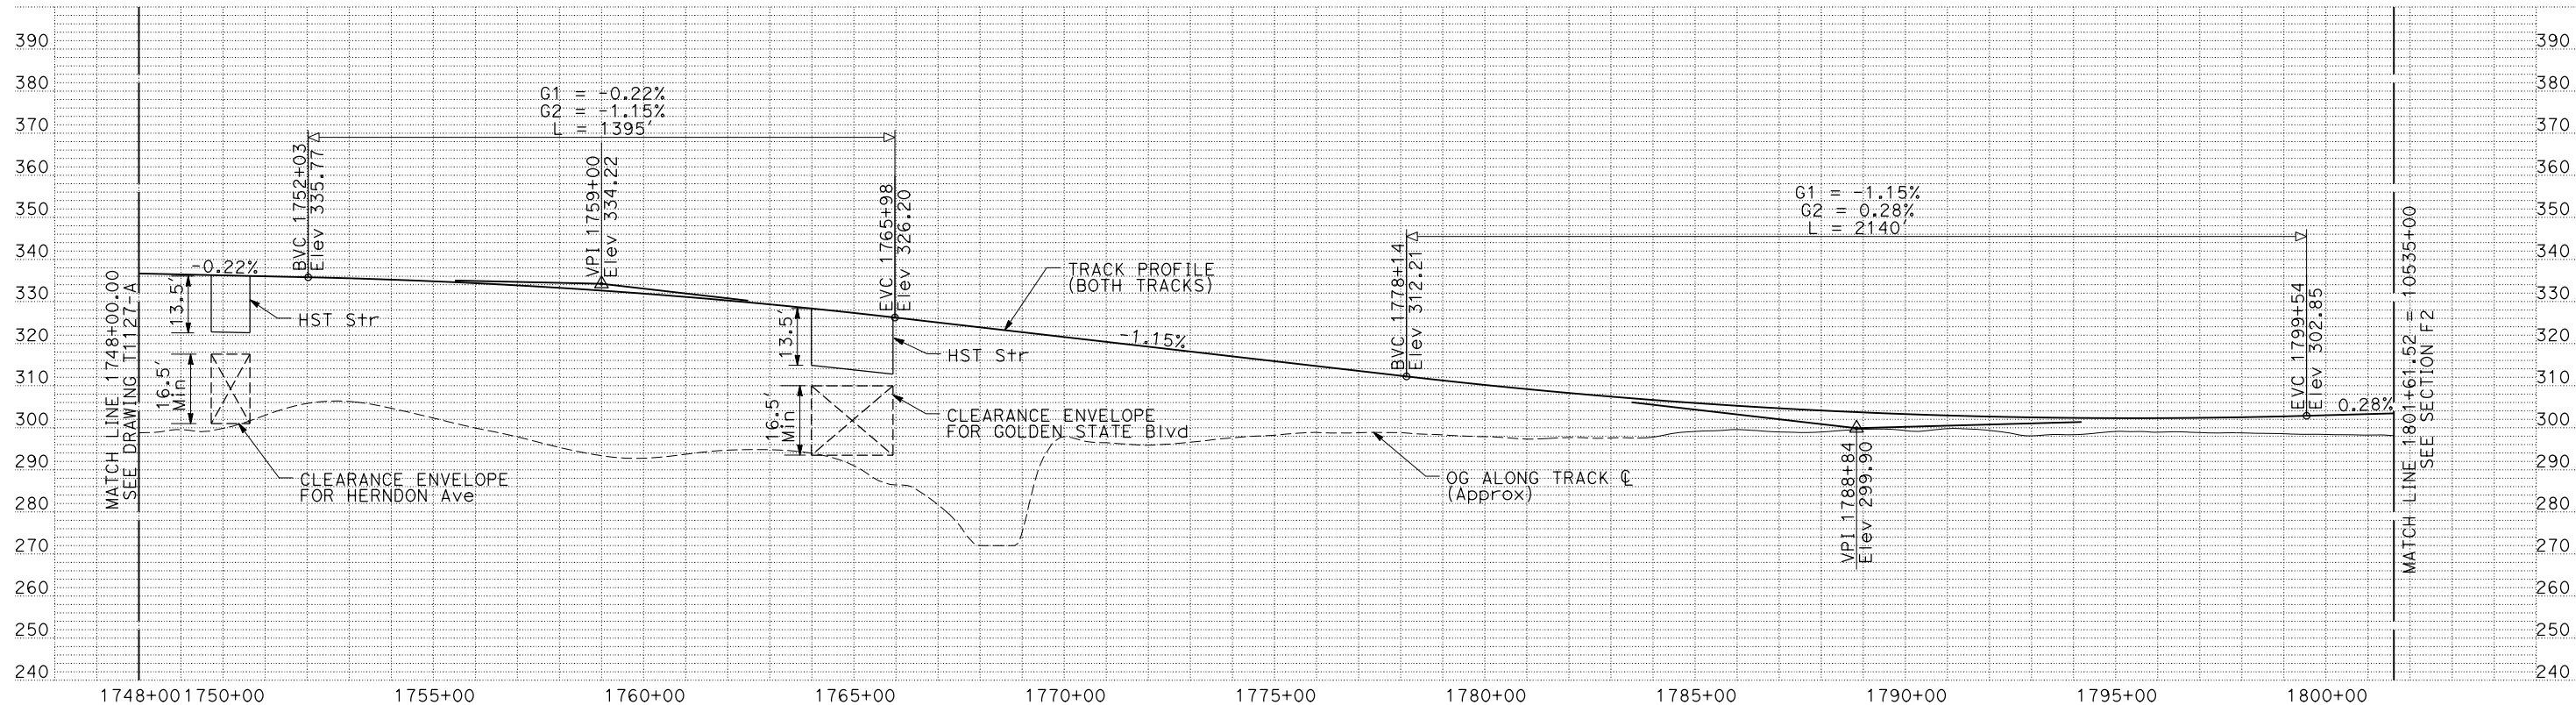




NOTES:

1. ALL UTILITIES SHOWN ARE EXISTING UTILITY LINES BASED ON RECORD DRAWINGS AND ARE SHOWN FOR INFORMATIONAL PURPOSES ONLY.
2. TRACKS CLOSER THAN 102 FT TO THE NEAREST EXISTING FREIGHT TRACKS WILL INCLUDE SAFETY BARRIERS, BERMS, OR WALLS AS REQUIRED.

PLAN



PROFILE

"SEE T3000-T3017 DRAWINGS FOR  
TYPICAL SECTION LIMITS AND DETAILS"

REV	DATE	BY	CHK	APP	DESCRIPTION

DESIGNED BY C. CHIU
DRAWN BY M. MCKEON
CHECKED BY V. CHIO
IN CHARGE J. VALSECCHI
DATE MAY 2011

RECORD SET 15% DESIGN SUBMITTAL
NOT FOR CONSTRUCTION



CALIFORNIA HIGH-SPEED TRAIN PROJECT  
MERCED TO FRESNO

HYBRID

PLAN AND PROFILE  
STA 1748+00 TO STA 1801+61.52

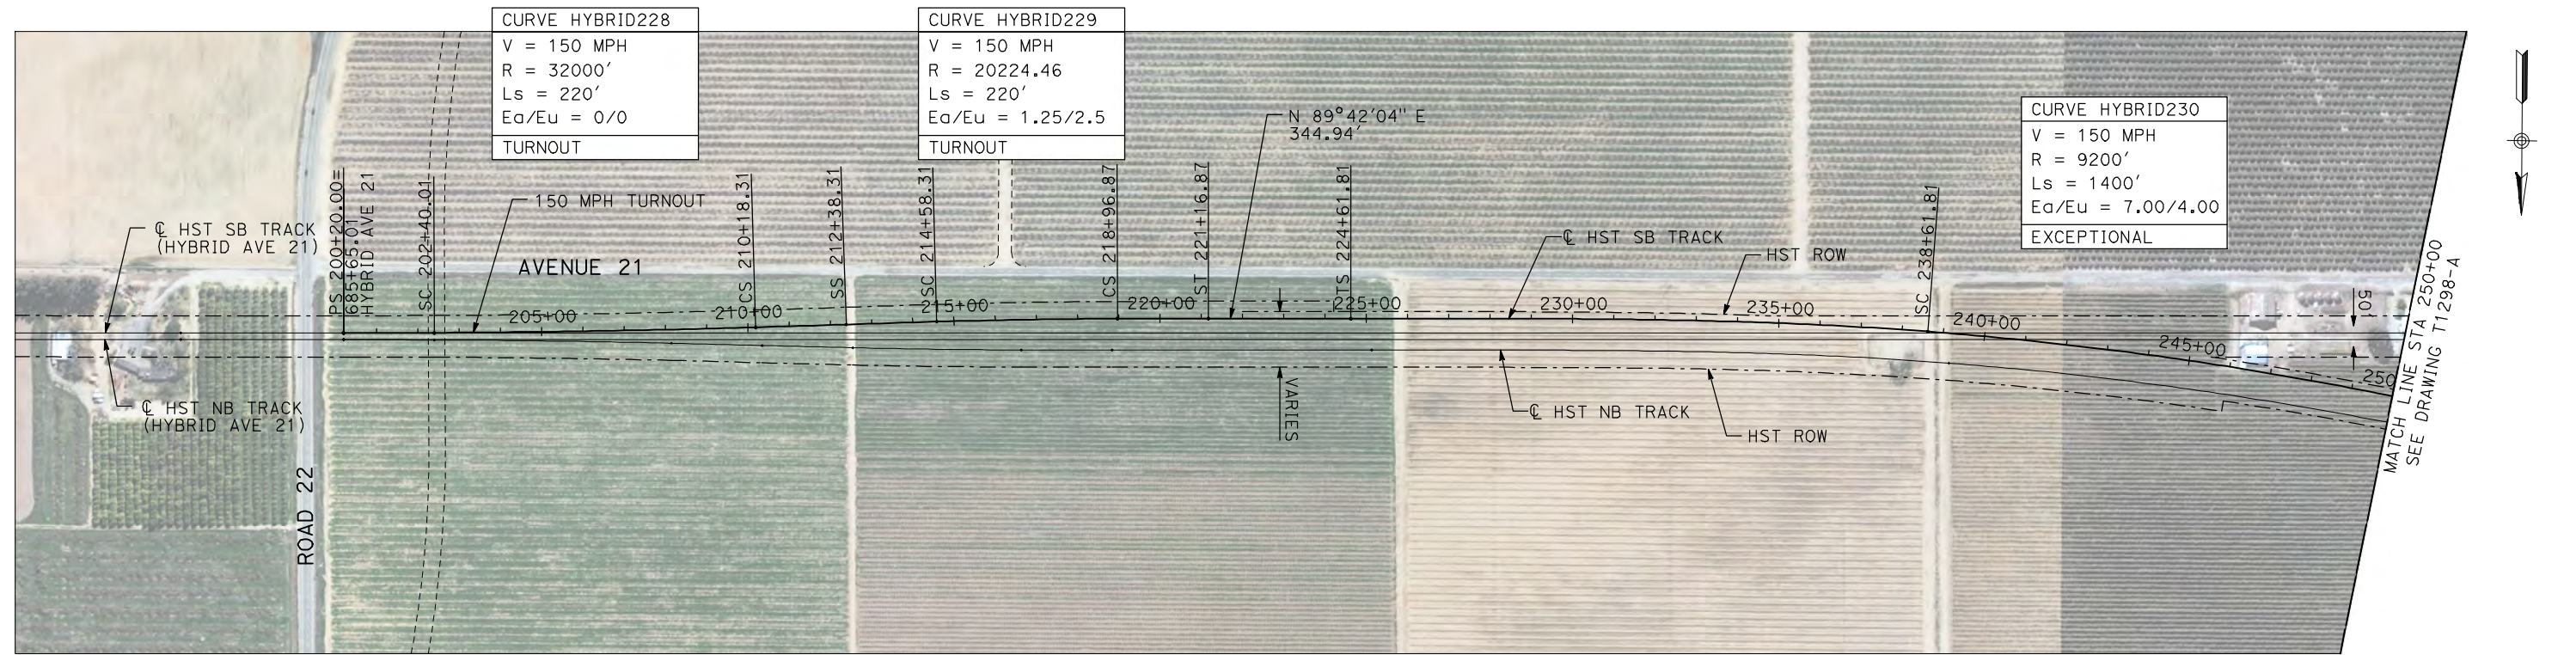
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SCALE AS SHOWN
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USERNAME => s1eona

DATE PLOTTED => 05-JAN-2012

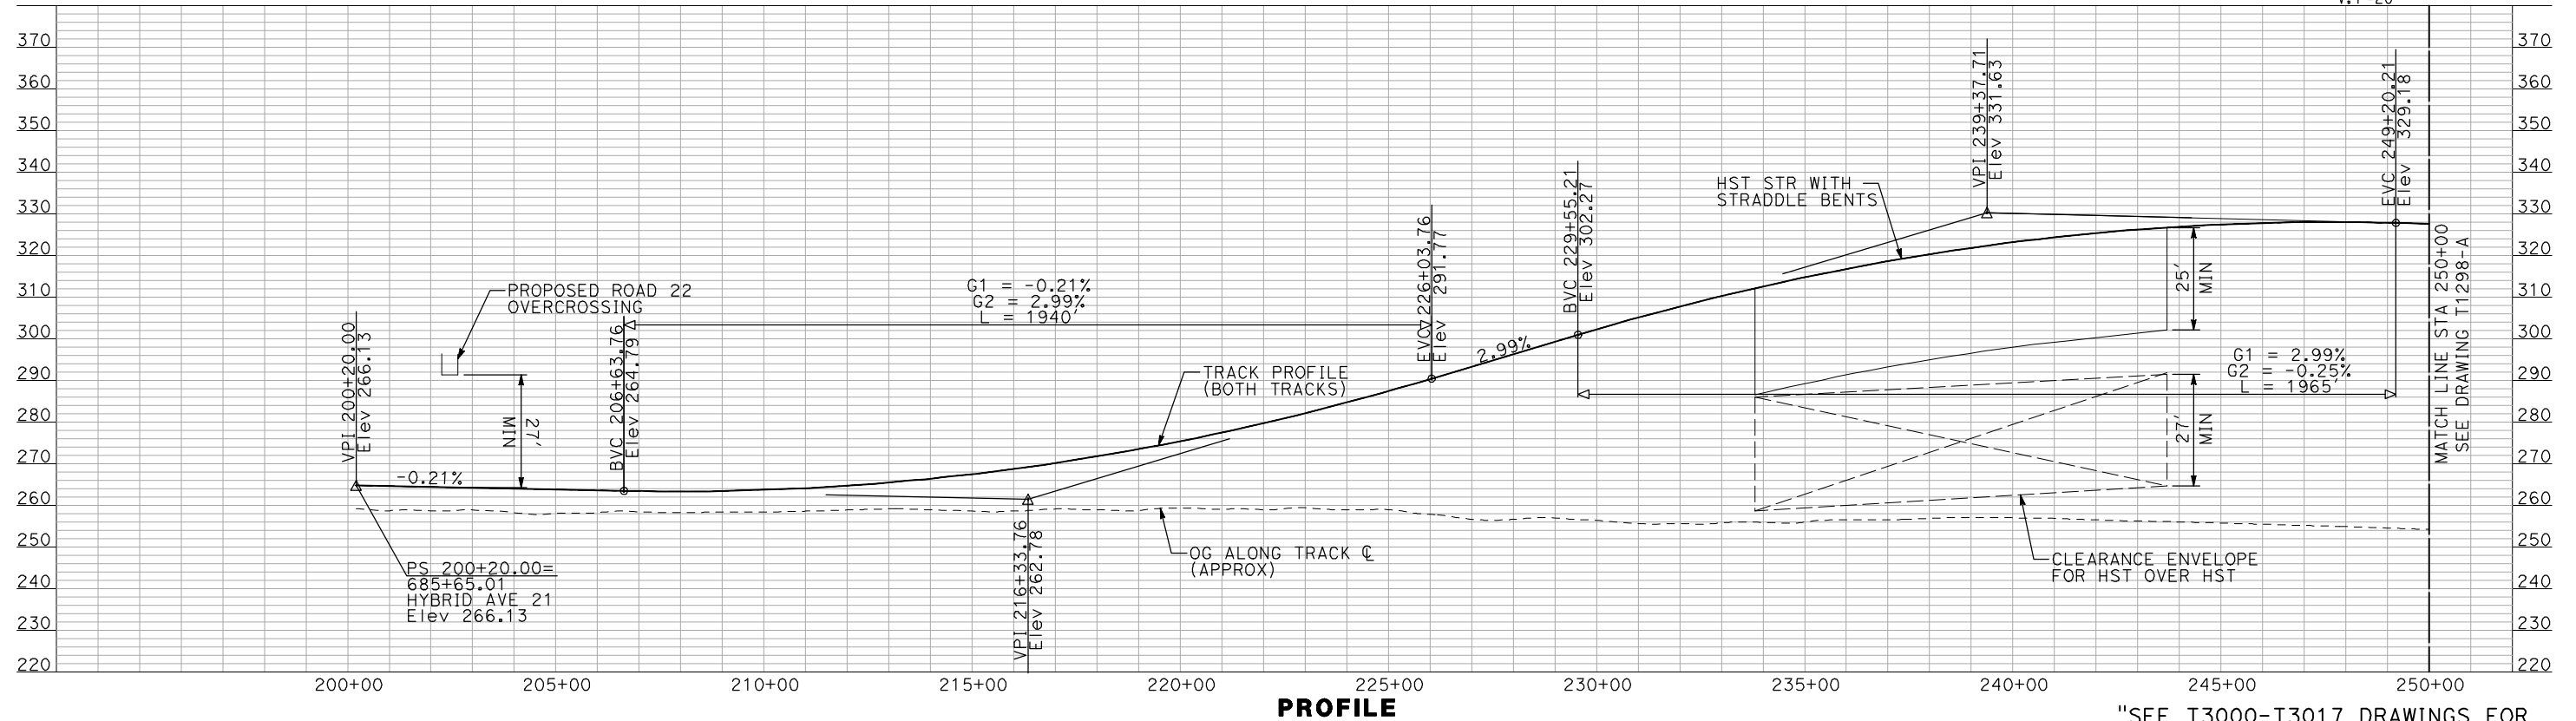
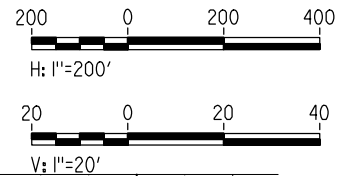


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- NOTES:
1. ALL UTILITIES SHOWN ARE EXISTING UTILITY LINES BASED ON RECORD DRAWINGS AND ARE SHOWN FOR INFORMATIONAL PURPOSES ONLY.
  2. TRACKS CLOSER THAN 102 FT TO THE NEAREST EXISTING FREIGHT TRACKS WILL INCLUDE SAFETY BARRIERS, BERMS, OR WALLS AS REQUIRED.

PLAN



PROFILE

"SEE T3000-T3017 DRAWINGS FOR  
TYPICAL SECTION LIMITS AND DETAILS"

REV	DATE	BY	CHK	APP	DESCRIPTION

DESIGNED BY A. SHIELDS
DRAWN BY H. SULLIVAN
CHECKED BY A. BOONE
IN CHARGE A. BOONE
DATE 07/20/2011

RECORD SET  
15% DESIGN  
SUBMITTAL

NOT FOR  
CONSTRUCTION

**AECOM**  
Technical Services, Inc.  
2020 L Street, Suite 300  
Sacramento, CA 95811

**CH2M HILL**



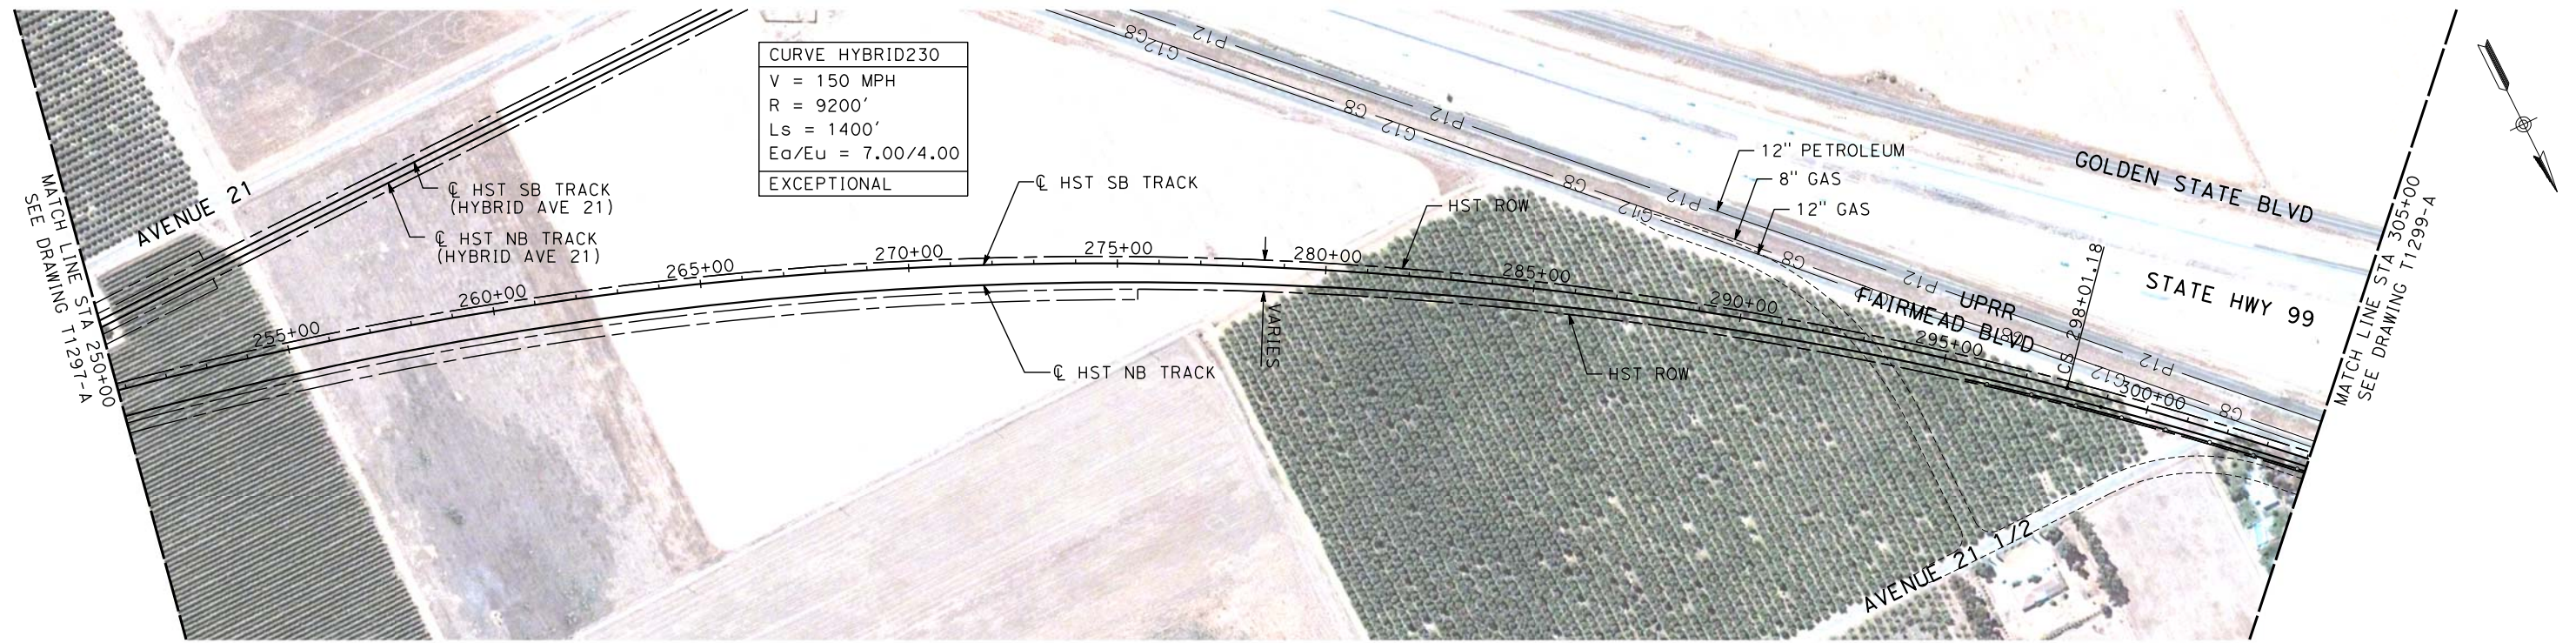
**CALIFORNIA HIGH-SPEED TRAIN PROJECT  
MERCED TO FRESNO**

HYBRID - SB MERCED CONNECTION  
AVENUE 21  
PLAN AND PROFILE  
STA 200+20 TO STA 250+00

CONTRACT NO. HSR06-007
DRAWING NO. T2197-A
SCALE AS SHOWN
SHEET NO. ### OF ###

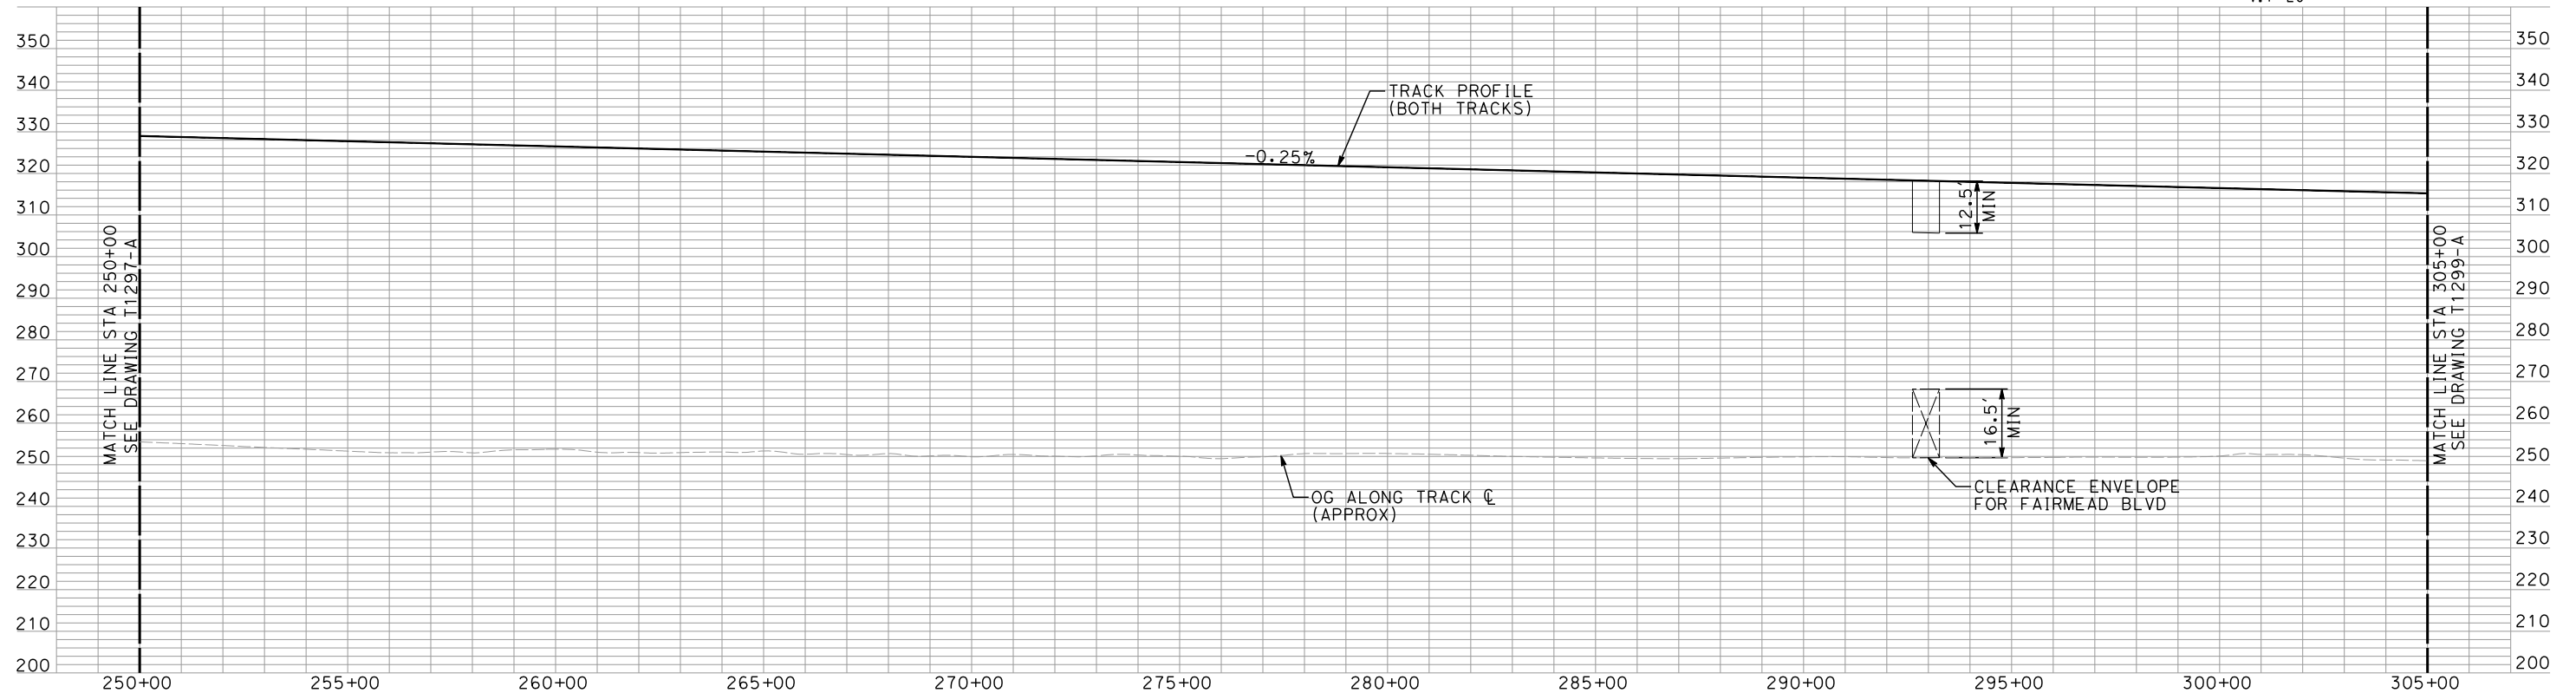
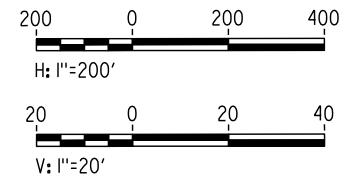


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- NOTES:
1. ALL UTILITIES SHOWN ARE EXISTING UTILITY LINES BASED ON RECORD DRAWINGS AND ARE SHOWN FOR INFORMATIONAL PURPOSES ONLY.
  2. TRACKS CLOSER THAN 102 FT TO THE NEAREST EXISTING FREIGHT TRACKS WILL INCLUDE SAFETY BARRIERS, BERMS, OR WALLS AS REQUIRED.

PLAN



PROFILE

"SEE T3000-T3017 DRAWINGS FOR  
TYPICAL SECTION LIMITS AND DETAILS"

REV	DATE	BY	CHK	APP	DESCRIPTION

DESIGNED BY A. SHIELDS
DRAWN BY H. SULLIVAN
CHECKED BY A. BOONE
IN CHARGE A. BOONE
DATE 07/27/2011

**RECORD SET**  
**15% DESIGN**  
**SUBMITTAL**

**NOT FOR**  
**CONSTRUCTION**

**AECOM**  
Technical Services, Inc.  
2020 L Street, Suite 300  
Sacramento, CA 95811

**CH2MHILL**



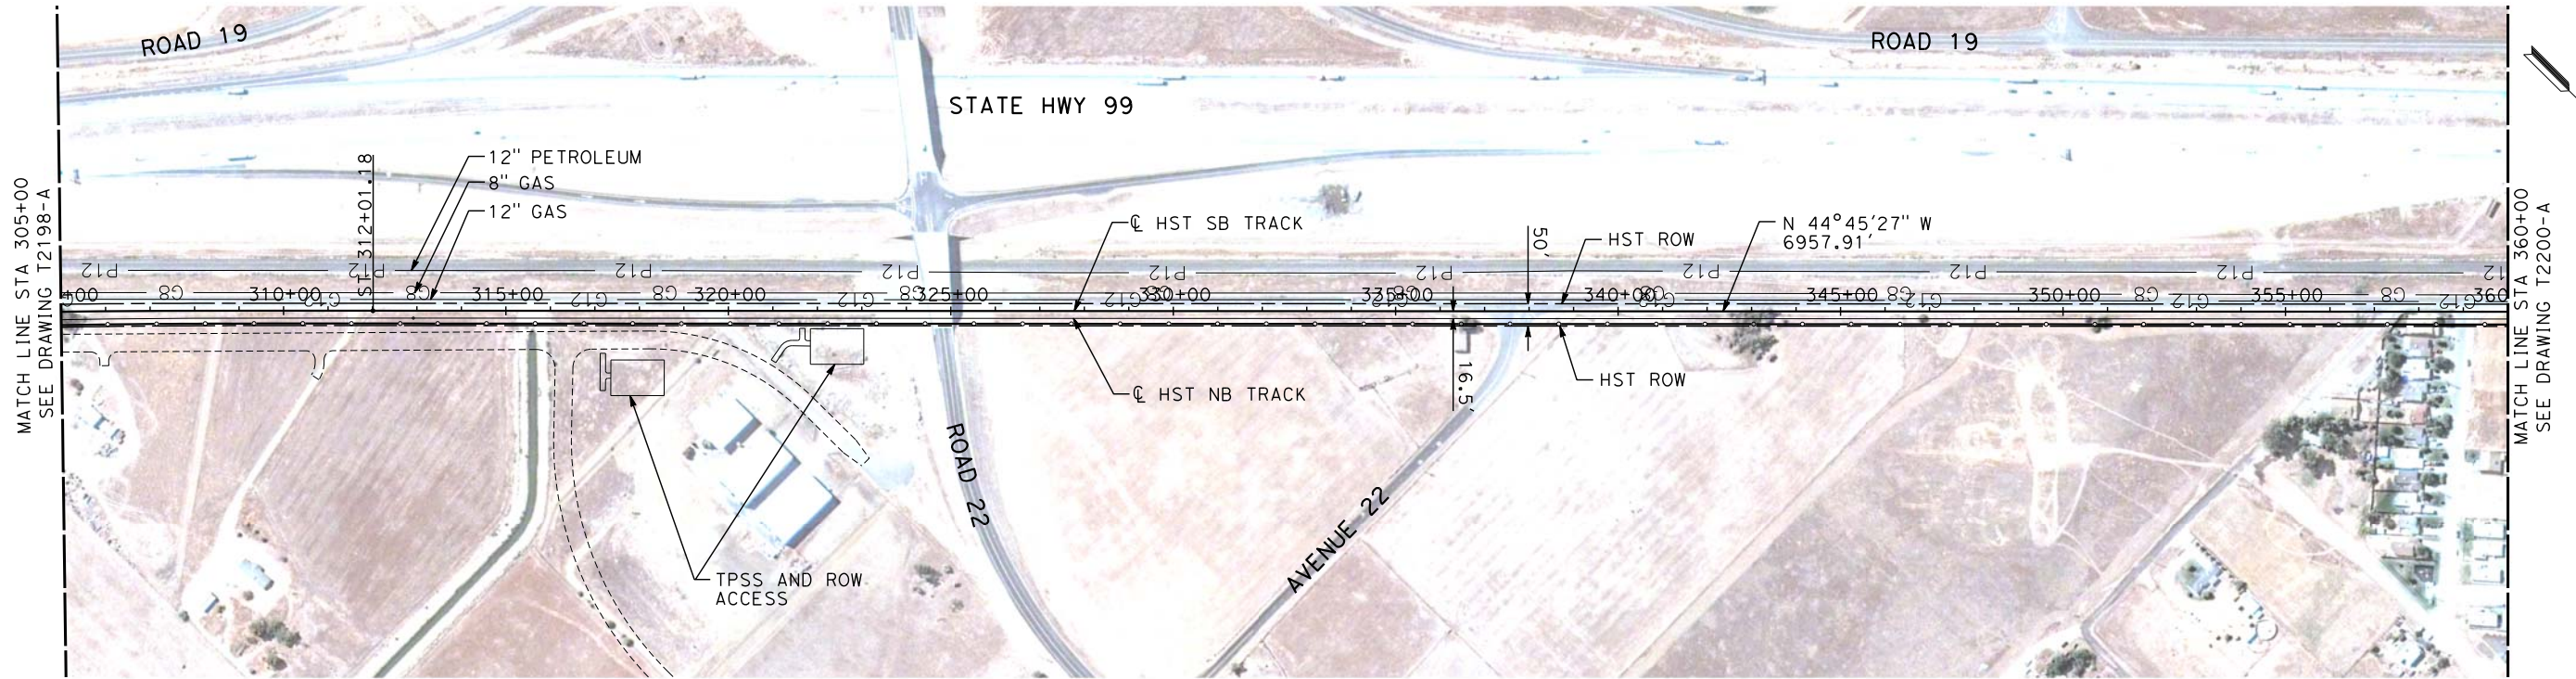
**CALIFORNIA HIGH-SPEED TRAIN PROJECT**  
**MERCED TO FRESNO**  
HYBRID - SB MERCED CONNECTION  
AVENUE 21  
PLAN AND PROFILE  
STA 250+00 TO STA 305+00

CONTRACT NO. HSR06-007
DRAWING NO. T2198-A
SCALE AS SHOWN
SHEET NO. ### OF ###

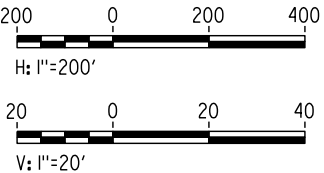


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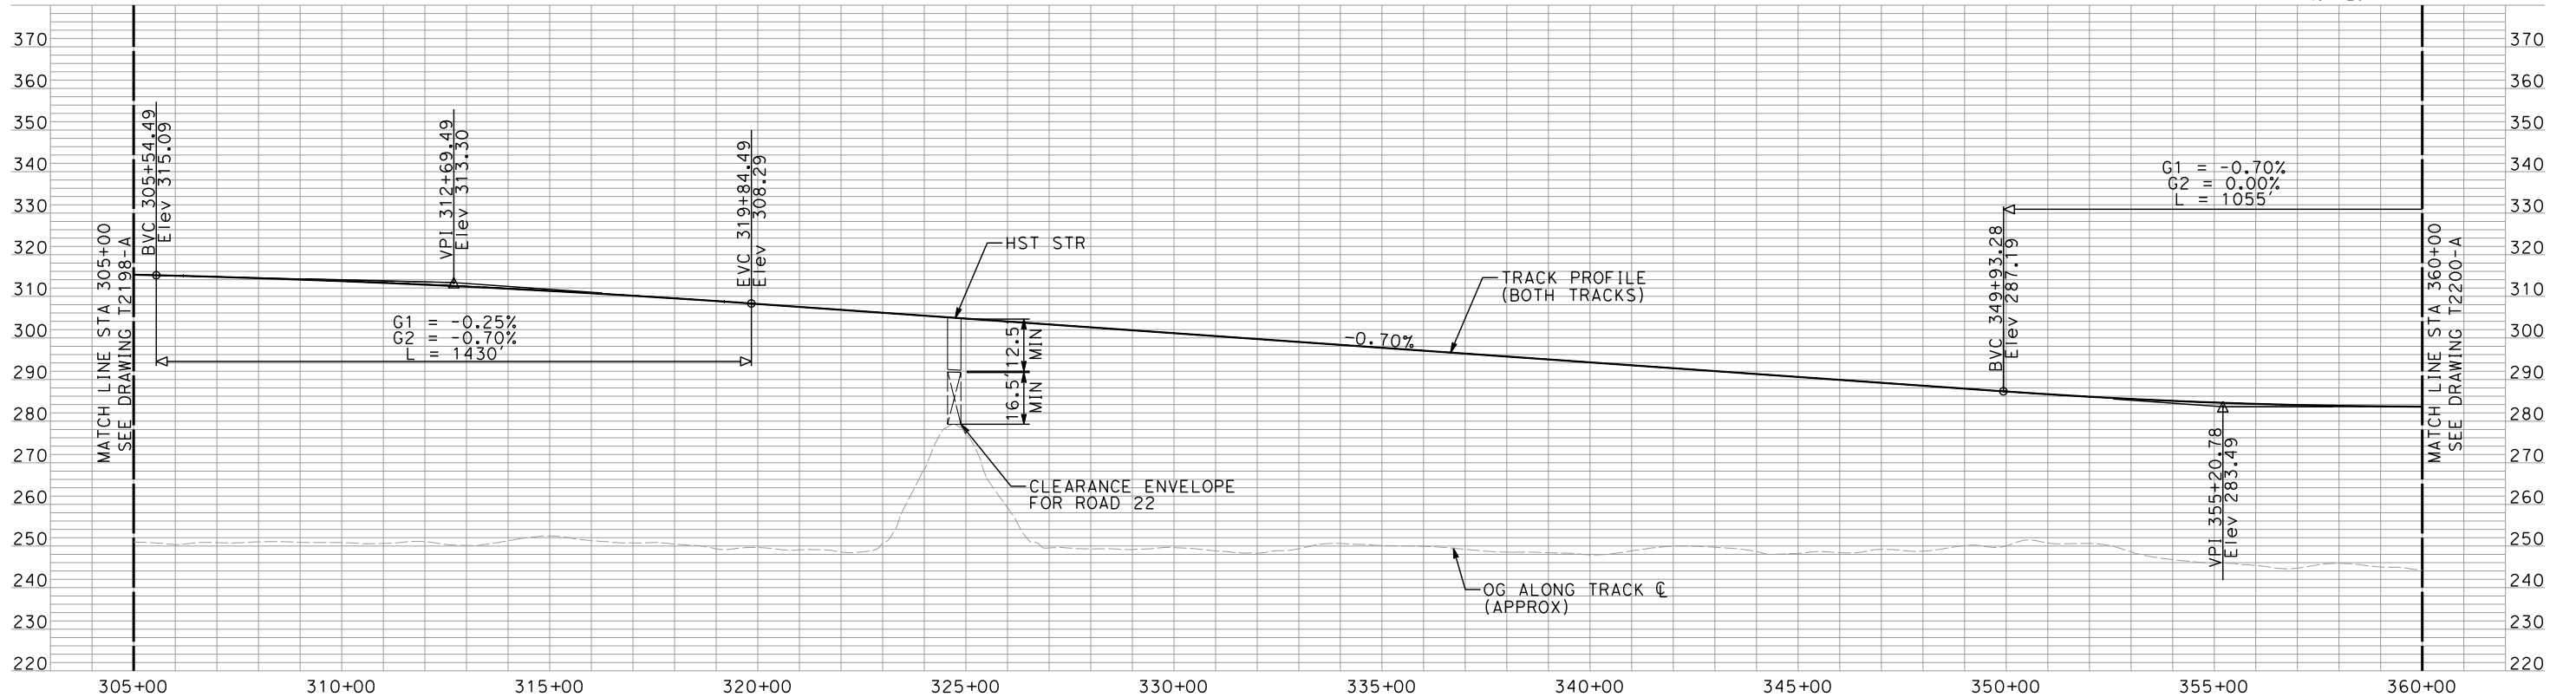
shieldsa



PLAN



- NOTES:
1. ALL UTILITIES SHOWN ARE EXISTING UTILITY LINES BASED ON RECORD DRAWINGS AND ARE SHOWN FOR INFORMATIONAL PURPOSES ONLY.
  2. TRACKS CLOSER THAN 102 FT TO THE NEAREST EXISTING FREIGHT TRACKS WILL INCLUDE SAFETY BARRIERS, BERMS, OR WALLS AS REQUIRED.



PROFILE

"SEE T3000-T3017 DRAWINGS FOR  
TYPICAL SECTION LIMITS AND DETAILS"

REV	DATE	BY	CHK	APP	DESCRIPTION

DESIGNED BY A. SHIELDS
DRAWN BY H. SULLIVAN
CHECKED BY A. BOONE
IN CHARGE A. BOONE
DATE 07/27/2011

RECORD SET  
15% DESIGN  
SUBMITTAL

NOT FOR  
CONSTRUCTION

**AECOM**  
Technical Services, Inc.  
2020 L Street, Suite 300  
Sacramento, CA 95811  
**CH2MHILL**

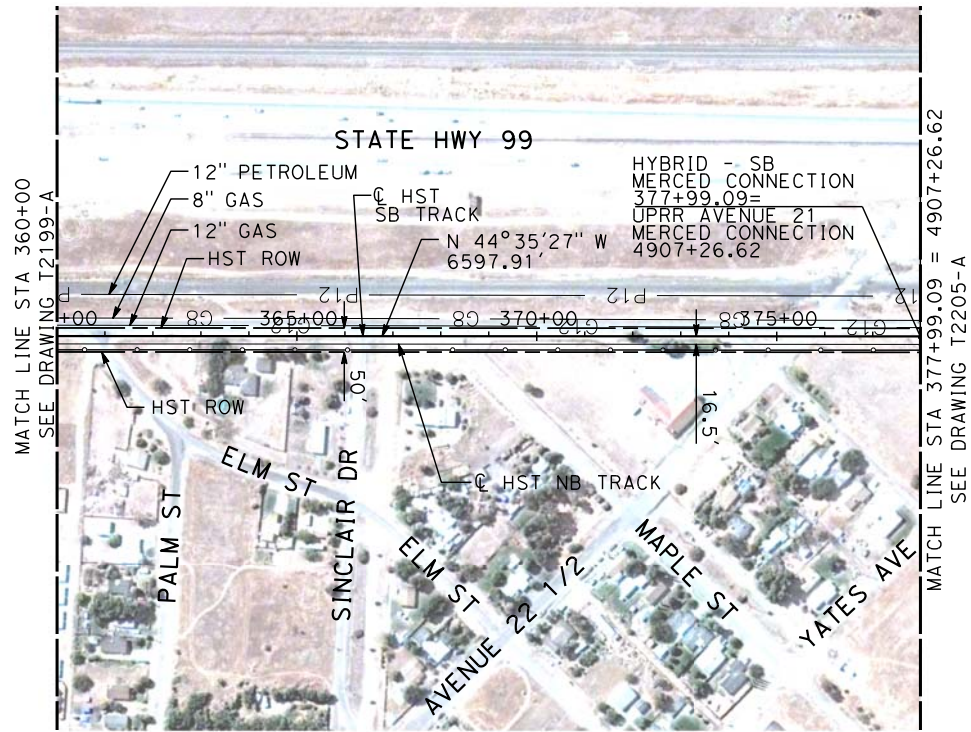


**CALIFORNIA HIGH-SPEED TRAIN PROJECT**  
**MERCED TO FRESNO**  
HYBRID - SB MERCED CONNECTION  
AVENUE 21  
PLAN AND PROFILE  
STA 305+00 TO STA 360+00

CONTRACT NO. HSR06-007
DRAWING NO. T2199-A
SCALE AS SHOWN
SHEET NO. ### OF ###

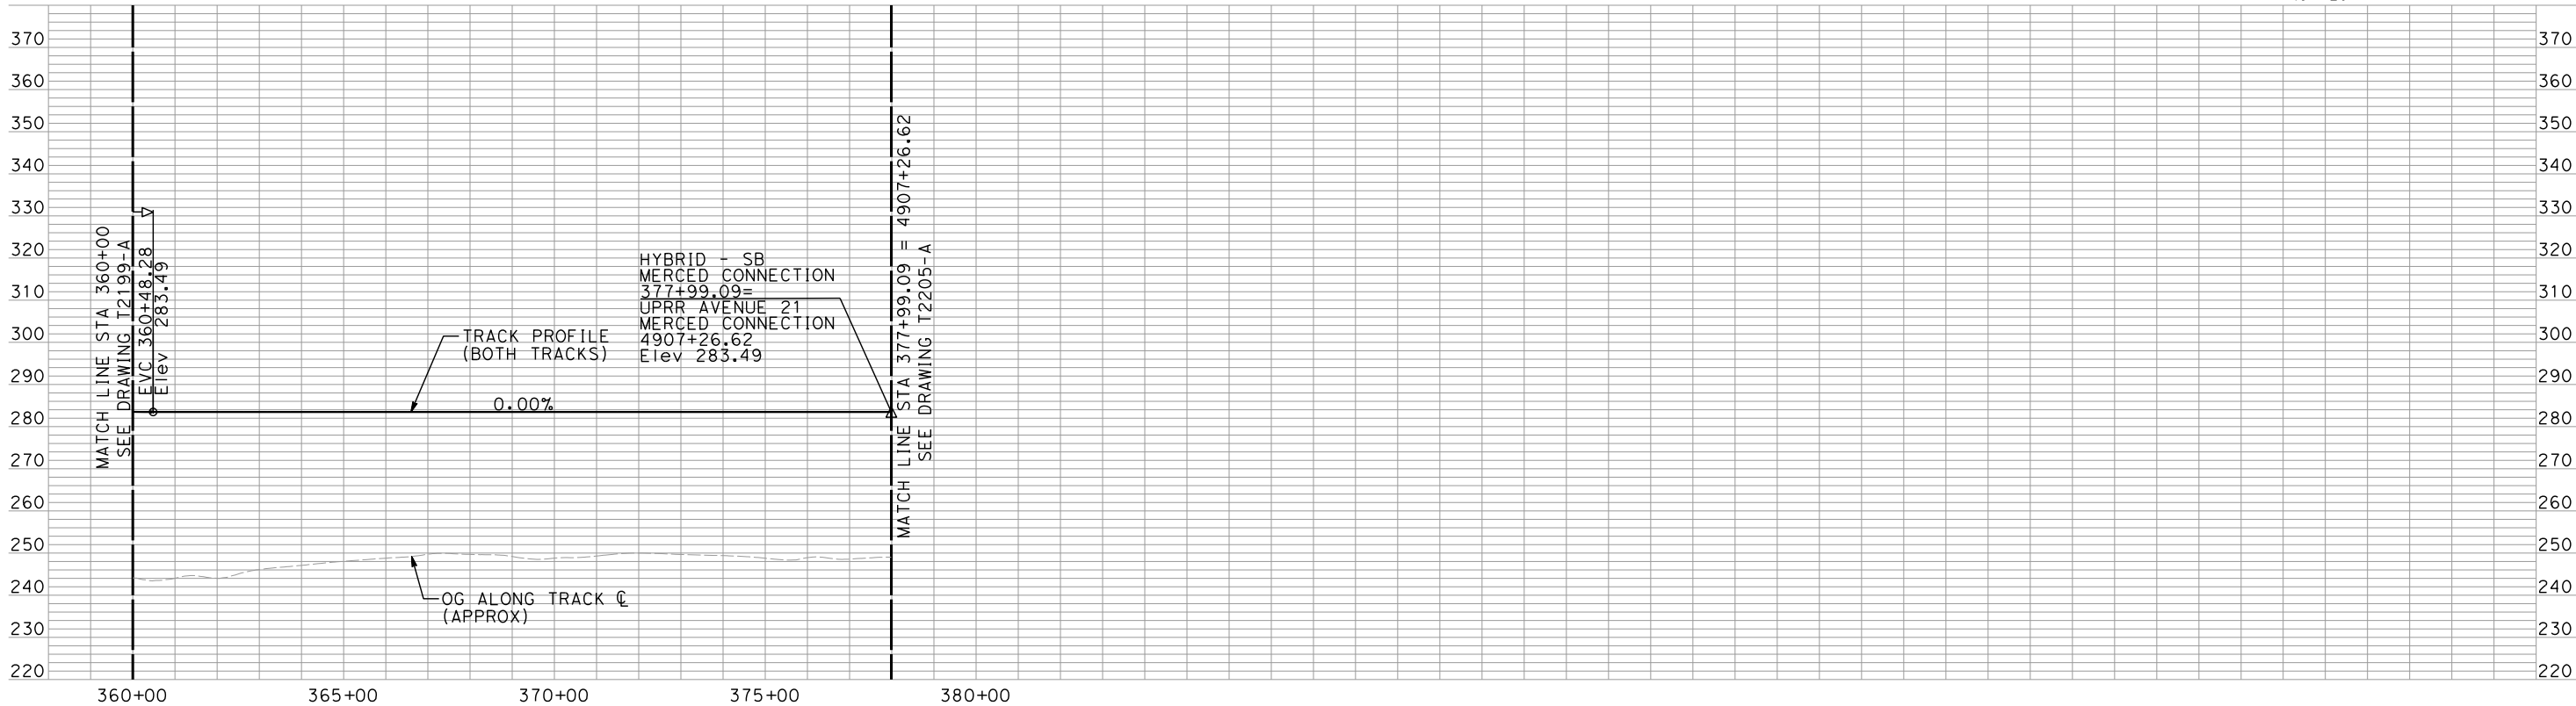
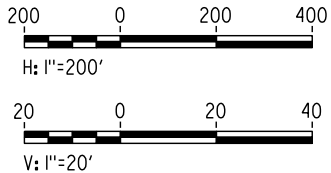


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- NOTES:
1. ALL UTILITIES SHOWN ARE EXISTING UTILITY LINES BASED ON RECORD DRAWINGS AND ARE SHOWN FOR INFORMATIONAL PURPOSES ONLY.
  2. TRACKS CLOSER THAN 102 FT TO THE NEAREST EXISTING FREIGHT TRACKS WILL INCLUDE SAFETY BARRIERS, BERMS, OR WALLS AS REQUIRED.

PLAN



PROFILE

"SEE T3000-T3017 DRAWINGS FOR  
TYPICAL SECTION LIMITS AND DETAILS"

REV	DATE	BY	CHK	APP	DESCRIPTION

DESIGNED BY A. SHIELDS
DRAWN BY H. SULLIVAN
CHECKED BY A. BOONE
IN CHARGE A. BOONE
DATE 07/27/2011

RECORD SET  
15% DESIGN  
SUBMITTAL

NOT FOR  
CONSTRUCTION



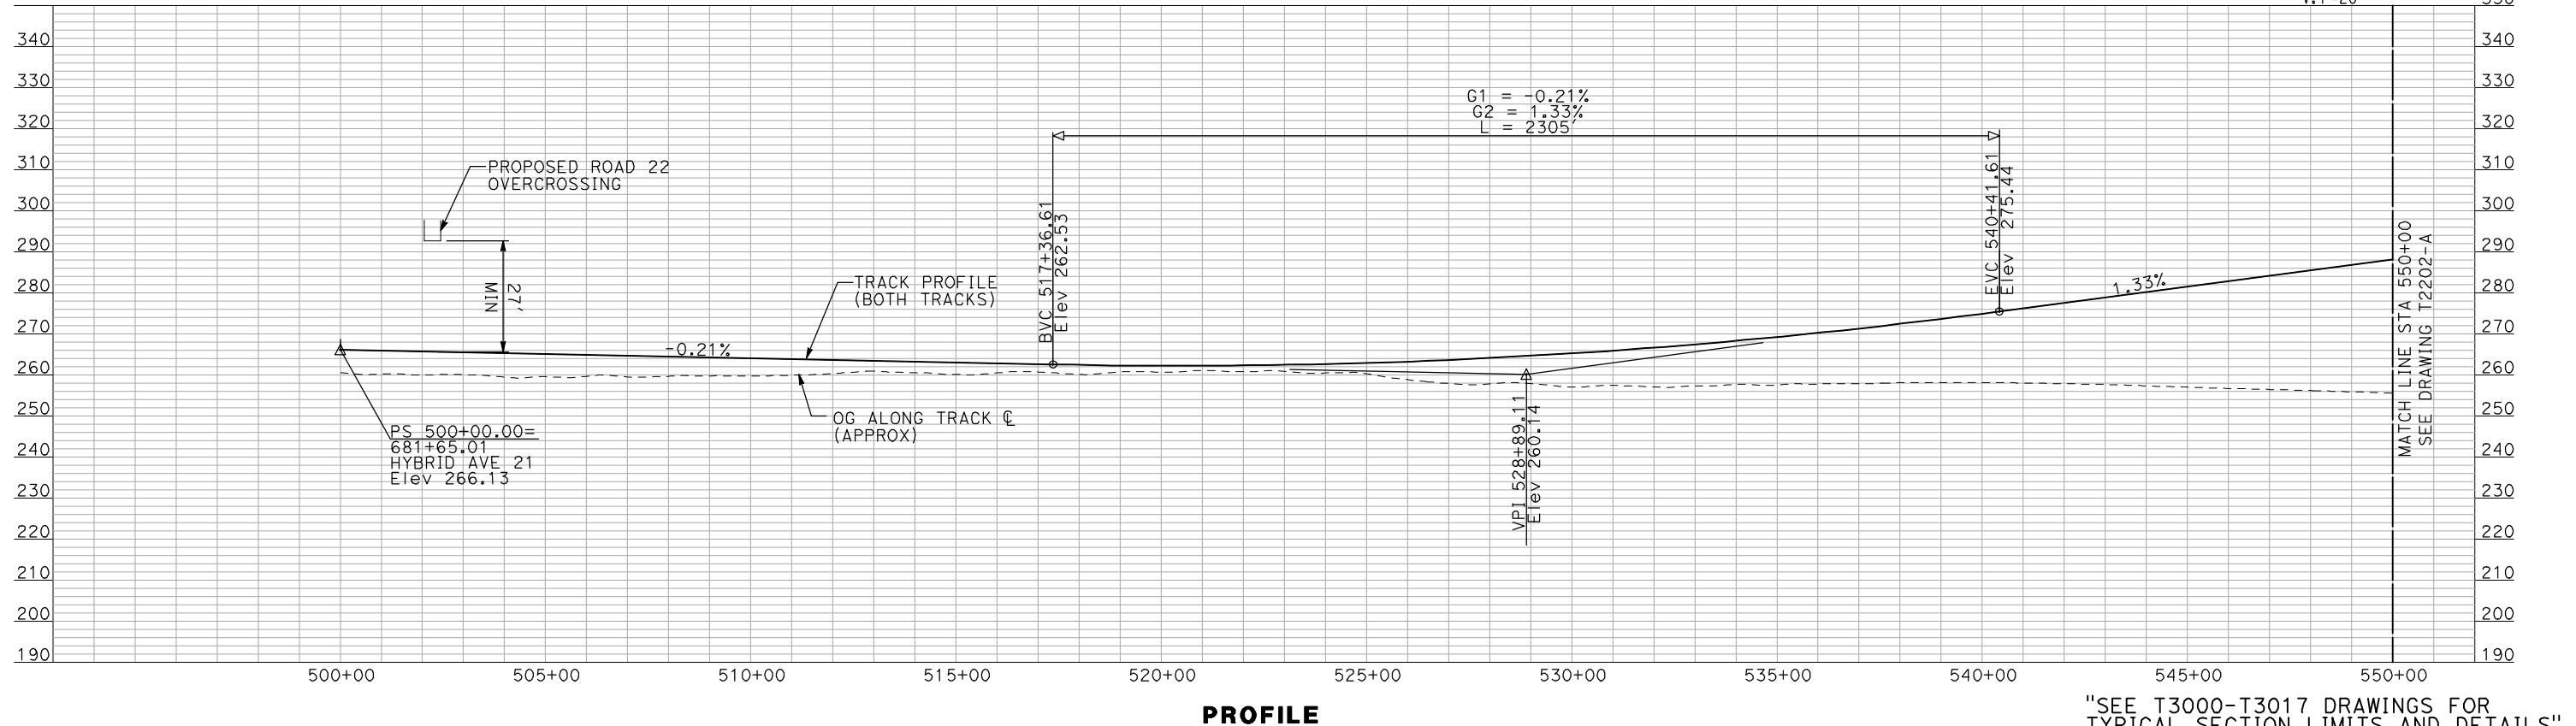
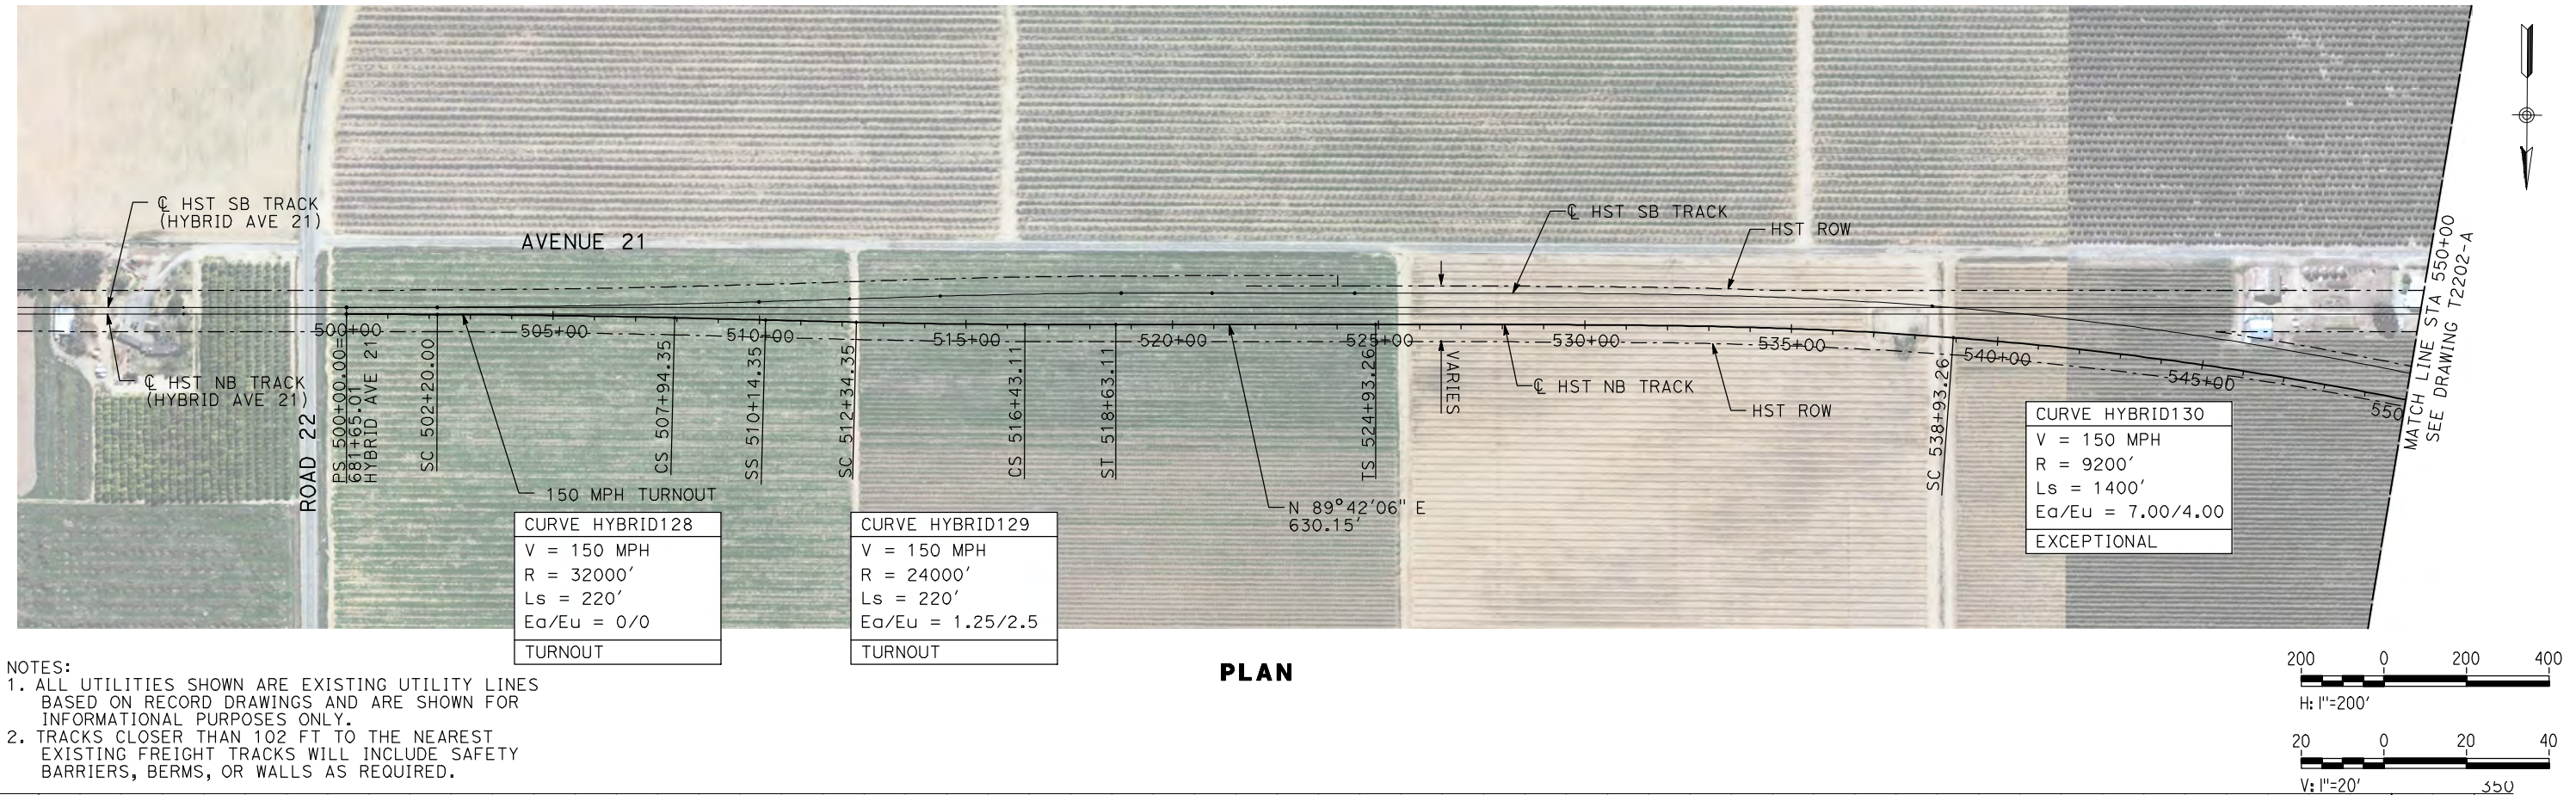
CALIFORNIA  
HIGH-SPEED RAIL AUTHORITY

CALIFORNIA HIGH-SPEED TRAIN PROJECT  
MERCED TO FRESNO  
HYBRID - SB MERCED CONNECTION  
AVENUE 21  
PLAN AND PROFILE  
STA 360+00 TO STA 377+99.09

CONTRACT NO. HSR06-007
DRAWING NO. T2200-A
SCALE AS SHOWN
SHEET NO. ### OF ###



7/21/2011 4:46:26 PM i:\chsr\60022962\task-02\_merced-fresno\cadd\civil\sheet\trackwork\deir\HYBRID 21\WF-T-2201-A.dgn machadoe



"SEE T3000-T3017 DRAWINGS FOR  
TYPICAL SECTION LIMITS AND DETAILS"

REV	DATE	BY	CHK	APP	DESCRIPTION

DESIGNED BY  
A. SHIELDS  
DRAWN BY  
H. SULLIVAN  
CHECKED BY  
A. BOONE  
IN CHARGE  
A. BOONE  
DATE  
07/20/2011

RECORD SET  
15% DESIGN  
SUBMITTAL  
  
NOT FOR  
CONSTRUCTION

**AECOM**  
Technical Services, Inc.  
2020 L Street, Suite 300  
Sacramento, CA 95811  
**CH2M HILL**

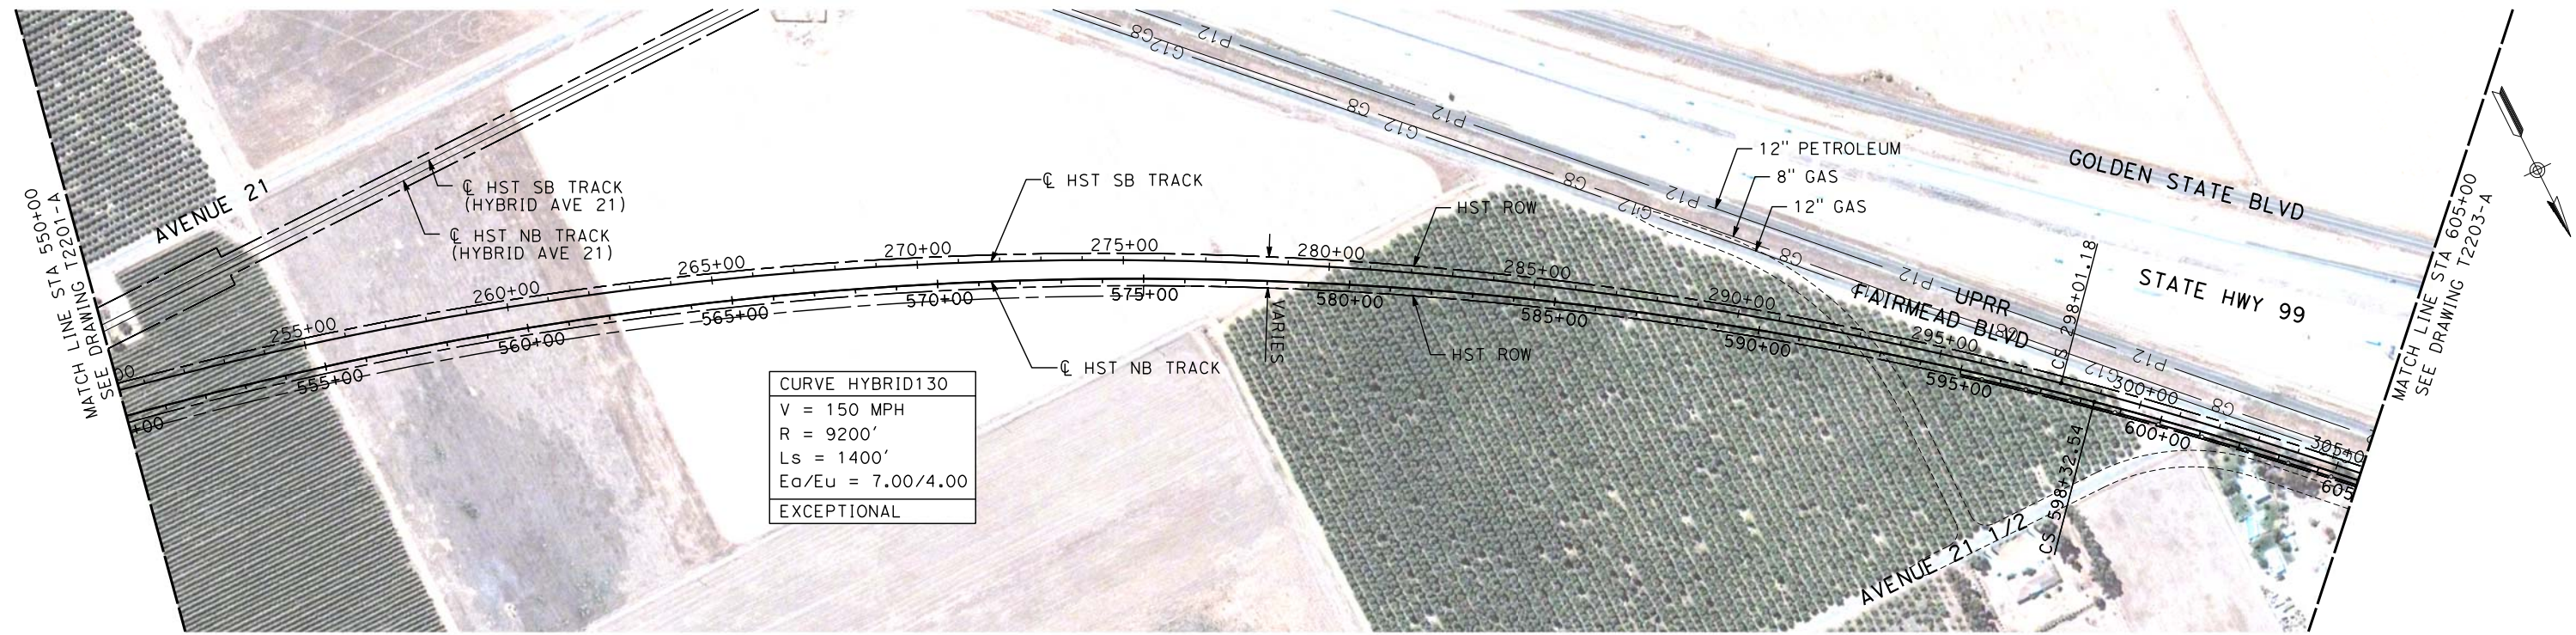


**CALIFORNIA HIGH-SPEED TRAIN PROJECT  
MERCED TO FRESNO**  
HYBRID - NB MERCED CONNECTION  
AVENUE 21  
PLAN AND PROFILE  
STA 500+00 TO STA 550+00

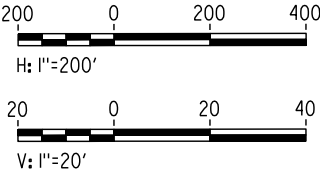
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DRAWING NO.  
T2201-A  
SCALE  
AS SHOWN  
SHEET NO.  
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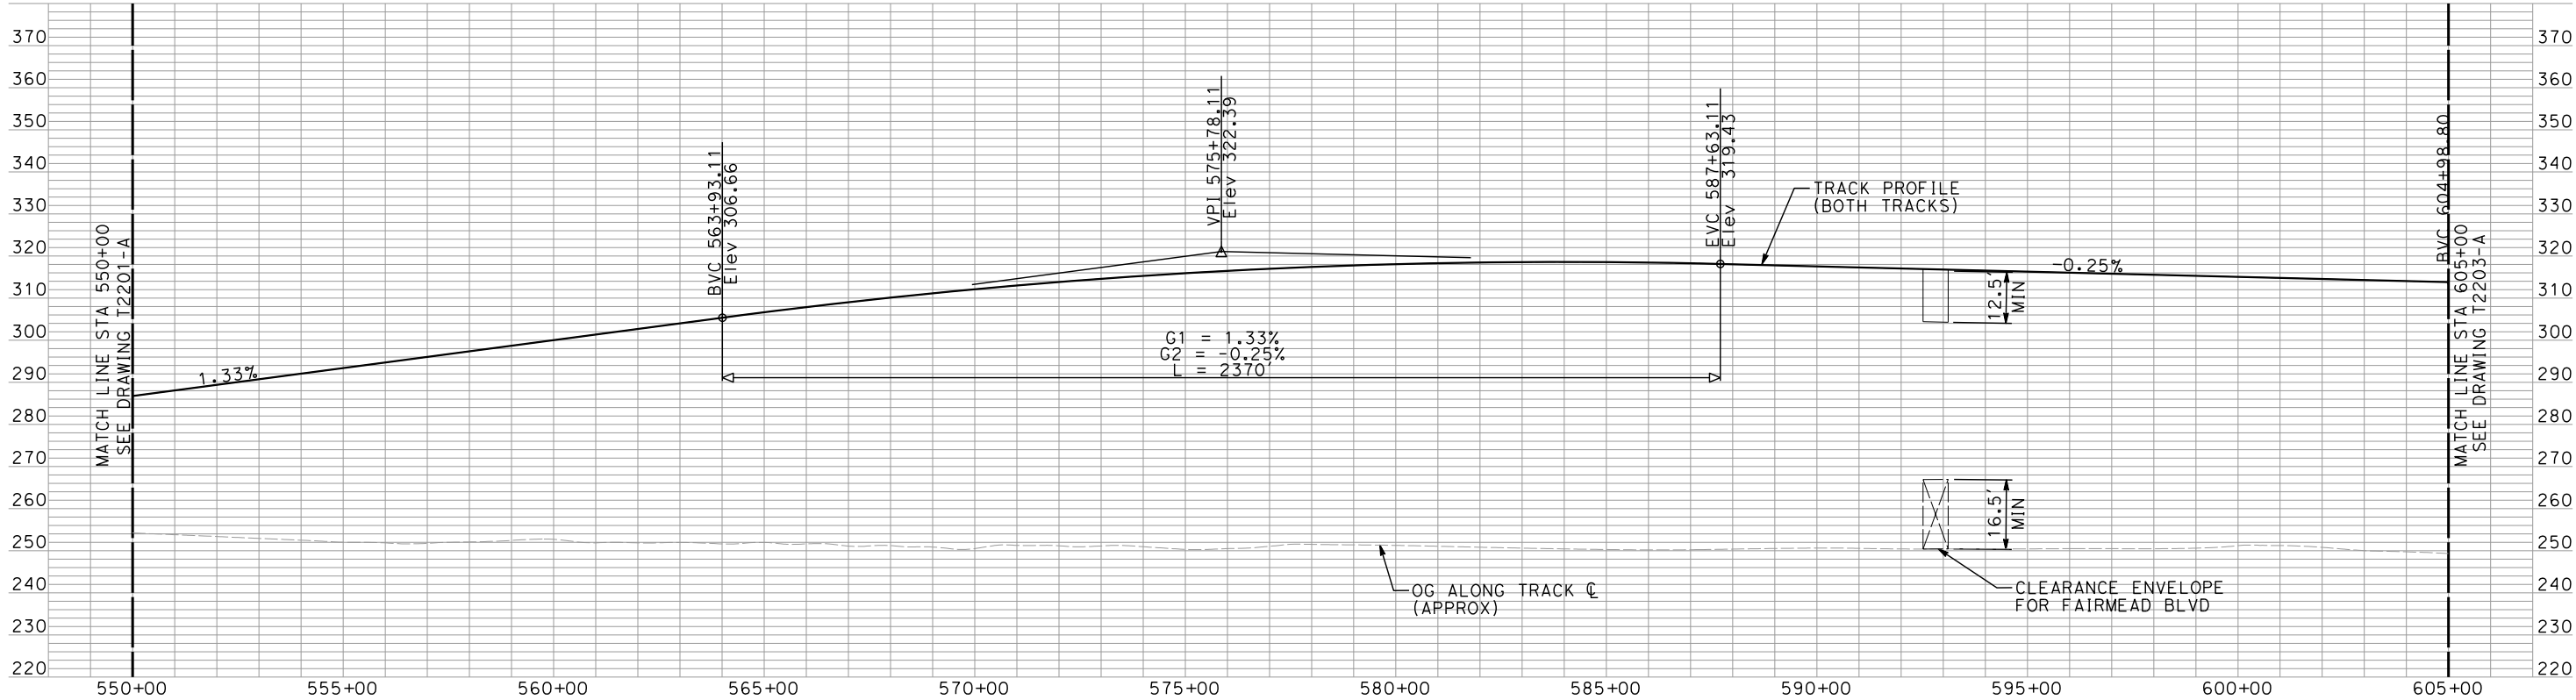
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shieldsa



PLAN



- NOTES:
1. ALL UTILITIES SHOWN ARE EXISTING UTILITY LINES BASED ON RECORD DRAWINGS AND ARE SHOWN FOR INFORMATIONAL PURPOSES ONLY.
  2. TRACKS CLOSER THAN 102 FT TO THE NEAREST EXISTING FREIGHT TRACKS WILL INCLUDE SAFETY BARRIERS, BERMS, OR WALLS AS REQUIRED.



PROFILE

"SEE T3000-T3017 DRAWINGS FOR  
TYPICAL SECTION LIMITS AND DETAILS"

REV	DATE	BY	CHK	APP	DESCRIPTION

DESIGNED BY A. SHIELDS
DRAWN BY H. SULLIVAN
CHECKED BY A. BOONE
IN CHARGE A. BOONE
DATE 07/27/2011

RECORD SET  
15% DESIGN  
SUBMITTAL

NOT FOR  
CONSTRUCTION

**AECOM**  
Technical Services, Inc.  
2020 L Street, Suite 300  
Sacramento, CA 95811  
**CH2MHILL**

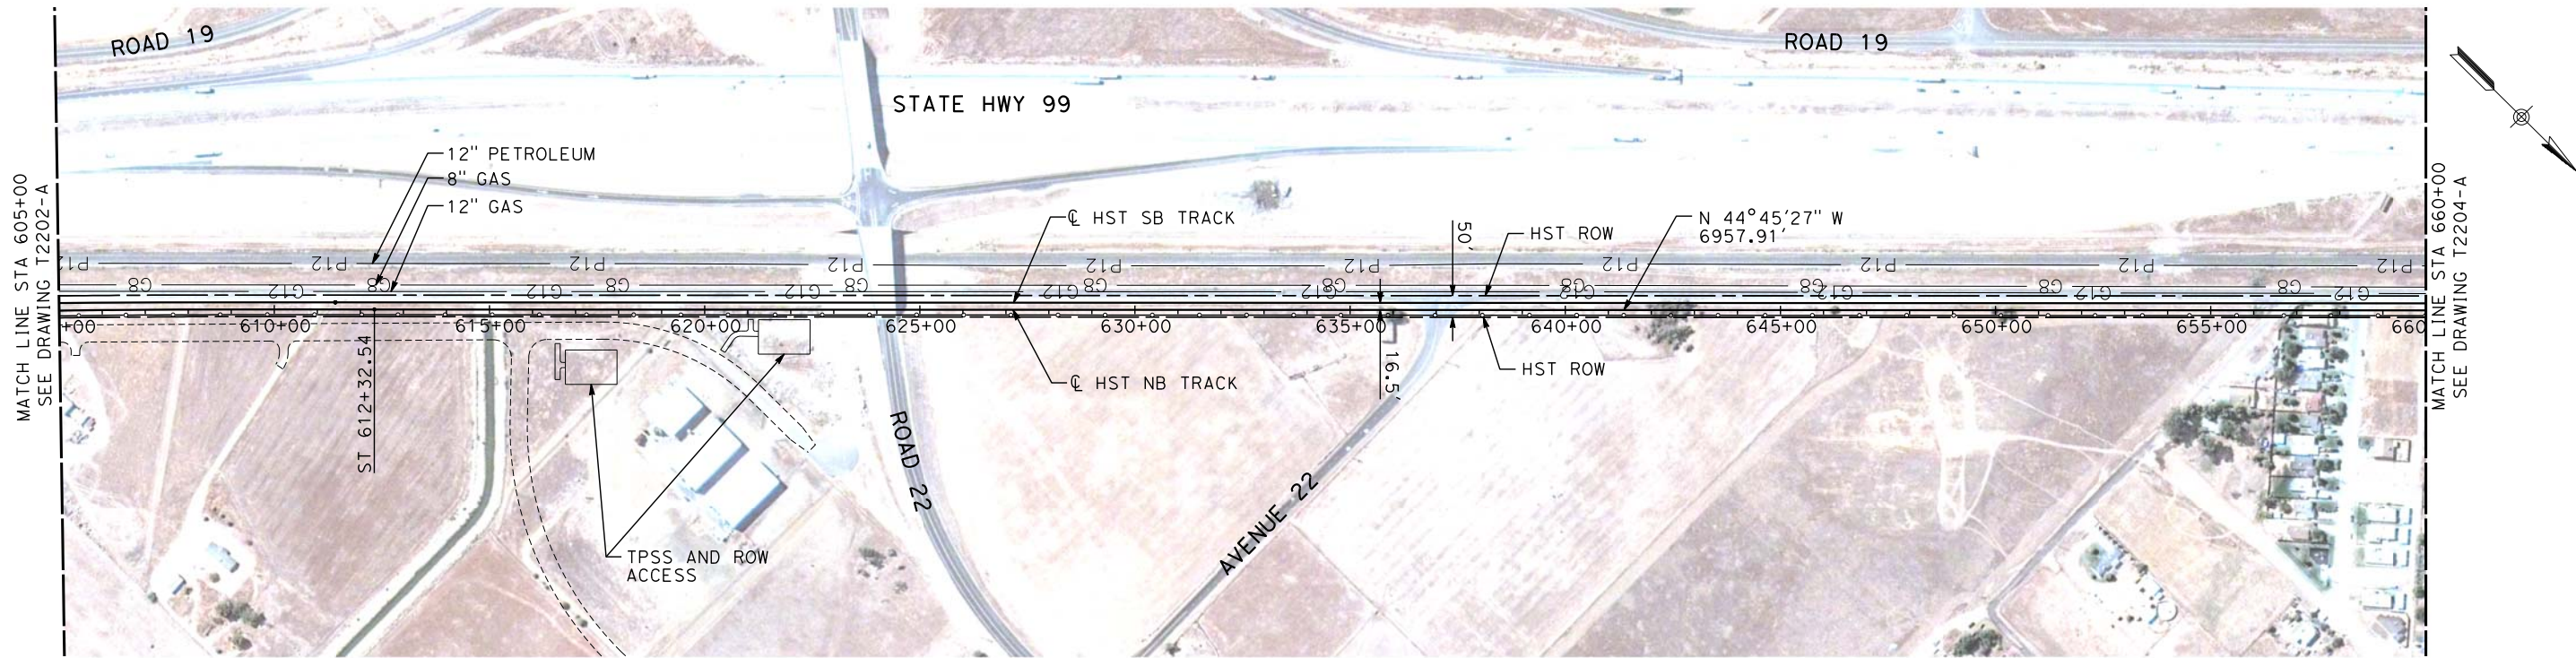


**CALIFORNIA HIGH-SPEED TRAIN PROJECT  
MERCED TO FRESNO**  
HYBRID - NB MERCED CONNECTION  
AVENUE 21  
PLAN AND PROFILE  
STA 550+00 TO STA 605+00

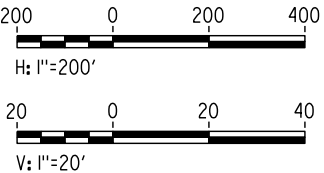
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DRAWING NO. T2202-A
SCALE AS SHOWN
SHEET NO. ### OF ###



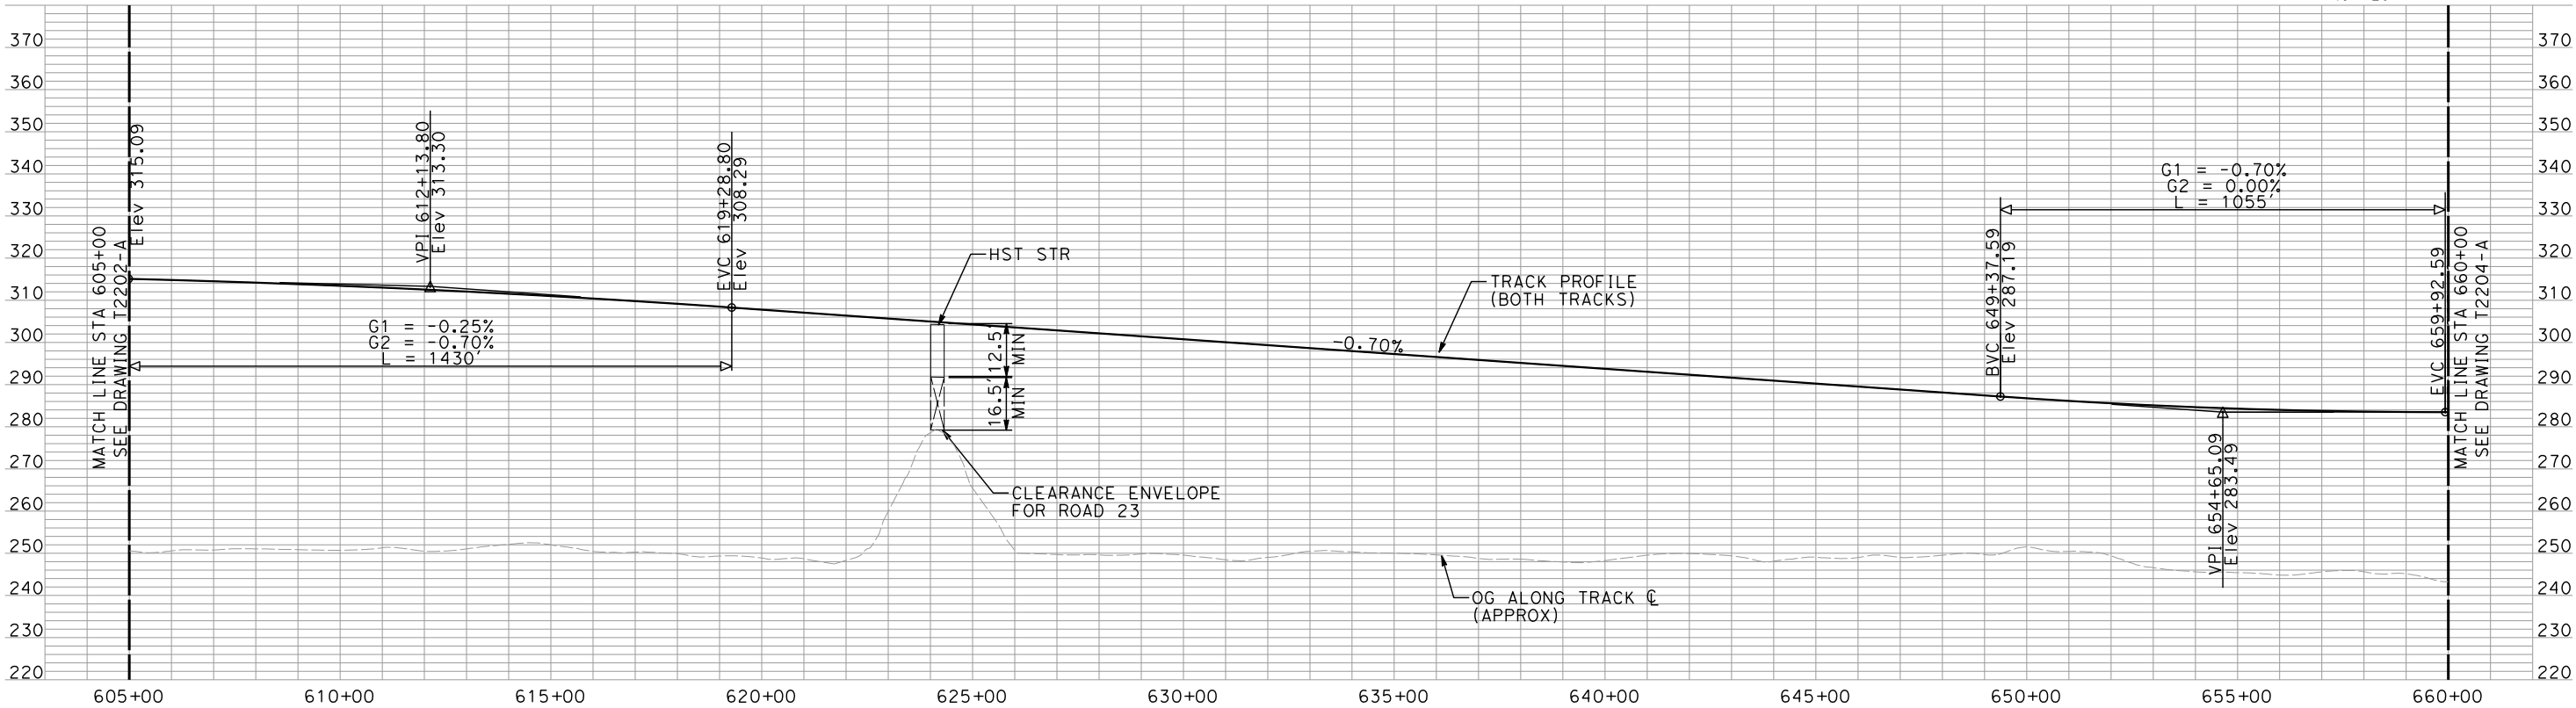
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shieldsa



PLAN



- NOTES:
1. ALL UTILITIES SHOWN ARE EXISTING UTILITY LINES BASED ON RECORD DRAWINGS AND ARE SHOWN FOR INFORMATIONAL PURPOSES ONLY.
  2. TRACKS CLOSER THAN 102 FT TO THE NEAREST EXISTING FREIGHT TRACKS WILL INCLUDE SAFETY BARRIERS, BERMS, OR WALLS AS REQUIRED.



PROFILE

"SEE T3000-T3017 DRAWINGS FOR  
TYPICAL SECTION LIMITS AND DETAILS"

REV	DATE	BY	CHK	APP	DESCRIPTION

DESIGNED BY A. SHIELDS
DRAWN BY H. SULLIVAN
CHECKED BY A. BOONE
IN CHARGE A. BOONE
DATE 07/27/2011

RECORD SET  
15% DESIGN  
SUBMITTAL

NOT FOR  
CONSTRUCTION

**AECOM**  
Technical Services, Inc.  
2020 L Street, Suite 300  
Sacramento, CA 95811  
**CH2MHILL**



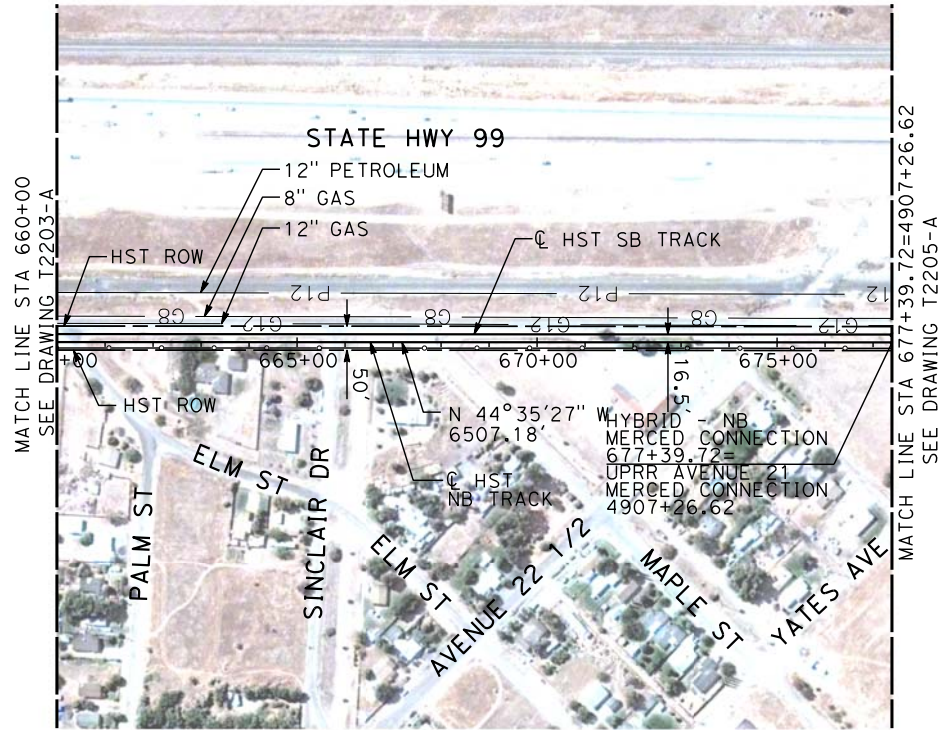
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HIGH-SPEED RAIL AUTHORITY

**CALIFORNIA HIGH-SPEED TRAIN PROJECT**  
**MERCED TO FRESNO**  
HYBRID - NB MERCED CONNECTION  
AVENUE 21  
PLAN AND PROFILE  
STA 605+00 TO STA 660+00

CONTRACT NO. HSR06-007
DRAWING NO. T2203-A
SCALE AS SHOWN
SHEET NO. ### OF ###

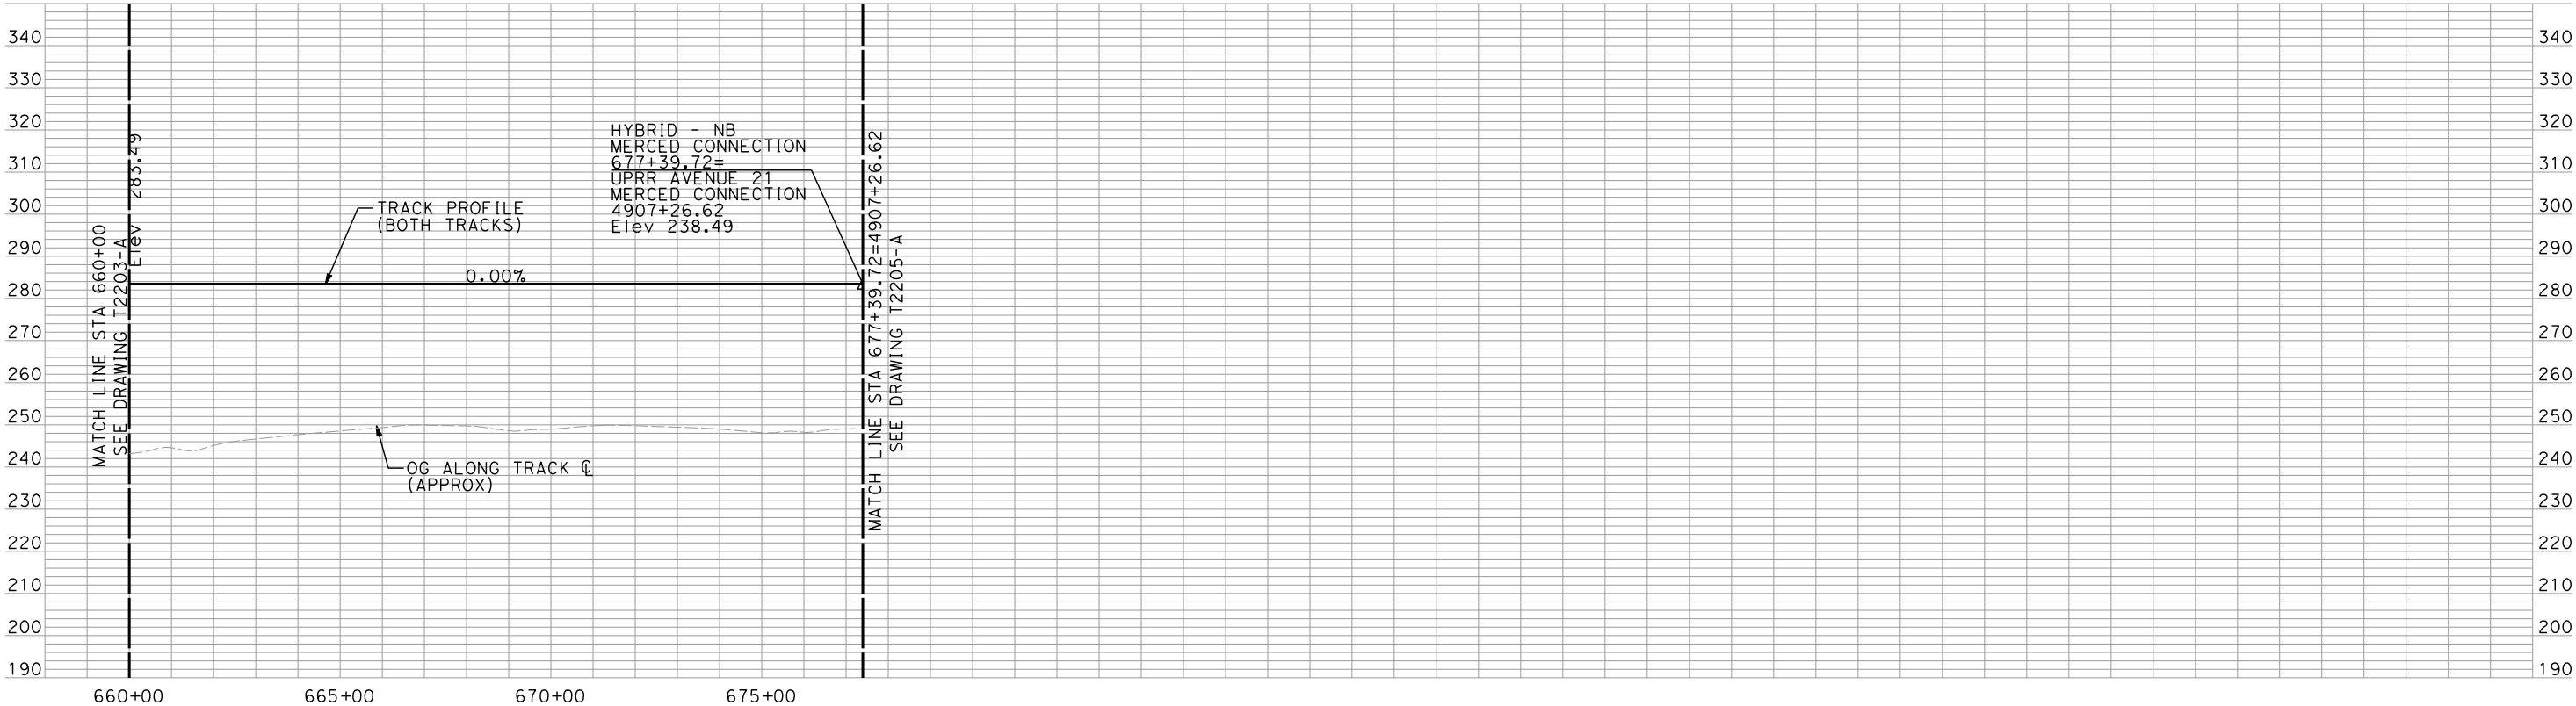
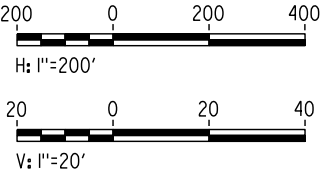


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shieldsa



- NOTES:
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  2. TRACKS CLOSER THAN 102 FT TO THE NEAREST EXISTING FREIGHT TRACKS WILL INCLUDE SAFETY BARRIERS, BERMS, OR WALLS AS REQUIRED.

PLAN



PROFILE

"SEE T3000-T3017 DRAWINGS FOR  
TYPICAL SECTION LIMITS AND DETAILS"

REV	DATE	BY	CHK	APP	DESCRIPTION

DESIGNED BY A. SHIELDS
DRAWN BY H. SULLIVAN
CHECKED BY A. BOONE
IN CHARGE A. BOONE
DATE 07/27/2011

RECORD SET  
15% DESIGN  
SUBMITTAL

NOT FOR  
CONSTRUCTION



CALIFORNIA  
HIGH-SPEED RAIL AUTHORITY

CALIFORNIA HIGH-SPEED TRAIN PROJECT  
MERCED TO FRESNO  
HYBRID - NB MERCED CONNECTION  
AVENUE 21  
PLAN AND PROFILE  
STA 660+00 TO STA 677+39.72

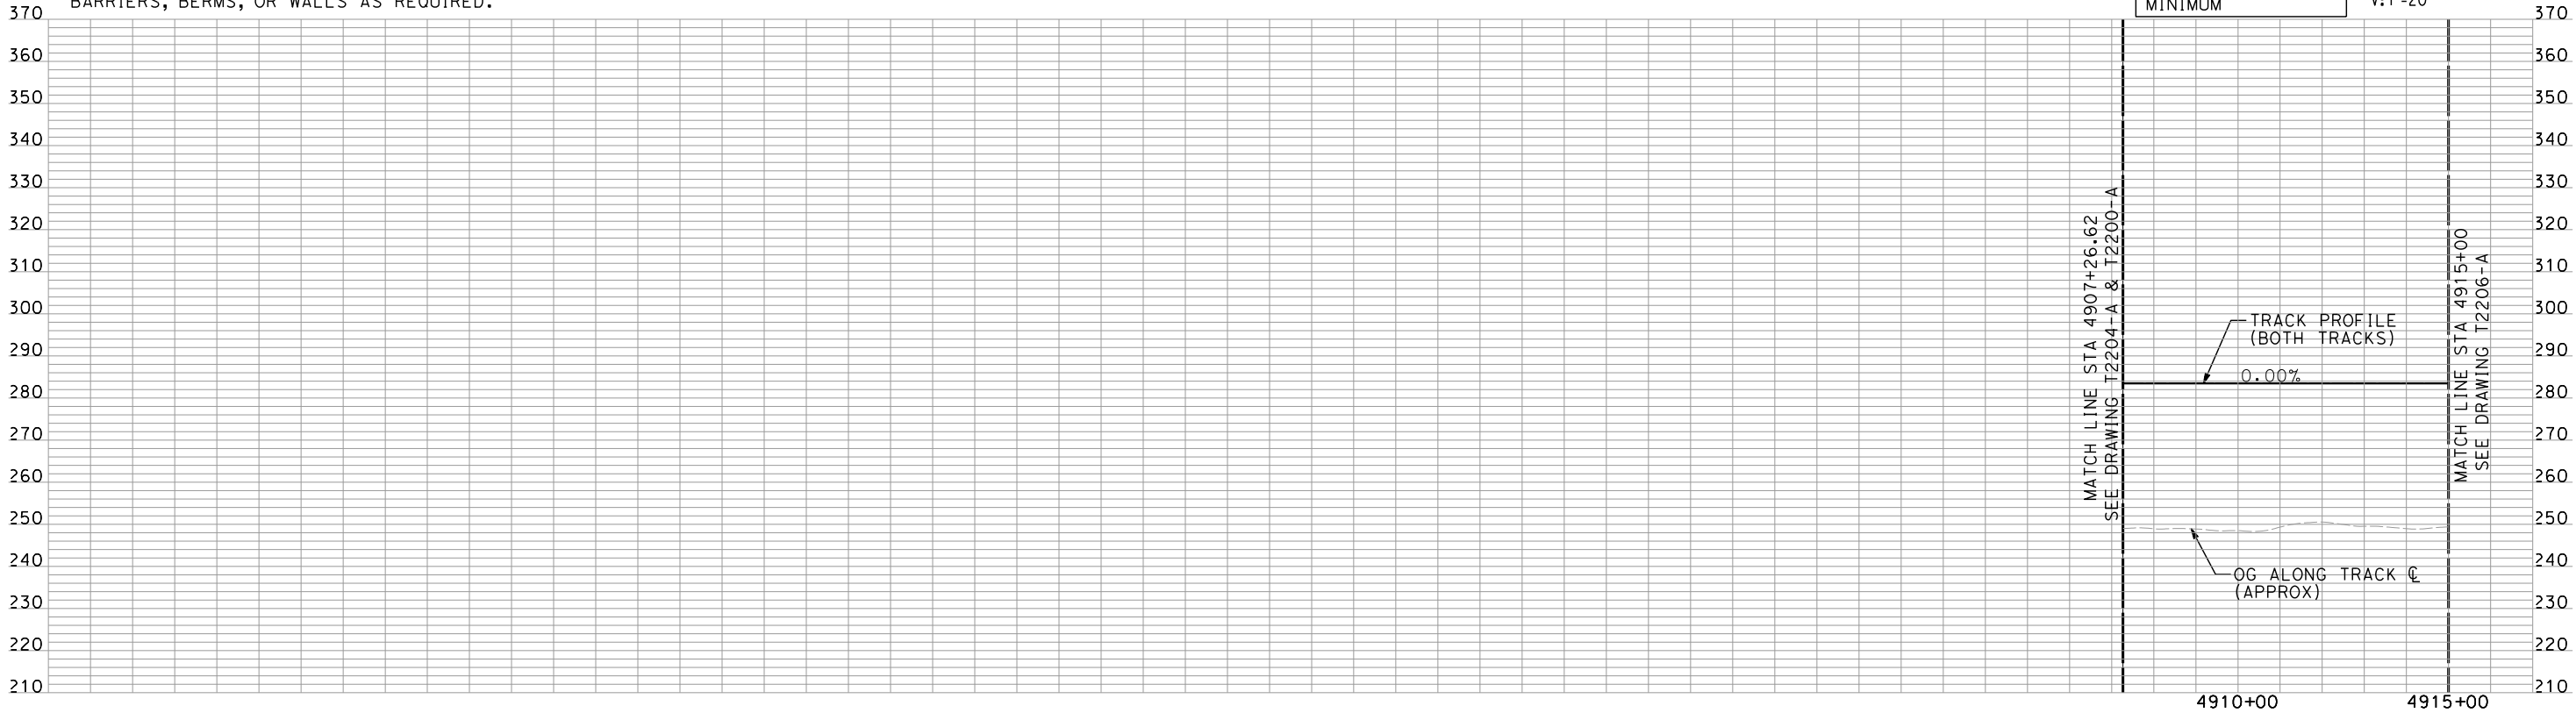
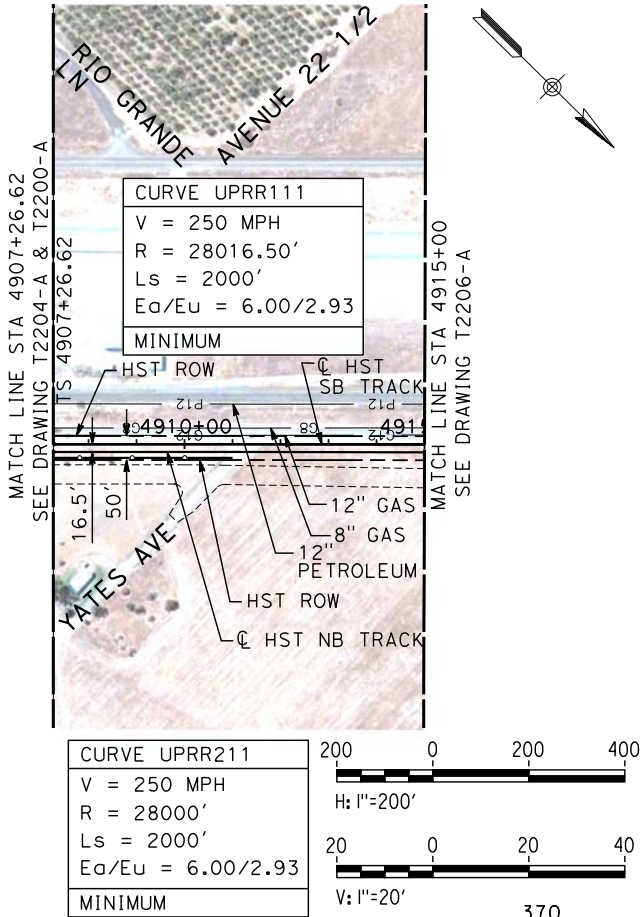
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DRAWING NO. T2204-A
SCALE AS SHOWN
SHEET NO. ### OF ###



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shieldsa

- NOTES:
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  2. TRACKS CLOSER THAN 102 FT TO THE NEAREST EXISTING FREIGHT TRACKS WILL INCLUDE SAFETY BARRIERS, BERMS, OR WALLS AS REQUIRED.

PLAN



PROFILE

"SEE T3000-T3017 DRAWINGS FOR  
TYPICAL SECTION LIMITS AND DETAILS"

REV	DATE	BY	CHK	APP	DESCRIPTION

DESIGNED BY A. SHIELDS
DRAWN BY H. SULLIVAN
CHECKED BY A. BOONE
IN CHARGE A. BOONE
DATE 07/27/2011

RECORD SET  
15% DESIGN  
SUBMITTAL

NOT FOR  
CONSTRUCTION

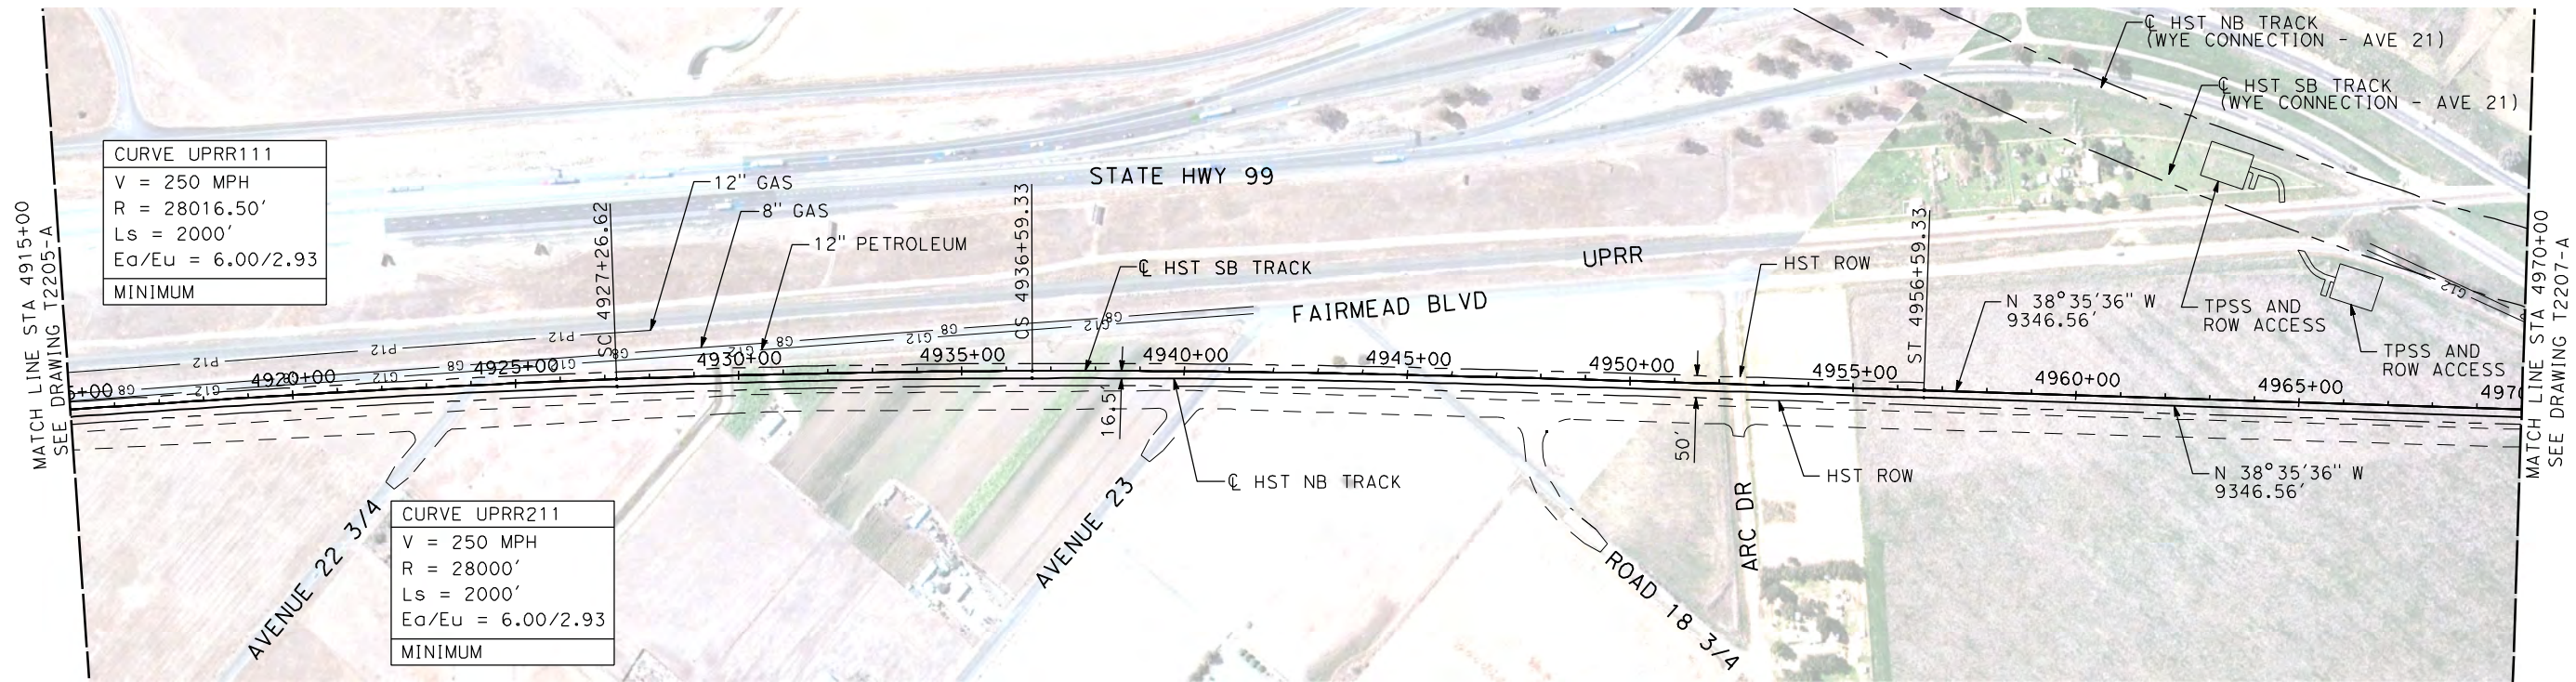


CALIFORNIA HIGH-SPEED TRAIN PROJECT  
MERCED TO FRESNO  
UPRR/SR 99 MERCED CONNECTION  
AVENUE 21  
PLAN AND PROFILE  
STA 4907+26.62 TO STA 4915+00

CONTRACT NO. HSR06-007
DRAWING NO. T2205-A
SCALE AS SHOWN
SHEET NO. ### OF ###



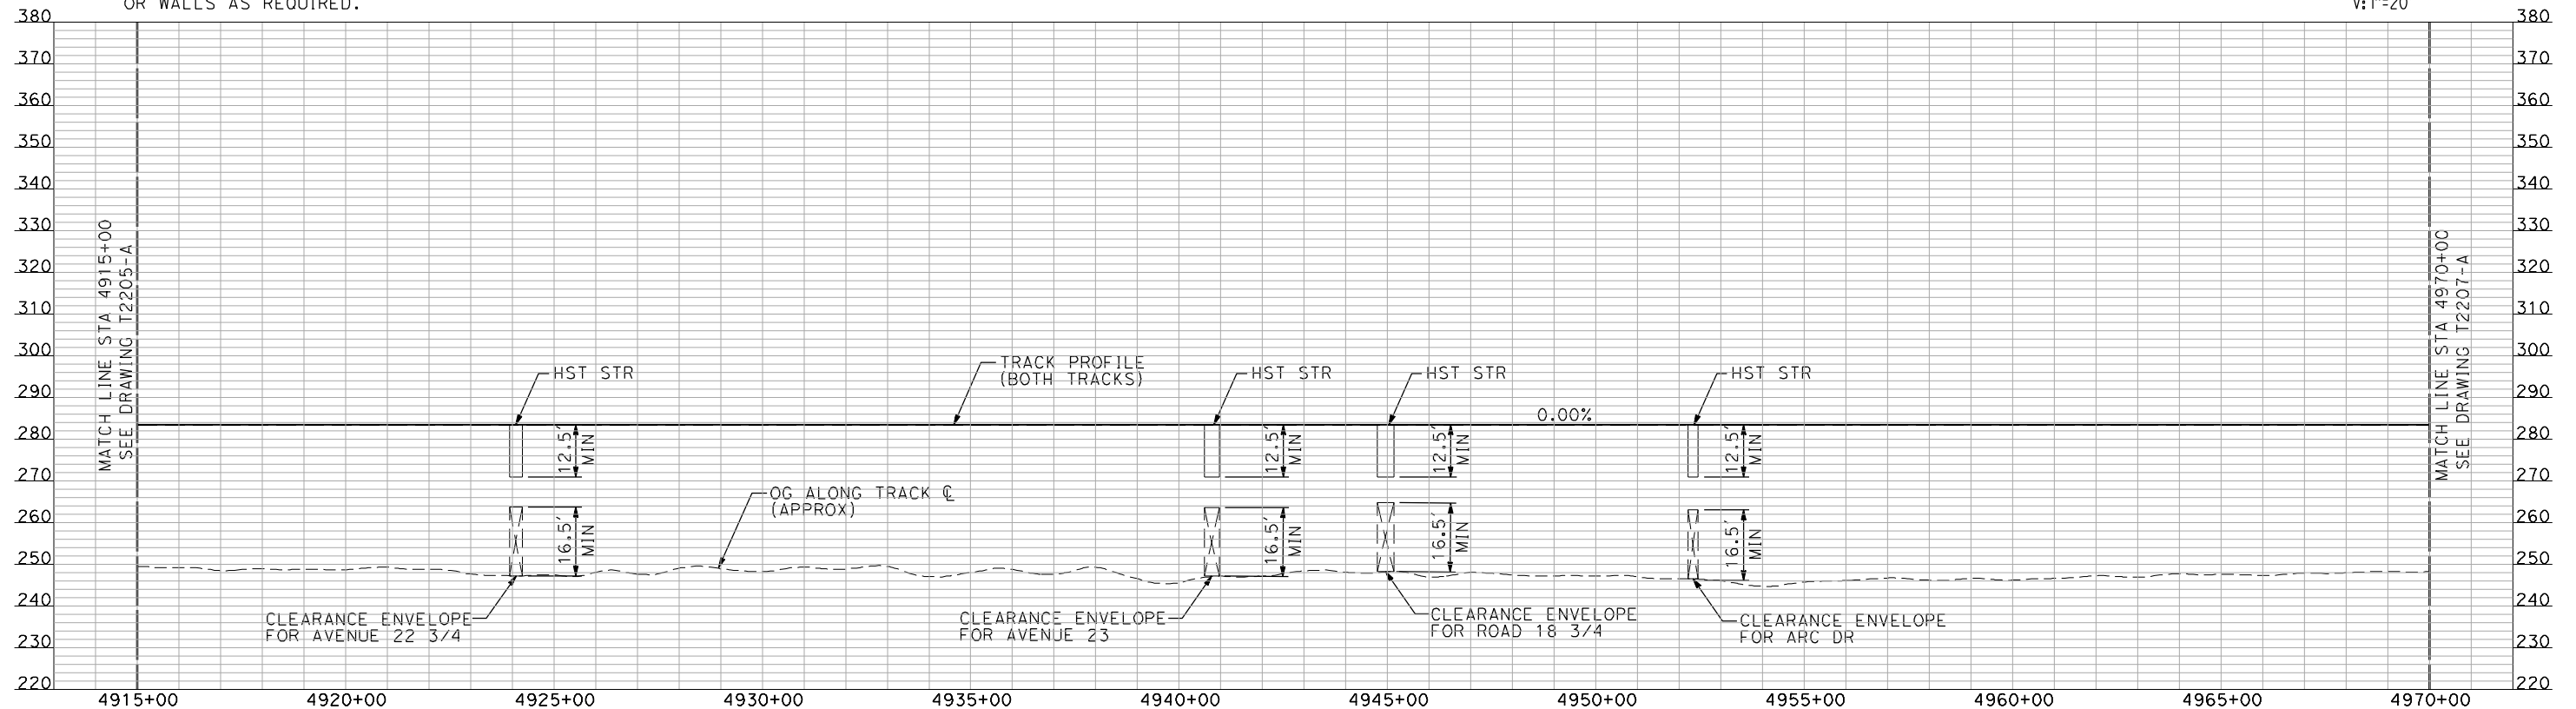
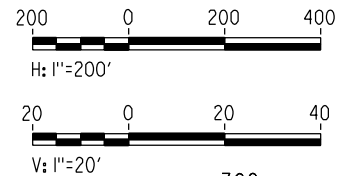
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NOTES:

1. ALL UTILITIES SHOWN ARE EXISTING UTILITY LINES BASED ON RECORD DRAWINGS AND ARE SHOWN FOR INFORMATIONAL PURPOSES ONLY.
2. TRACKS CLOSER THAN 102 FT TO THE NEAREST EXISTING FREIGHT TRACKS WILL INCLUDE SAFETY BARRIERS, BERMS, OR WALLS AS REQUIRED.

PLAN



PROFILE

"SEE T3000-T3017 DRAWINGS FOR  
TYPICAL SECTION LIMITS AND DETAILS"

REV	DATE	BY	CHK	APP	DESCRIPTION

DESIGNED BY A. SHIELDS
DRAWN BY H. SULLIVAN
CHECKED BY A. BOONE
IN CHARGE A. BOONE
DATE 07/20/2011

RECORD SET  
15% DESIGN  
SUBMITTAL

NOT FOR  
CONSTRUCTION



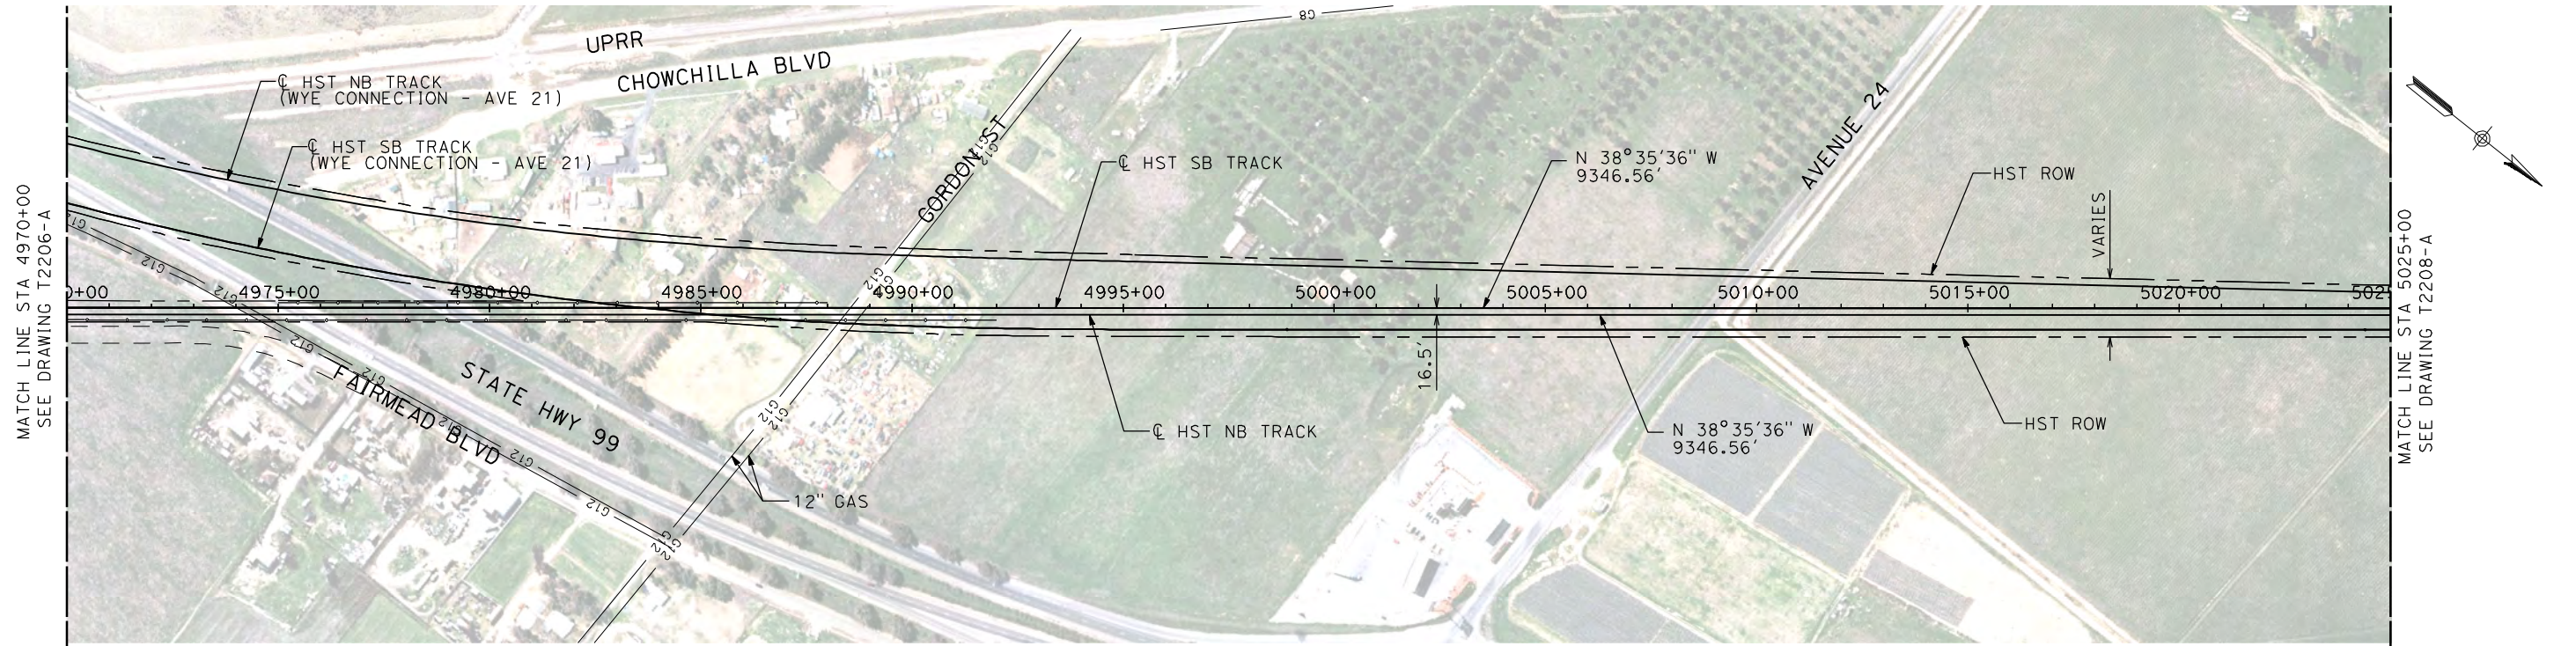
CALIFORNIA HIGH-SPEED TRAIN PROJECT  
MERCED TO FRESNO

UPRR/SR 99 MERCED CONNECTION  
AVENUE 21  
PLAN AND PROFILE  
STA 4915+00 TO STA 4970+00

CONTRACT NO. HSR06-007
DRAWING NO. T2206-A
SCALE AS SHOWN
SHEET NO. ### OF ###



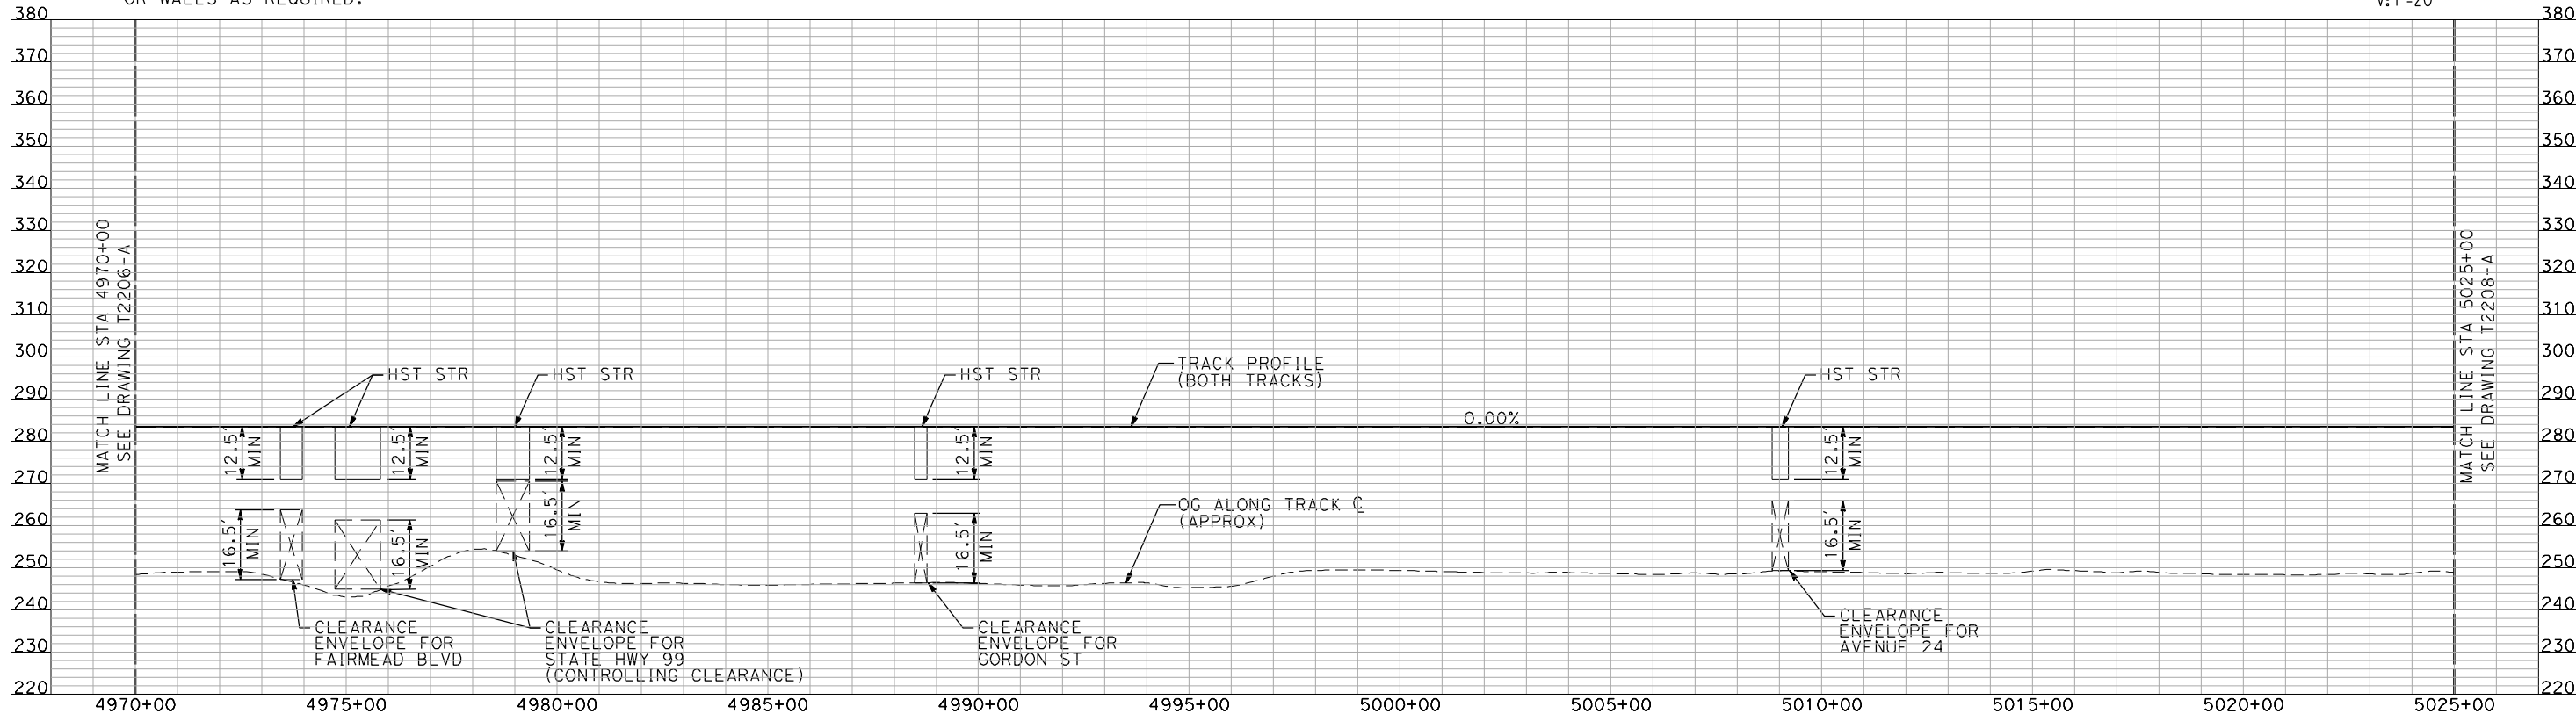
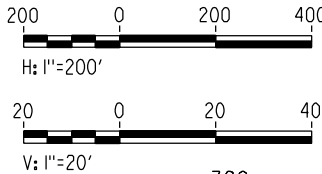
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NOTES:

1. ALL UTILITIES SHOWN ARE EXISTING UTILITY LINES BASED ON RECORD DRAWINGS AND ARE SHOWN FOR INFORMATIONAL PURPOSES ONLY.
2. TRACKS CLOSER THAN 102 FT TO THE NEAREST EXISTING FREIGHT TRACKS WILL INCLUDE SAFETY BARRIERS, BERMS, OR WALLS AS REQUIRED.

PLAN



PROFILE

"SEE T3000-T3017 DRAWINGS FOR  
TYPICAL SECTION LIMITS AND DETAILS"

REV	DATE	BY	CHK	APP	DESCRIPTION

DESIGNED BY  
A. SHIELDS  
DRAWN BY  
H. SULLIVAN  
CHECKED BY  
A. BOONE  
IN CHARGE  
A. BOONE  
DATE  
07/20/2011

RECORD SET  
15% DESIGN  
SUBMITTAL

NOT FOR  
CONSTRUCTION

**AECOM**  
Technical Services, Inc.  
2020 L Street, Suite 300  
Sacramento, CA 95811  
**CH2M HILL**



**CALIFORNIA HIGH-SPEED TRAIN PROJECT  
MERCED TO FRESNO**

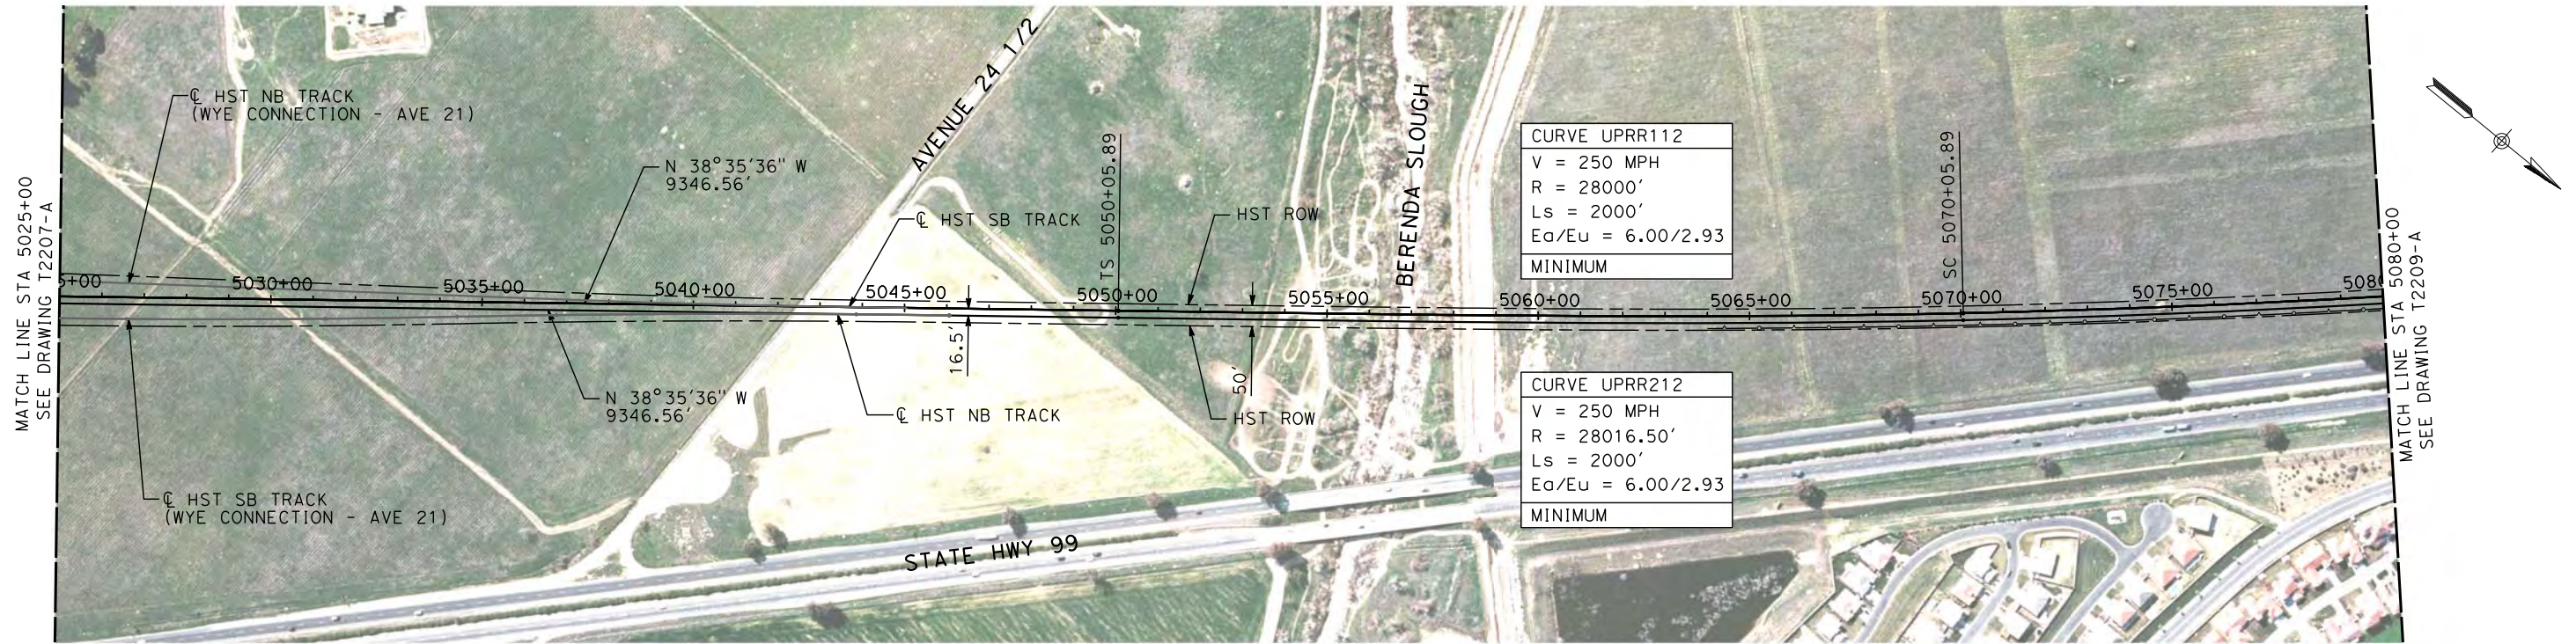
UPRR/SR 99 MERCED CONNECTION

PLAN AND PROFILE  
STA 4970+00 TO STA 5025+00

CONTRACT NO.  
HSR06-007  
DRAWING NO.  
T2207-A  
SCALE  
AS SHOWN  
SHEET NO.  
### OF ###



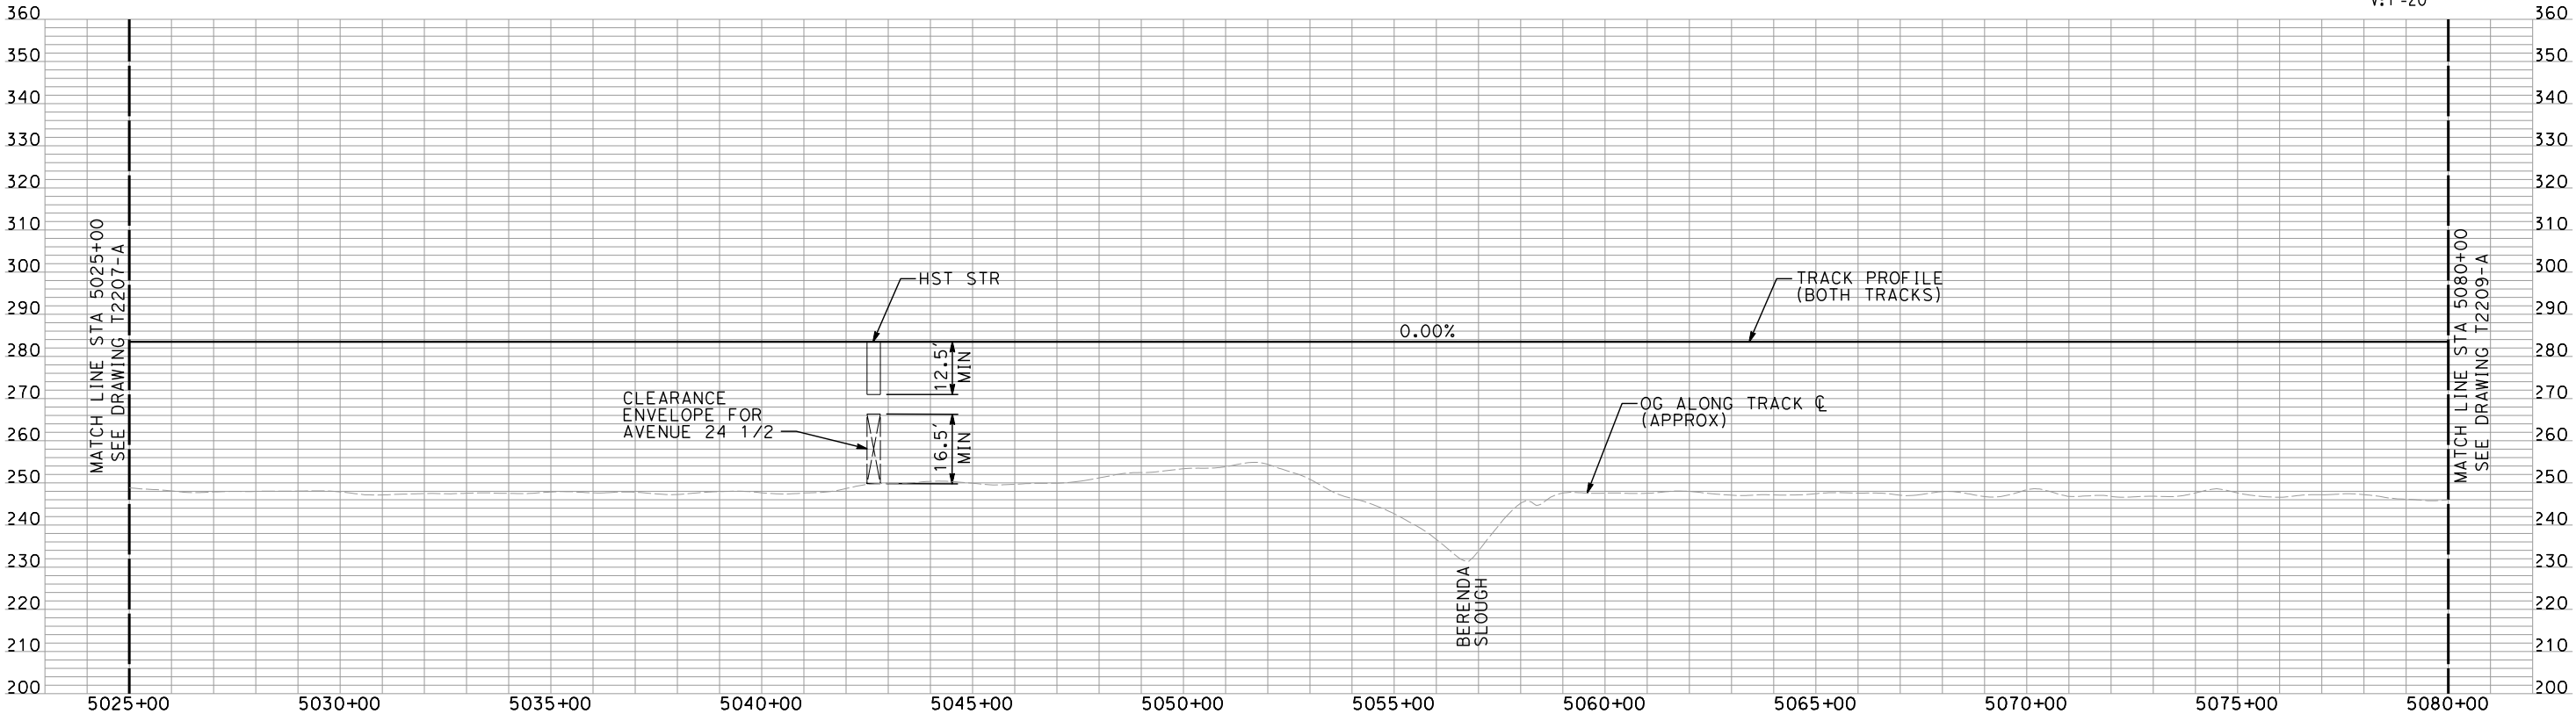
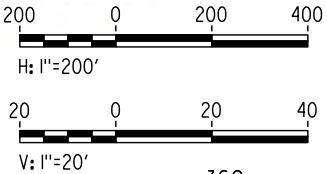
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NOTES:

1. ALL UTILITIES SHOWN ARE EXISTING UTILITY LINES BASED ON RECORD DRAWINGS AND ARE SHOWN FOR INFORMATIONAL PURPOSES ONLY.
2. TRACKS CLOSER THAN 102 FT TO THE NEAREST EXISTING FREIGHT TRACKS WILL INCLUDE SAFETY BARRIERS, BERMS, OR WALLS AS REQUIRED.

PLAN



PROFILE

"SEE T3000-T3017 DRAWINGS FOR  
TYPICAL SECTION LIMITS AND DETAILS"

REV	DATE	BY	CHK	APP	DESCRIPTION
1	02/17/12	AS			NOISE BARRIER LIMITS

DESIGNED BY A. SHIELDS
DRAWN BY H. SULLIVAN
CHECKED BY A. BOONE
IN CHARGE A. BOONE
DATE 07/27/2011

RECORD SET  
15% DESIGN  
SUBMITTAL

NOT FOR  
CONSTRUCTION



CALIFORNIA HIGH-SPEED TRAIN PROJECT  
MERCED TO FRESNO

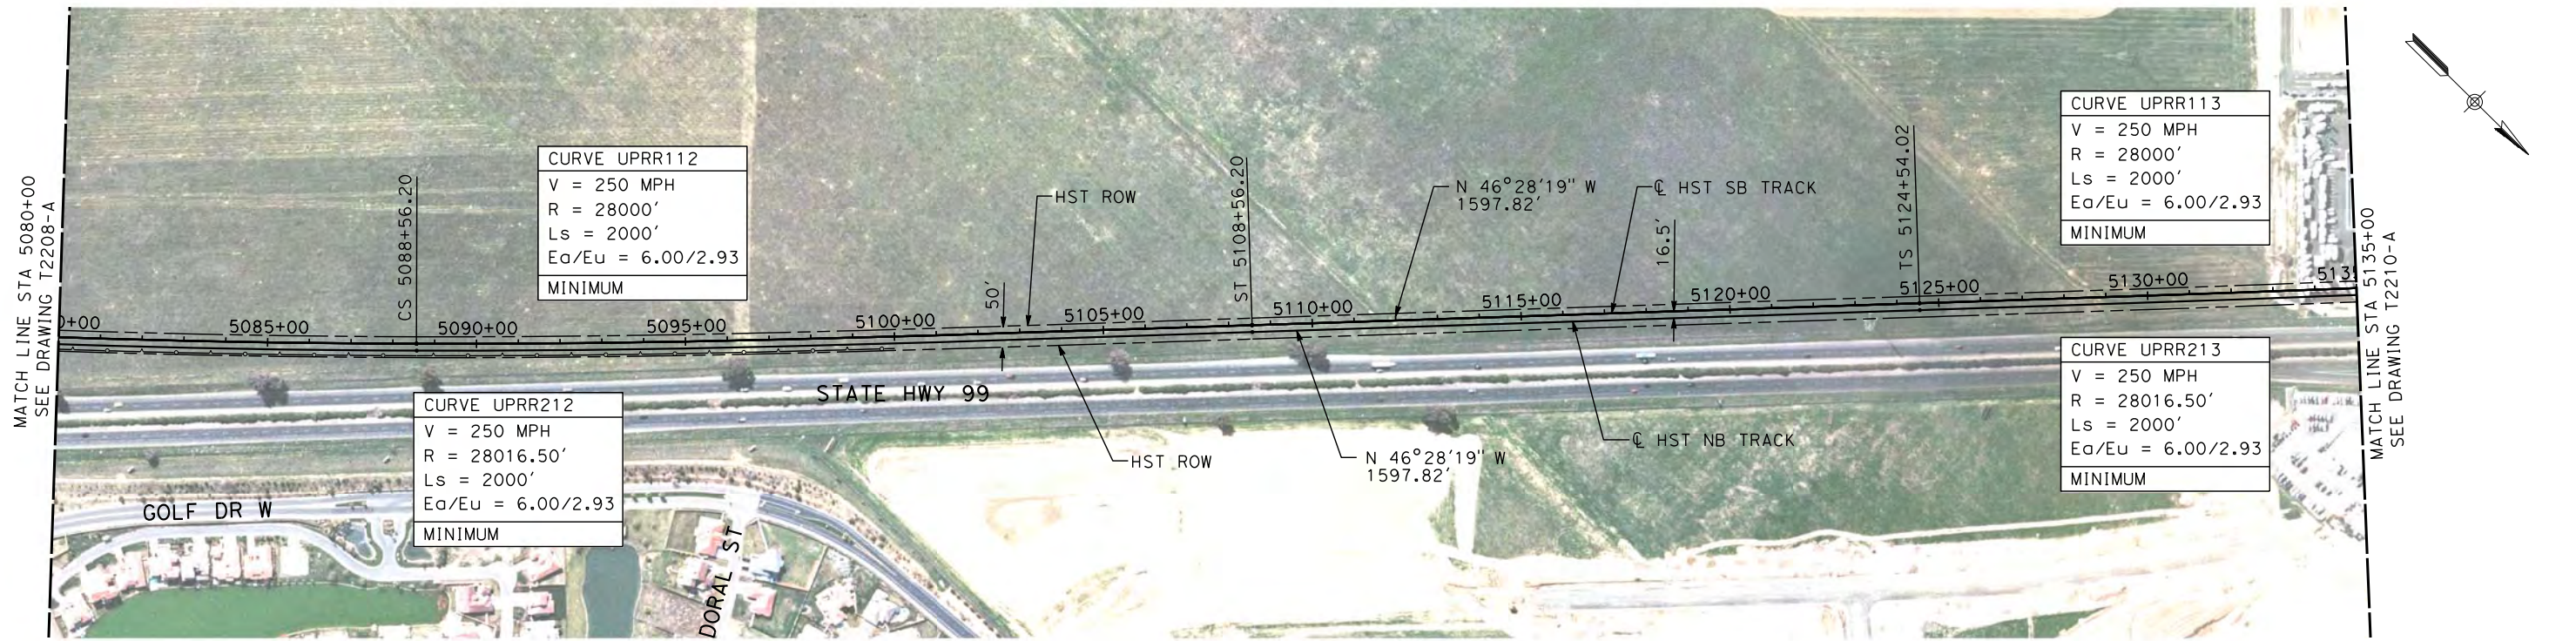
UPRR/SR 99 MERCED CONNECTION

PLAN AND PROFILE  
STA 5025+00 TO STA 5080+00

CONTRACT NO. HSR06-007
DRAWING NO. T2208-A
SCALE AS SHOWN
SHEET NO. ### OF ###

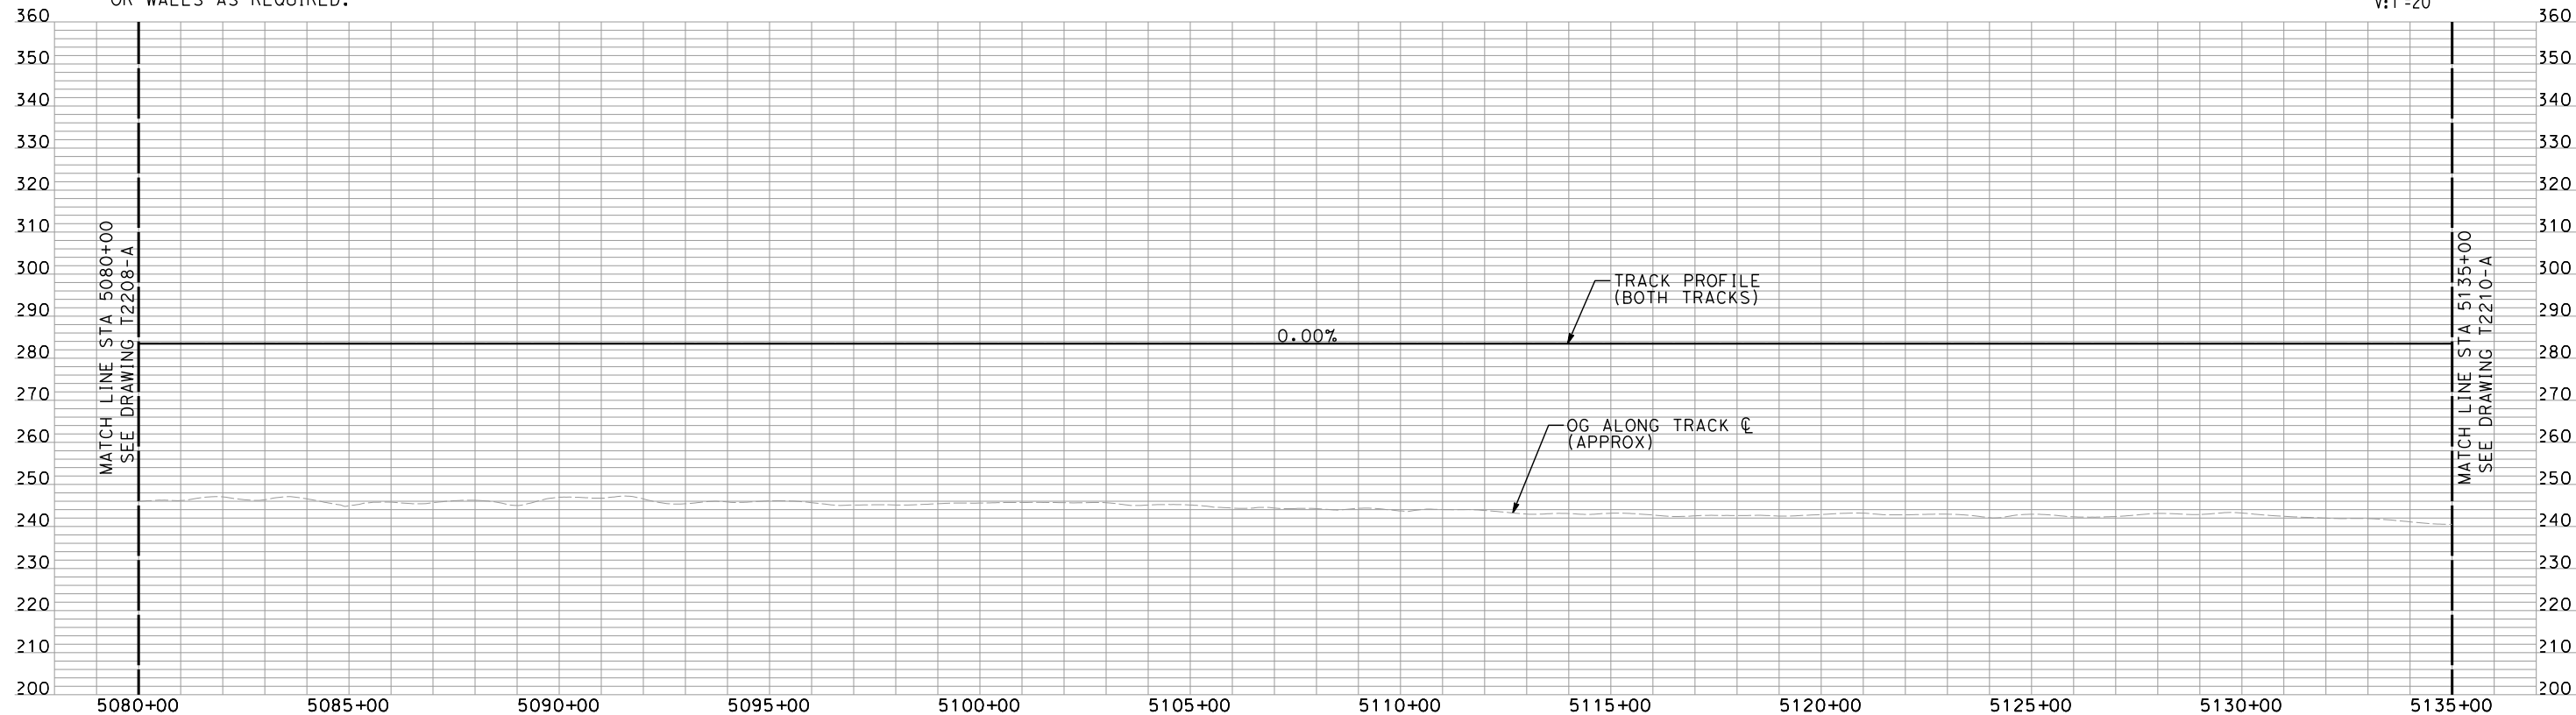
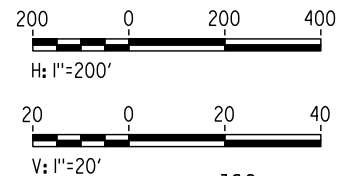


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NOTES:

1. ALL UTILITIES SHOWN ARE EXISTING UTILITY LINES BASED ON RECORD DRAWINGS AND ARE SHOWN FOR INFORMATIONAL PURPOSES ONLY.
2. TRACKS CLOSER THAN 102 FT TO THE NEAREST EXISTING FREIGHT TRACKS WILL INCLUDE SAFETY BARRIERS, BERMS, OR WALLS AS REQUIRED.



"SEE T3000-T3017 DRAWINGS FOR  
TYPICAL SECTION LIMITS AND DETAILS"

REV	DATE	BY	CHK	APP	DESCRIPTION
1	02/17/12	AS			NOISE BARRIER LIMITS

DESIGNED BY  
A. SHIELDS  
DRAWN BY  
H. SULLIVAN  
CHECKED BY  
A. BOONE  
IN CHARGE  
A. BOONE  
DATE  
07/27/2011

RECORD SET  
15% DESIGN  
SUBMITTAL  
  
NOT FOR  
CONSTRUCTION

**AECOM**  
Technical Services, Inc.  
2020 L Street, Suite 300  
Sacramento, CA 95811  
**CH2MHILL**

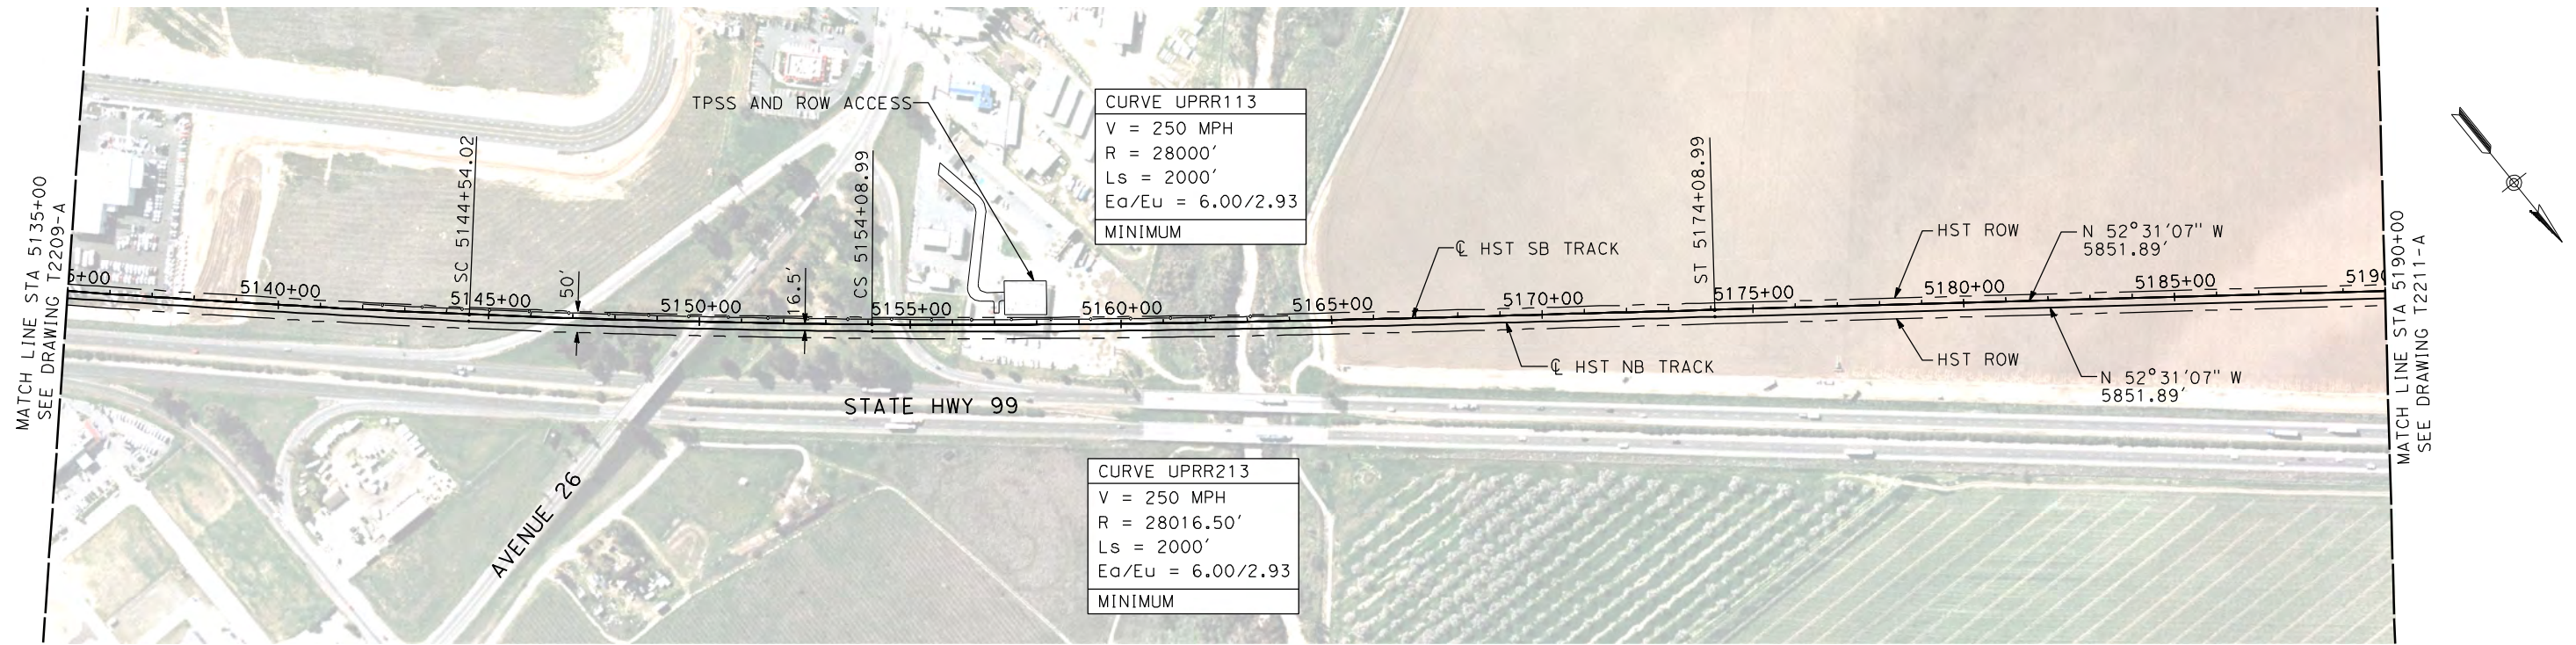


**CALIFORNIA HIGH-SPEED TRAIN PROJECT**  
**MERCED TO FRESNO**  
UPRR/SR 99 MERCED CONNECTION  
  
PLAN AND PROFILE  
STA 5080+00 TO STA 5135+00

CONTRACT NO.  
HSR06-007  
DRAWING NO.  
T2209-A  
SCALE  
AS SHOWN  
SHEET NO.  
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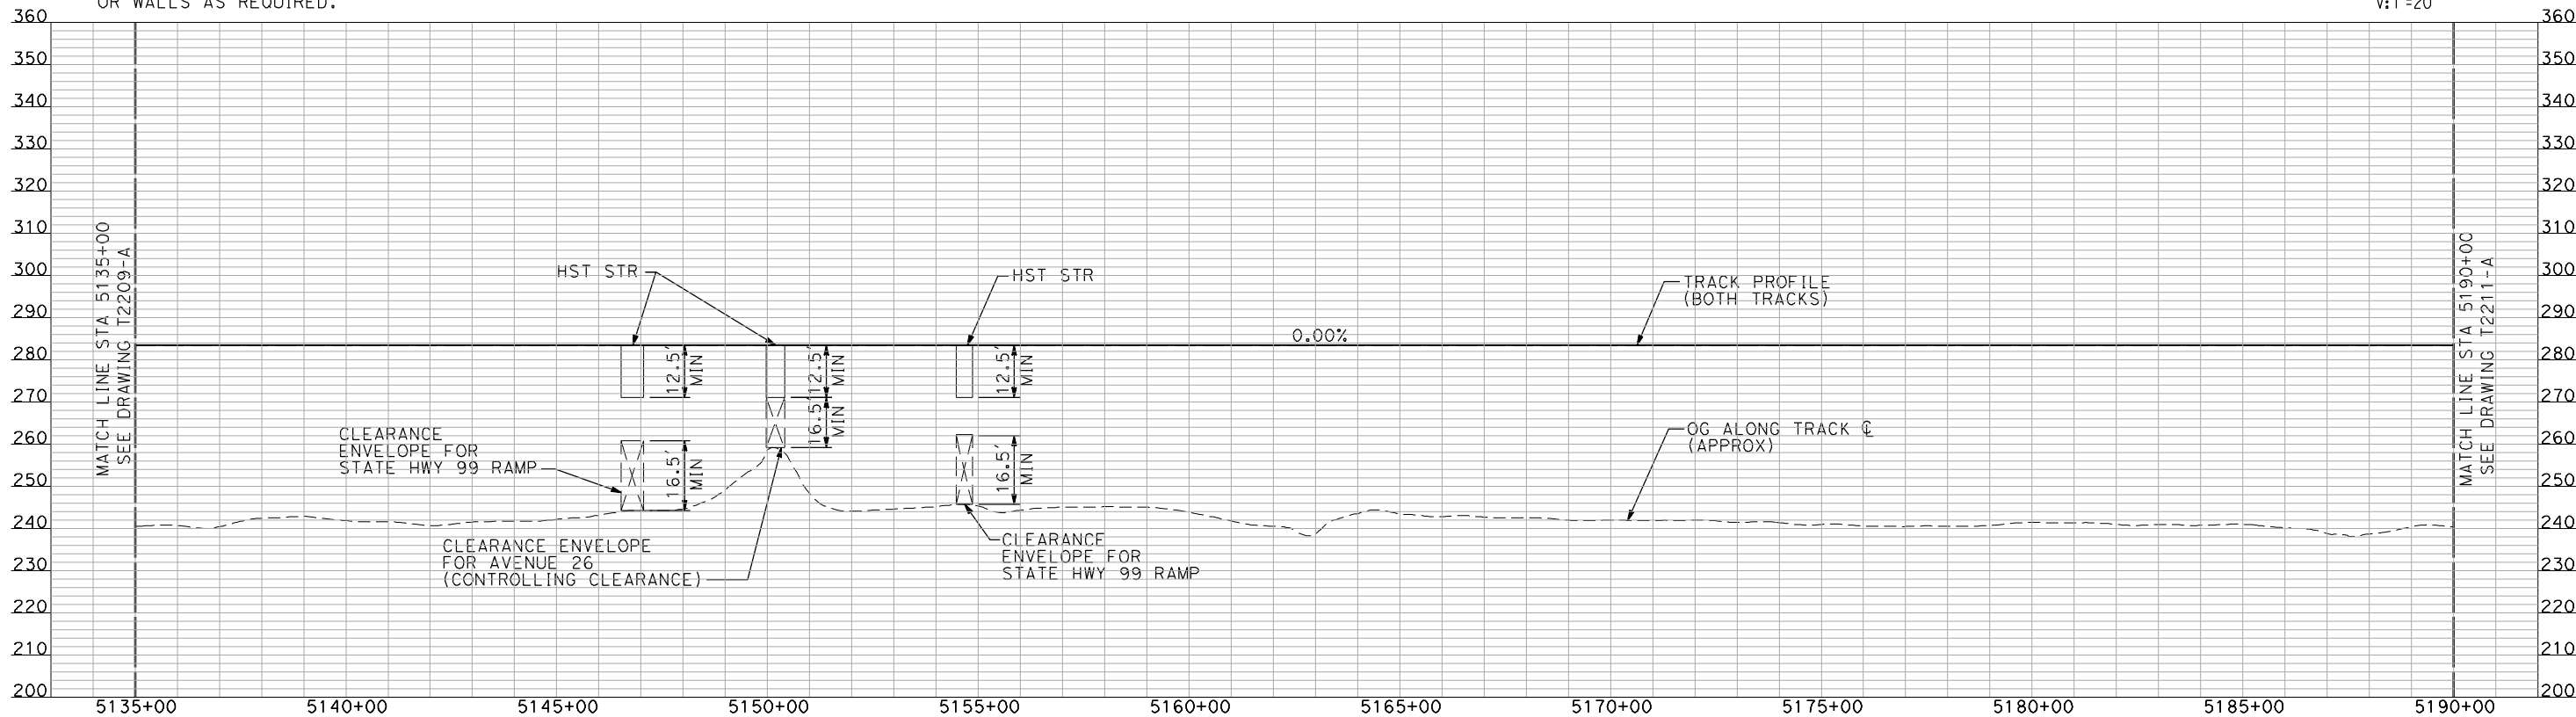
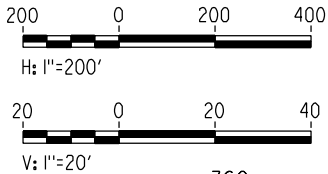
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NOTES:

1. ALL UTILITIES SHOWN ARE EXISTING UTILITY LINES BASED ON RECORD DRAWINGS AND ARE SHOWN FOR INFORMATIONAL PURPOSES ONLY.
2. TRACKS CLOSER THAN 102 FT TO THE NEAREST EXISTING FREIGHT TRACKS WILL INCLUDE SAFETY BARRIERS, BERMS, OR WALLS AS REQUIRED.

PLAN



PROFILE

"SEE T3000-T3017 DRAWINGS FOR  
TYPICAL SECTION LIMITS AND DETAILS"

REV	DATE	BY	CHK	APP	DESCRIPTION

DESIGNED BY A. SHIELDS
DRAWN BY H. SULLIVAN
CHECKED BY A. BOONE
IN CHARGE A. BOONE
DATE 07/20/2011

RECORD SET  
15% DESIGN  
SUBMITTAL

NOT FOR  
CONSTRUCTION



CALIFORNIA  
HIGH-SPEED RAIL AUTHORITY

CALIFORNIA HIGH-SPEED TRAIN PROJECT  
MERCED TO FRESNO

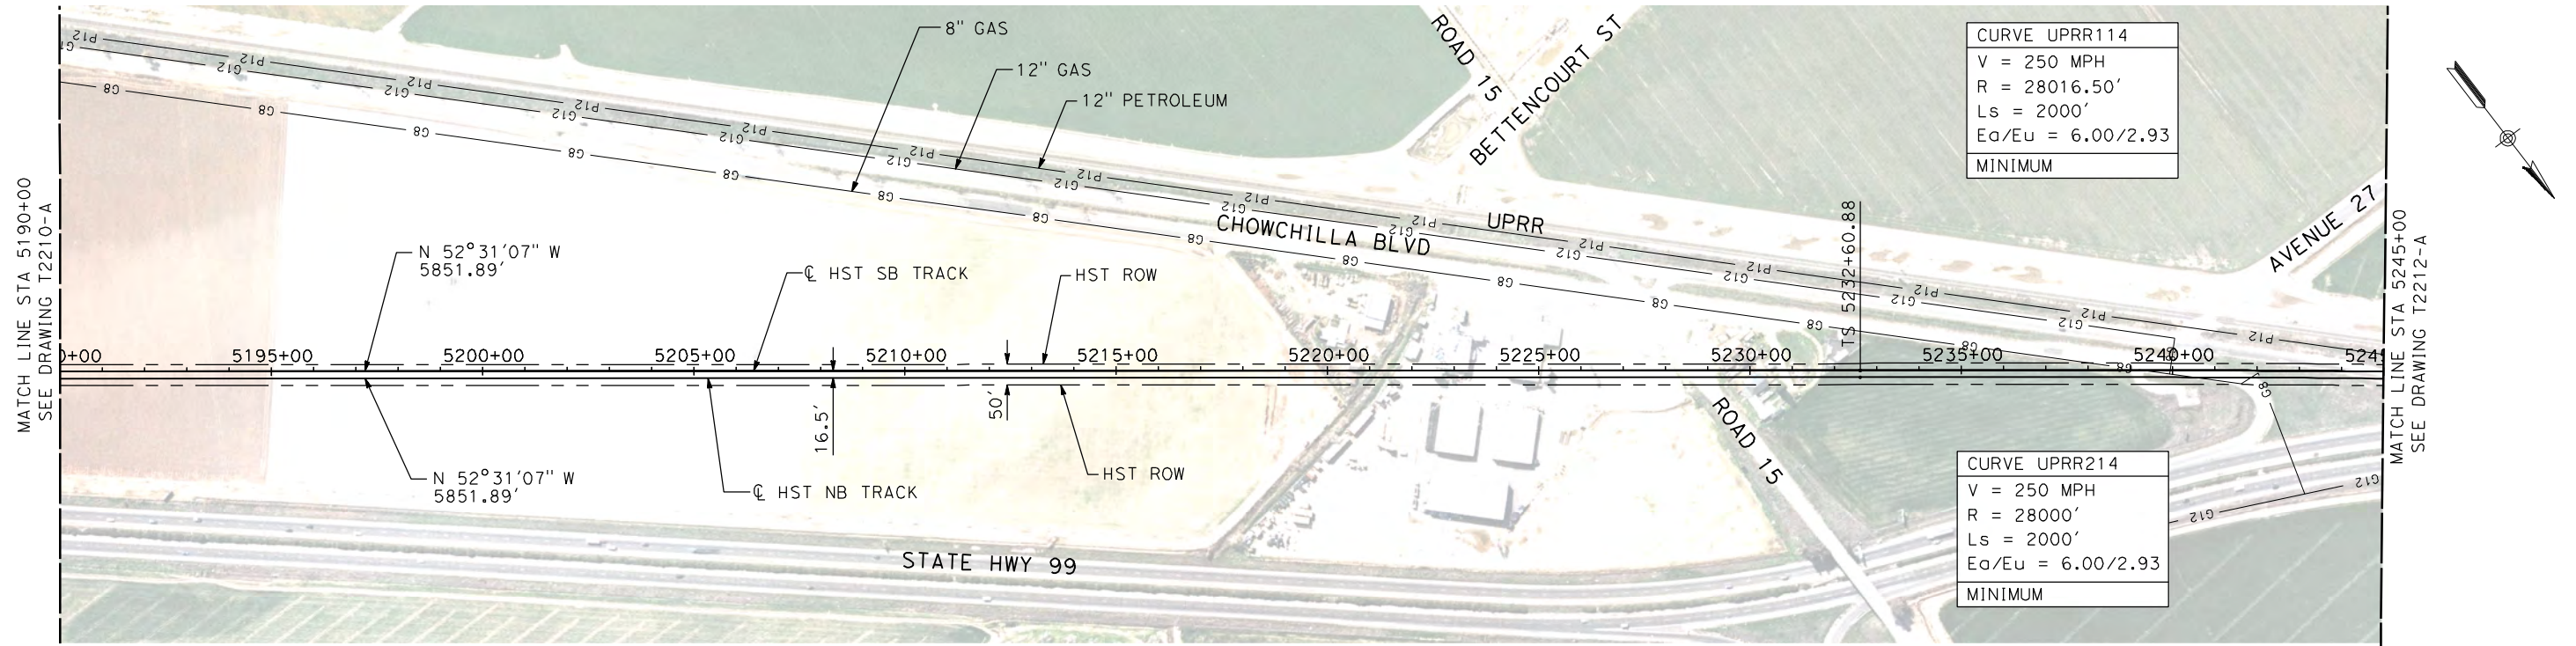
UPRR/SR 99 MERCED CONNECTION

PLAN AND PROFILE  
STA 5135+00 TO STA 5190+00

CONTRACT NO. HSR06-007
DRAWING NO. T2210-A
SCALE AS SHOWN
SHEET NO. ### OF ###



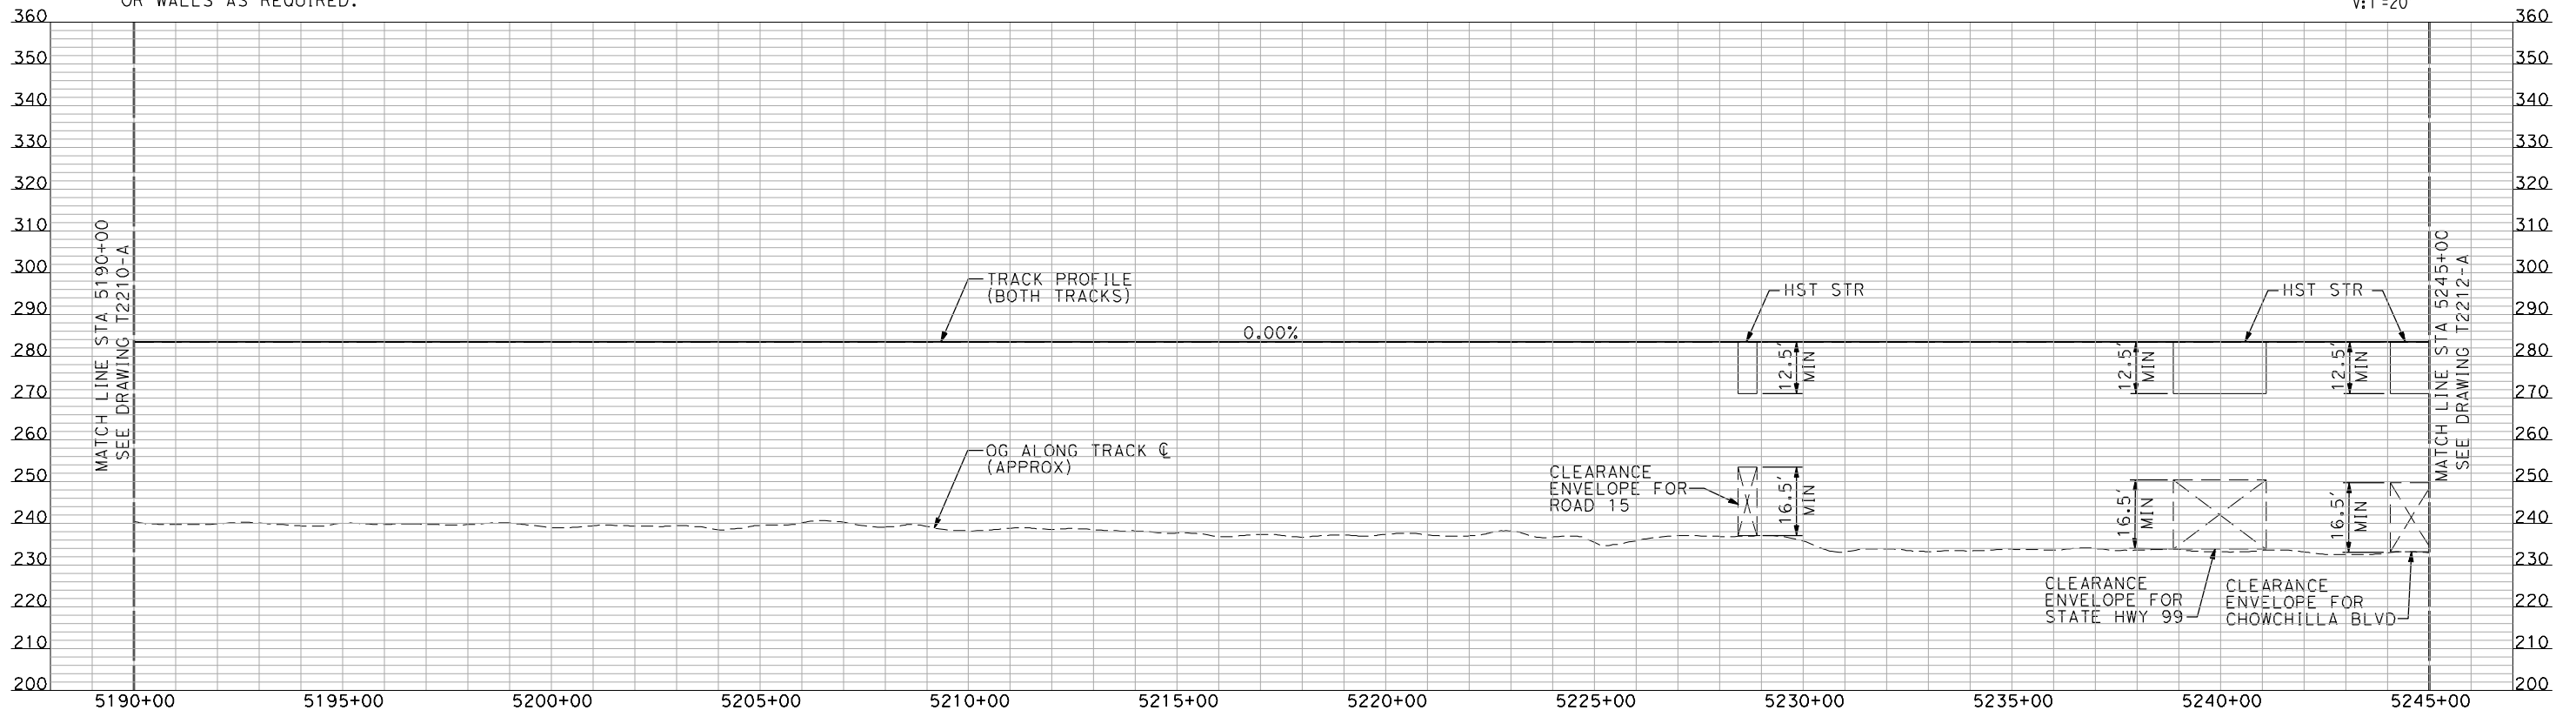
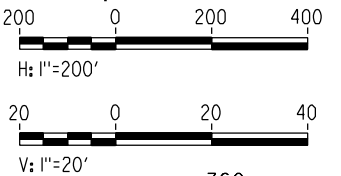
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NOTES:

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2. TRACKS CLOSER THAN 102 FT TO THE NEAREST EXISTING FREIGHT TRACKS WILL INCLUDE SAFETY BARRIERS, BERMS, OR WALLS AS REQUIRED.

PLAN



PROFILE

"SEE T3000-T3017 DRAWINGS FOR TYPICAL SECTION LIMITS AND DETAILS"

REV	DATE	BY	CHK	APP	DESCRIPTION

DESIGNED BY A. SHIELDS
DRAWN BY H. SULLIVAN
CHECKED BY A. BOONE
IN CHARGE A. BOONE
DATE 07/20/2011

RECORD SET  
15% DESIGN  
SUBMITTAL

NOT FOR  
CONSTRUCTION

**AECOM**  
Technical Services, Inc.  
2020 L Street, Suite 300  
Sacramento, CA 95811

**CH2M HILL**



**CALIFORNIA**  
HIGH-SPEED RAIL AUTHORITY

**CALIFORNIA HIGH-SPEED TRAIN PROJECT  
MERCED TO FRESNO**

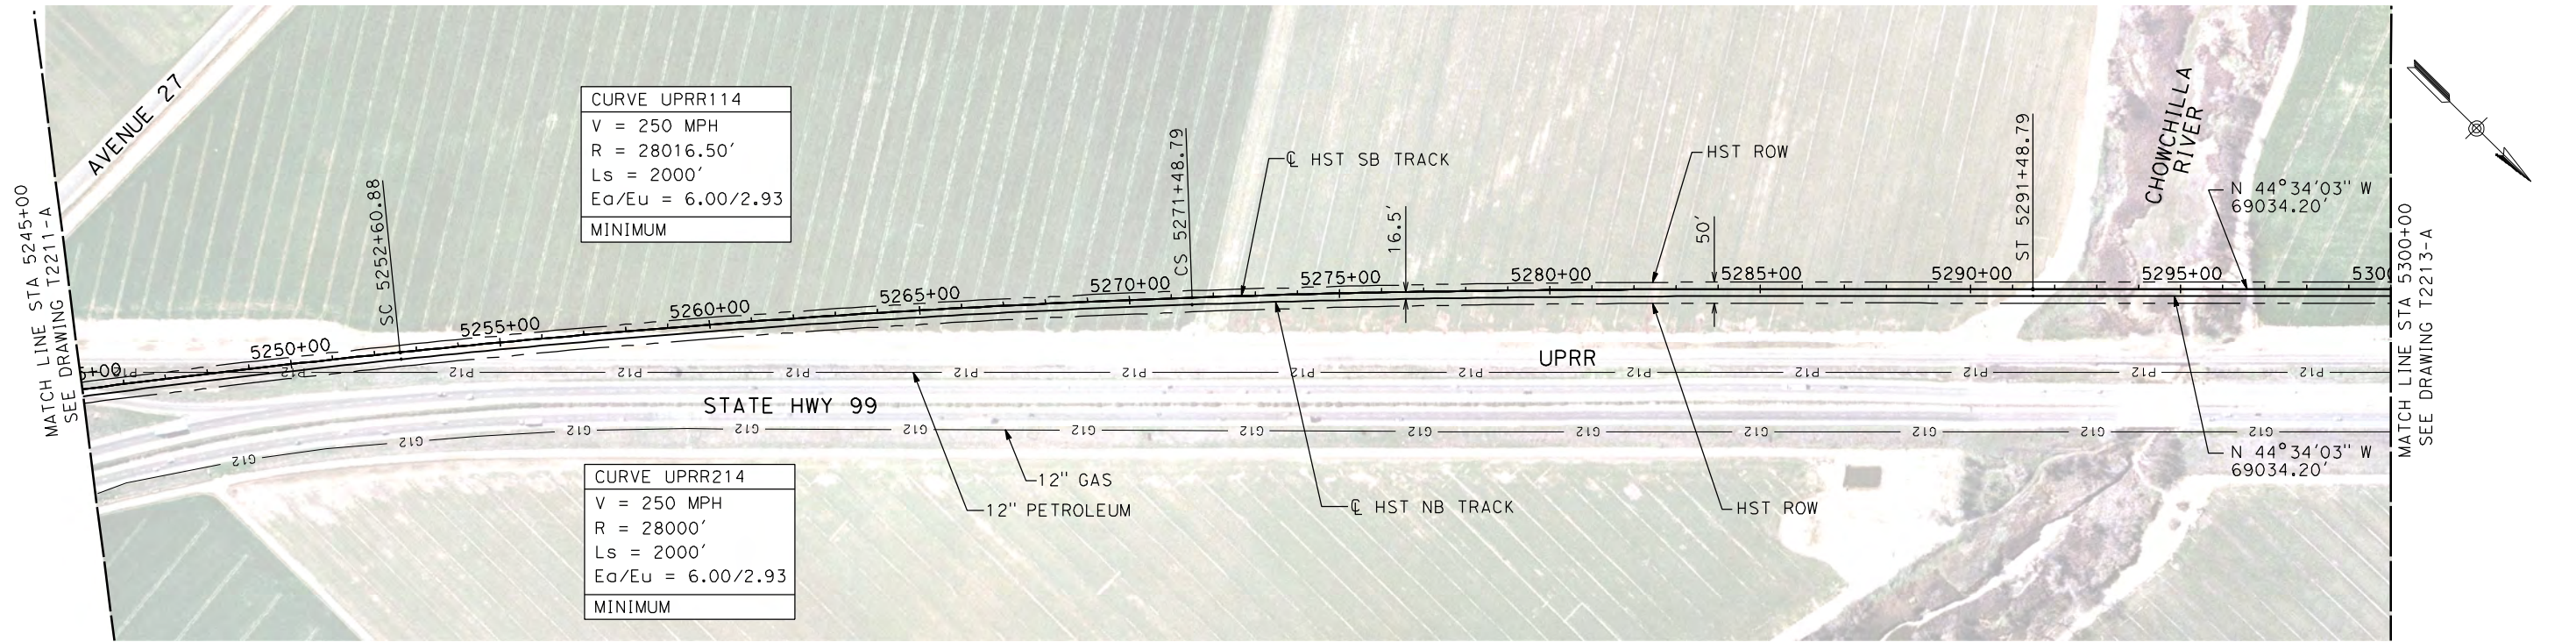
UPRR/SR 99 MERCED CONNECTION

PLAN AND PROFILE  
STA 5190+00 TO STA 5245+00

CONTRACT NO. HSR06-007
DRAWING NO. T2211-A
SCALE AS SHOWN
SHEET NO. ### OF ###



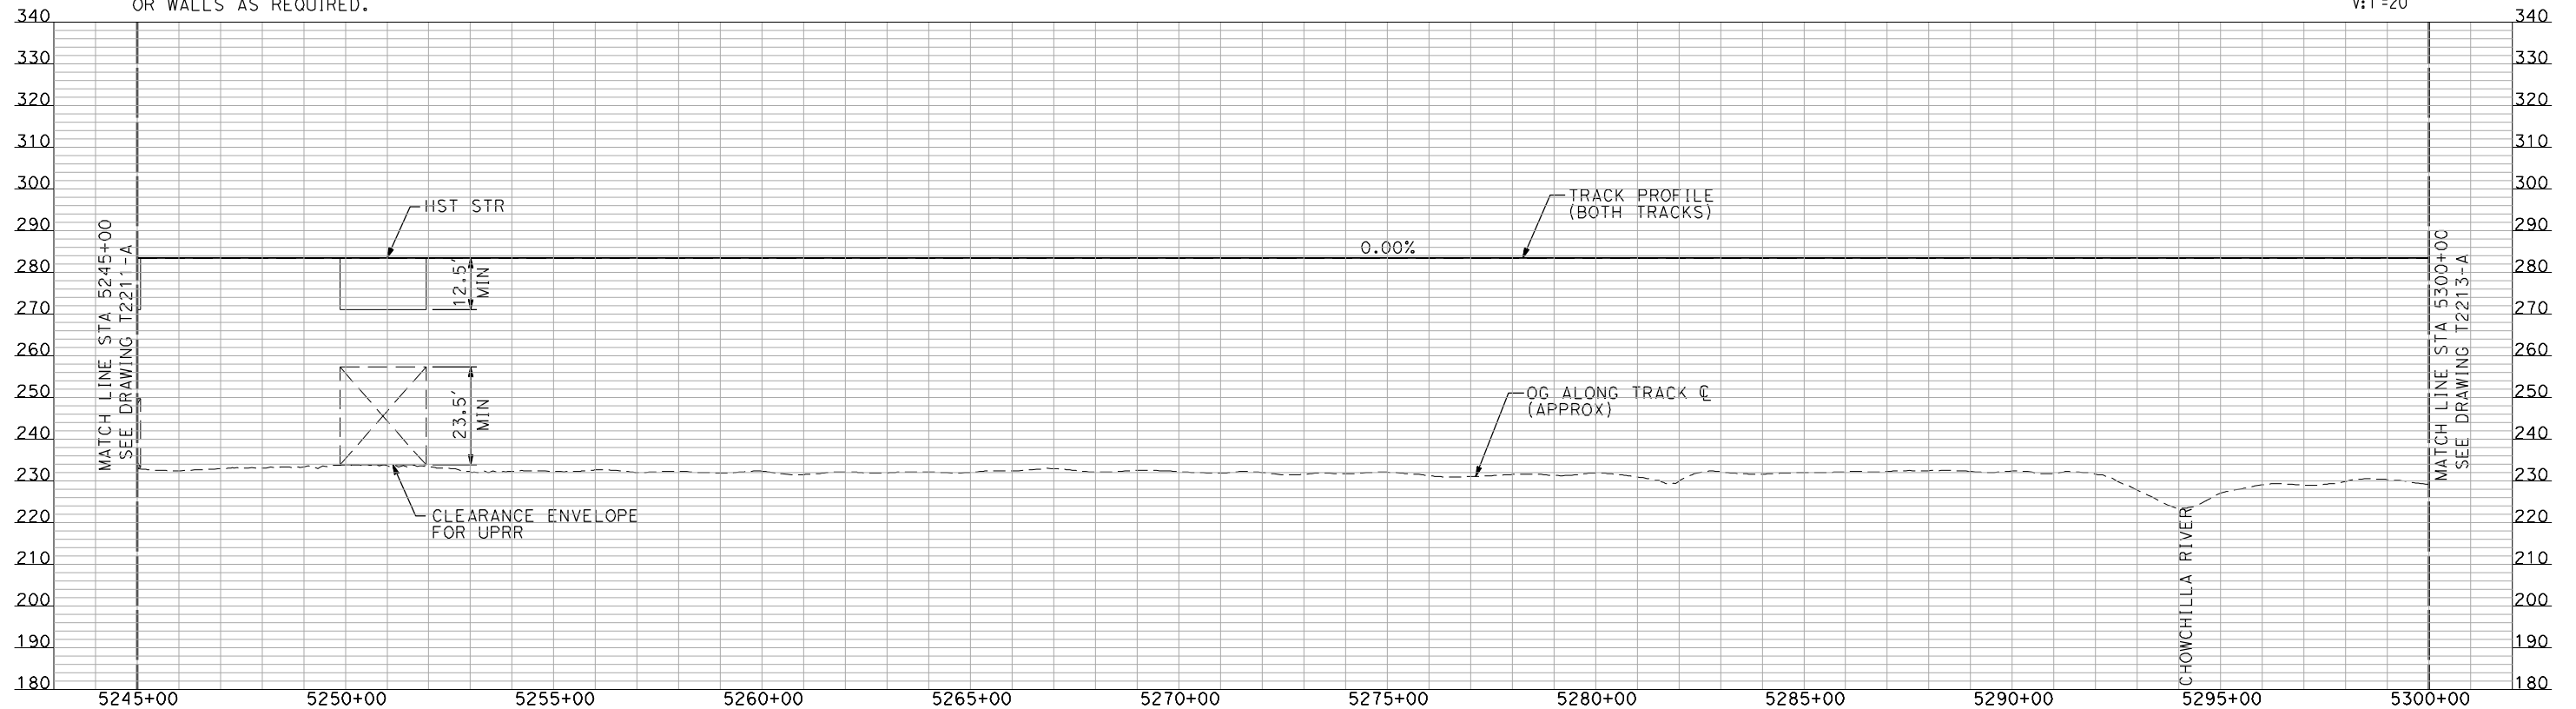
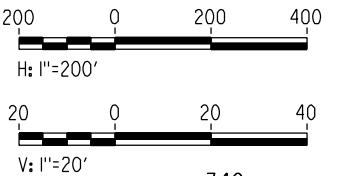
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NOTES:

1. ALL UTILITIES SHOWN ARE EXISTING UTILITY LINES BASED ON RECORD DRAWINGS AND ARE SHOWN FOR INFORMATIONAL PURPOSES ONLY.
2. TRACKS CLOSER THAN 102 FT TO THE NEAREST EXISTING FREIGHT TRACKS WILL INCLUDE SAFETY BARRIERS, BERMS, OR WALLS AS REQUIRED.

PLAN



"SEE T3000-T3017 DRAWINGS FOR TYPICAL SECTION LIMITS AND DETAILS"

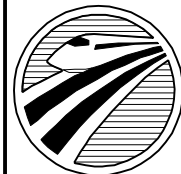
REV	DATE	BY	CHK	APP	DESCRIPTION

DESIGNED BY  
A. SHIELDS  
DRAWN BY  
H. SULLIVAN  
CHECKED BY  
A. BOONE  
IN CHARGE  
A. BOONE  
DATE  
07/20/2011

RECORD SET  
15% DESIGN  
SUBMITTAL

NOT FOR  
CONSTRUCTION

**AECOM**  
Technical Services, Inc.  
2020 L Street, Suite 300  
Sacramento, CA 95811  
**CH2M HILL**



**CALIFORNIA**  
HIGH-SPEED RAIL AUTHORITY

**CALIFORNIA HIGH-SPEED TRAIN PROJECT  
MERCED TO FRESNO**

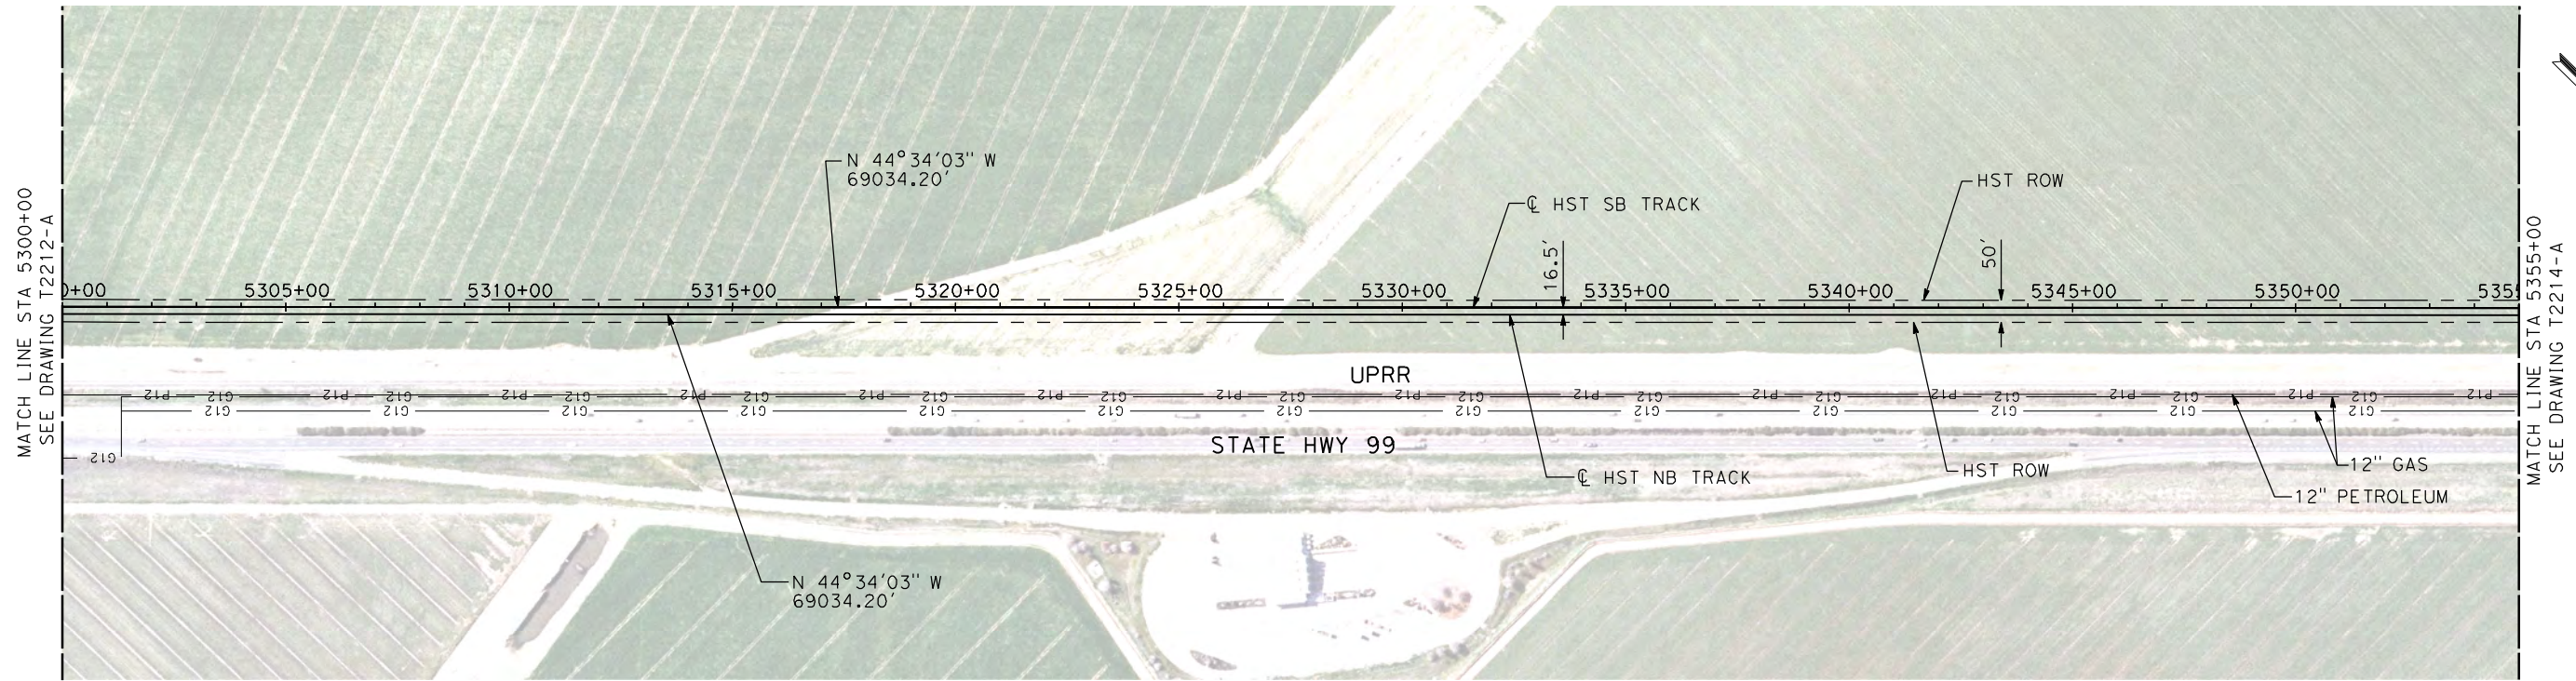
UPRR/SR 99 MERCED CONNECTION

PLAN AND PROFILE  
STA 5245+00 TO STA 5300+00

CONTRACT NO.  
HSR06-007  
DRAWING NO.  
T2212-A  
SCALE  
AS SHOWN  
SHEET NO.  
### OF ###



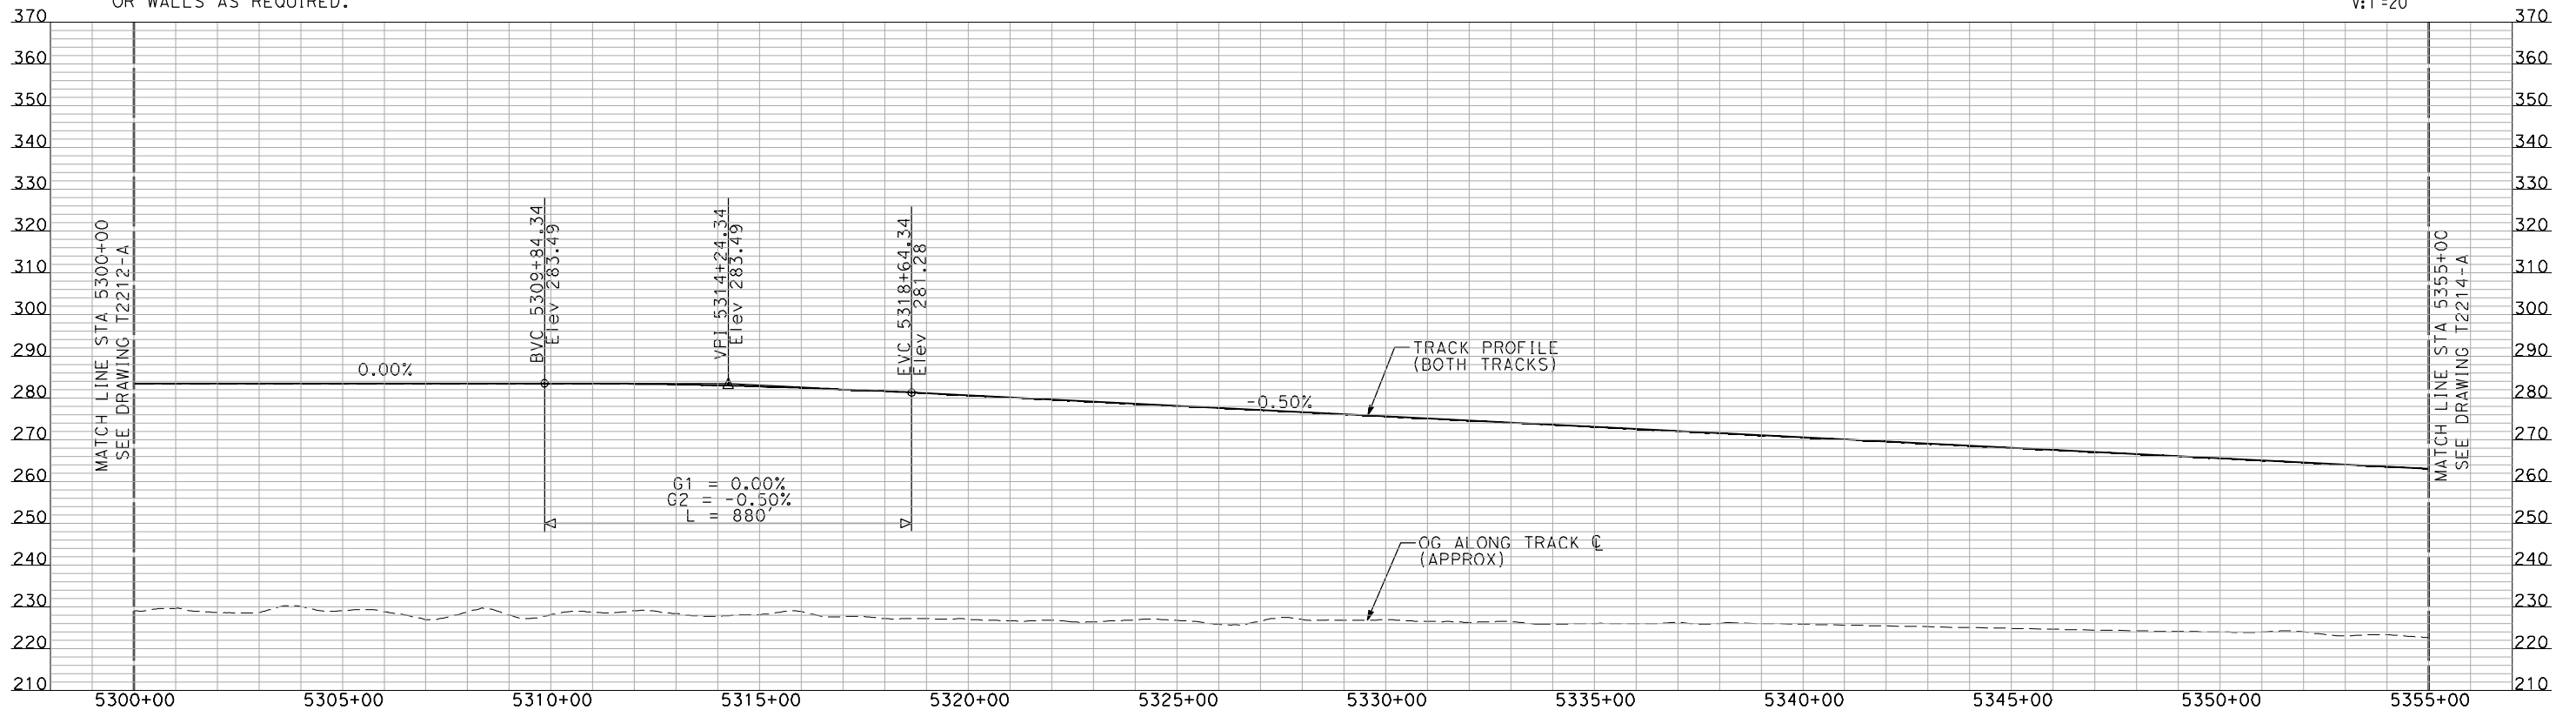
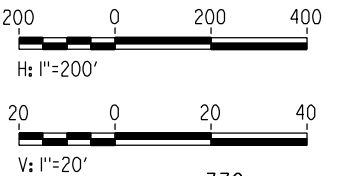
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NOTES:

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PLAN



PROFILE

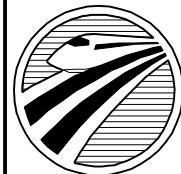
"SEE T3000-T3017 DRAWINGS FOR  
TYPICAL SECTION LIMITS AND DETAILS"

REV	DATE	BY	CHK	APP	DESCRIPTION

DESIGNED BY A. SHIELDS
DRAWN BY H. SULLIVAN
CHECKED BY A. BOONE
IN CHARGE A. BOONE
DATE 07/20/2011

RECORD SET  
15% DESIGN  
SUBMITTAL

NOT FOR  
CONSTRUCTION



CALIFORNIA  
HIGH-SPEED RAIL AUTHORITY

CALIFORNIA HIGH-SPEED TRAIN PROJECT  
MERCED TO FRESNO

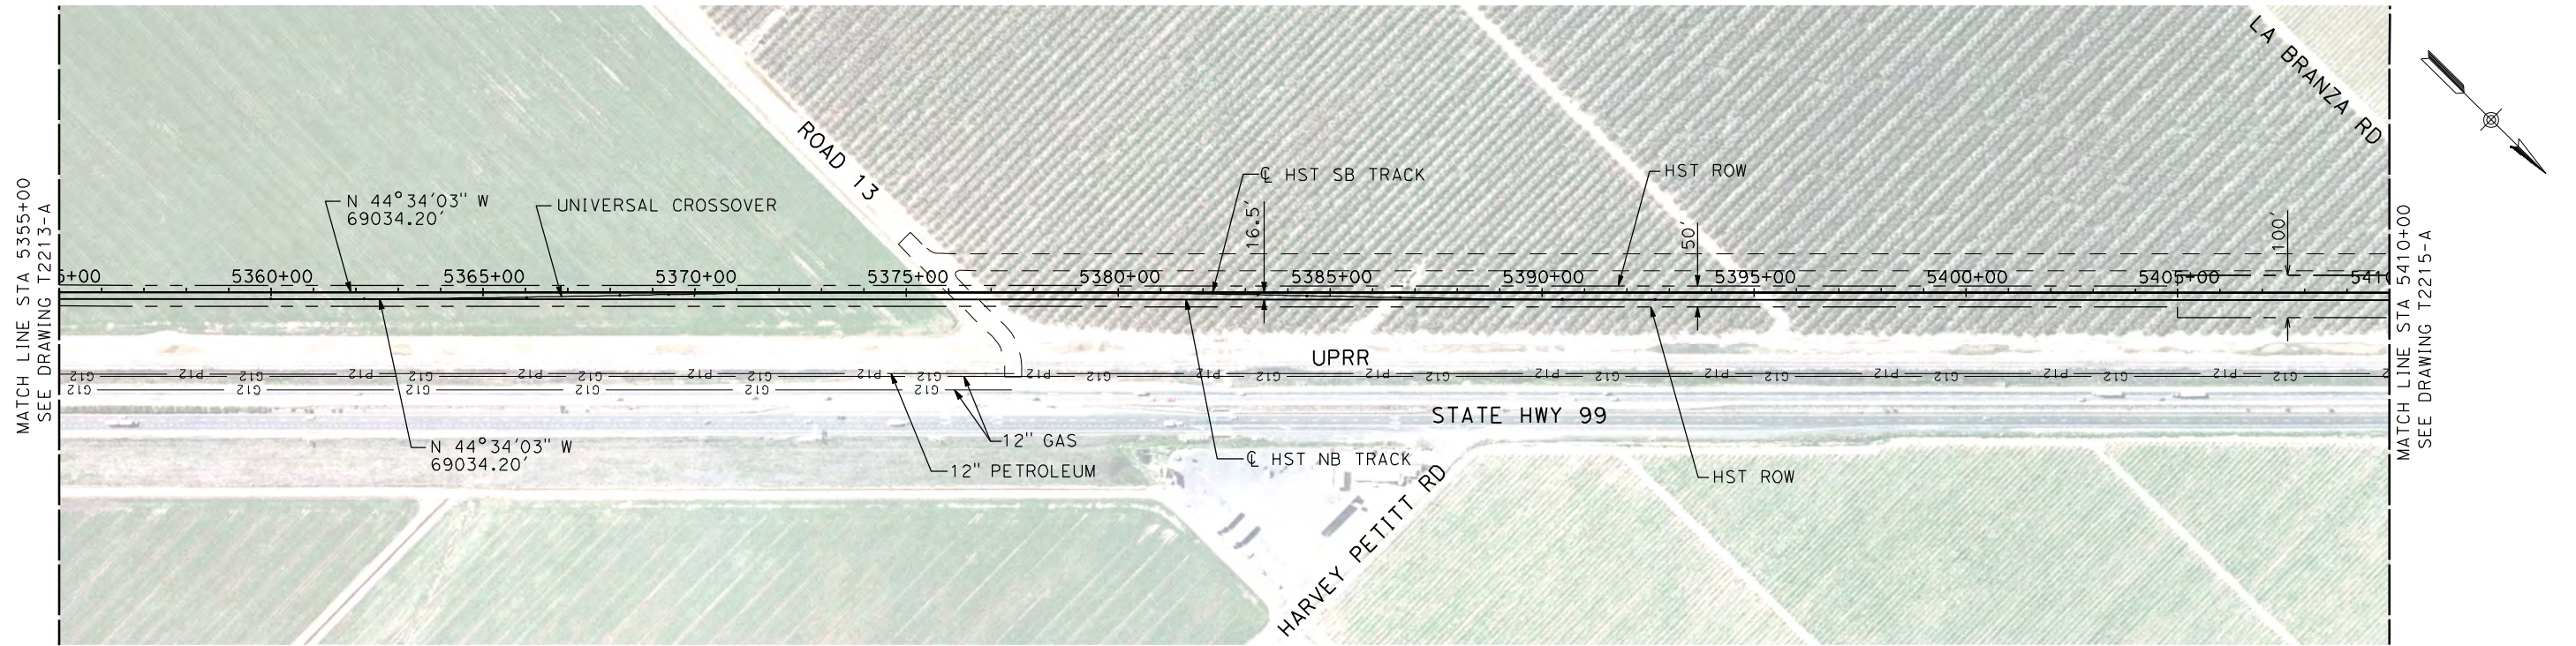
UPRR/SR 99 MERCED CONNECTION

PLAN AND PROFILE  
STA 5300+00 TO STA 5355+00

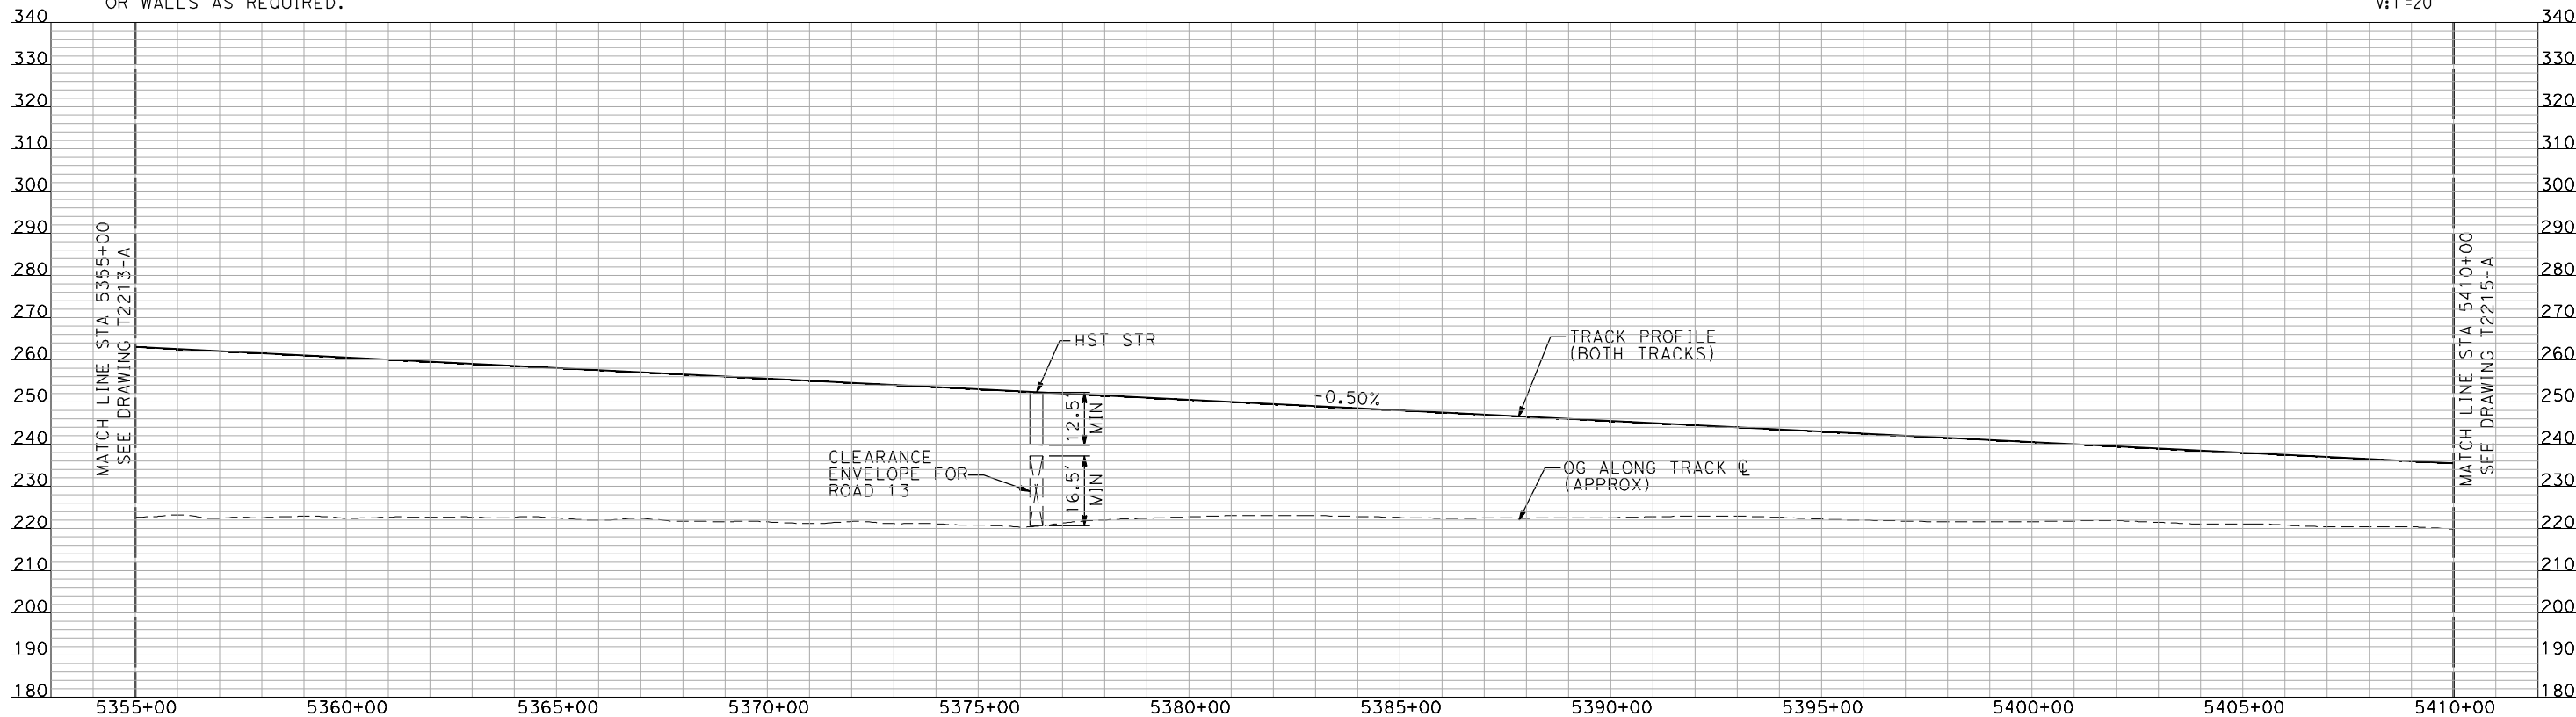
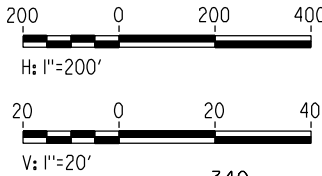
CONTRACT NO. HSR06-007
DRAWING NO. T2213-A
SCALE AS SHOWN
SHEET NO. ### OF ###



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- NOTES:
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"SEE T3000-T3017 DRAWINGS FOR  
TYPICAL SECTION LIMITS AND DETAILS"

REV	DATE	BY	CHK	APP	DESCRIPTION

DESIGNED BY  
A. SHIELDS  
DRAWN BY  
H. SULLIVAN  
CHECKED BY  
A. BOONE  
IN CHARGE  
A. BOONE  
DATE  
07/20/2011

RECORD SET  
15% DESIGN  
SUBMITTAL

NOT FOR  
CONSTRUCTION

**AECOM**  
Technical Services, Inc.  
2020 L Street, Suite 300  
Sacramento, CA 95811  
**CH2MHILL**



**CALIFORNIA**  
HIGH-SPEED RAIL AUTHORITY

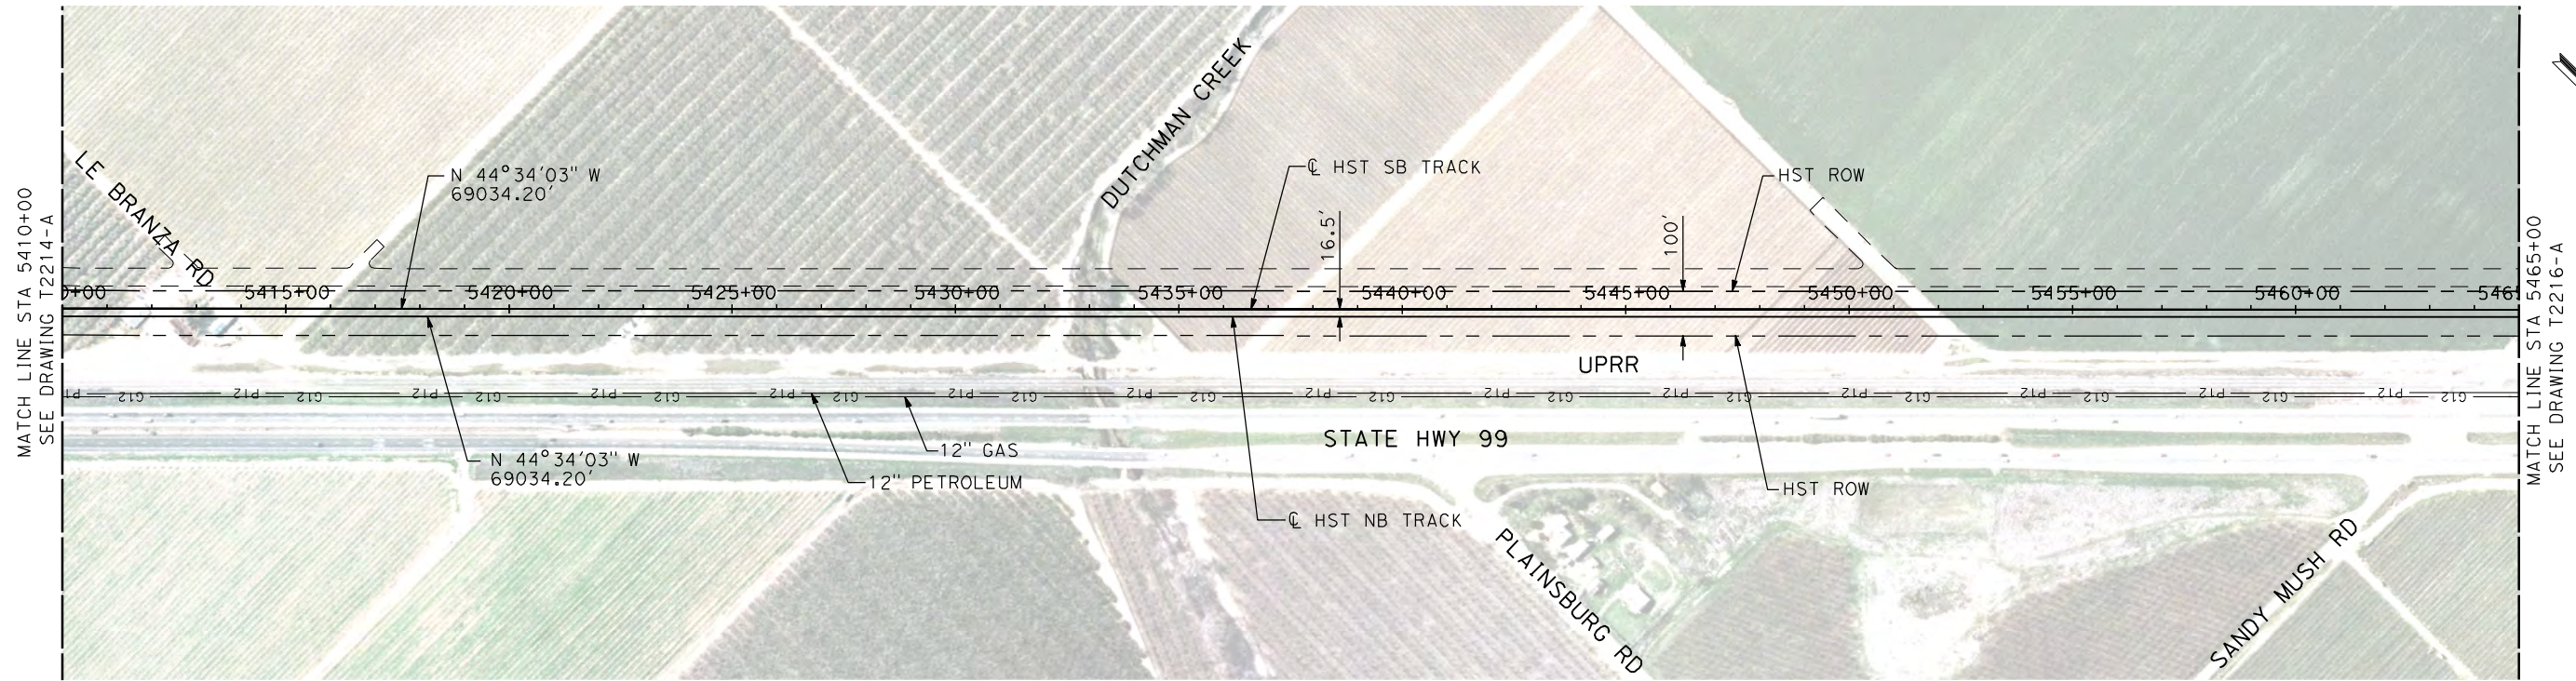
**CALIFORNIA HIGH-SPEED TRAIN PROJECT  
MERCED TO FRESNO**

UPRR/SR 99 MERCED CONNECTION

PLAN AND PROFILE  
STA 5355+00 TO STA 5410+00

CONTRACT NO.  
HSR06-007  
DRAWING NO.  
T2214-A  
SCALE  
AS SHOWN  
SHEET NO.  
### OF ###

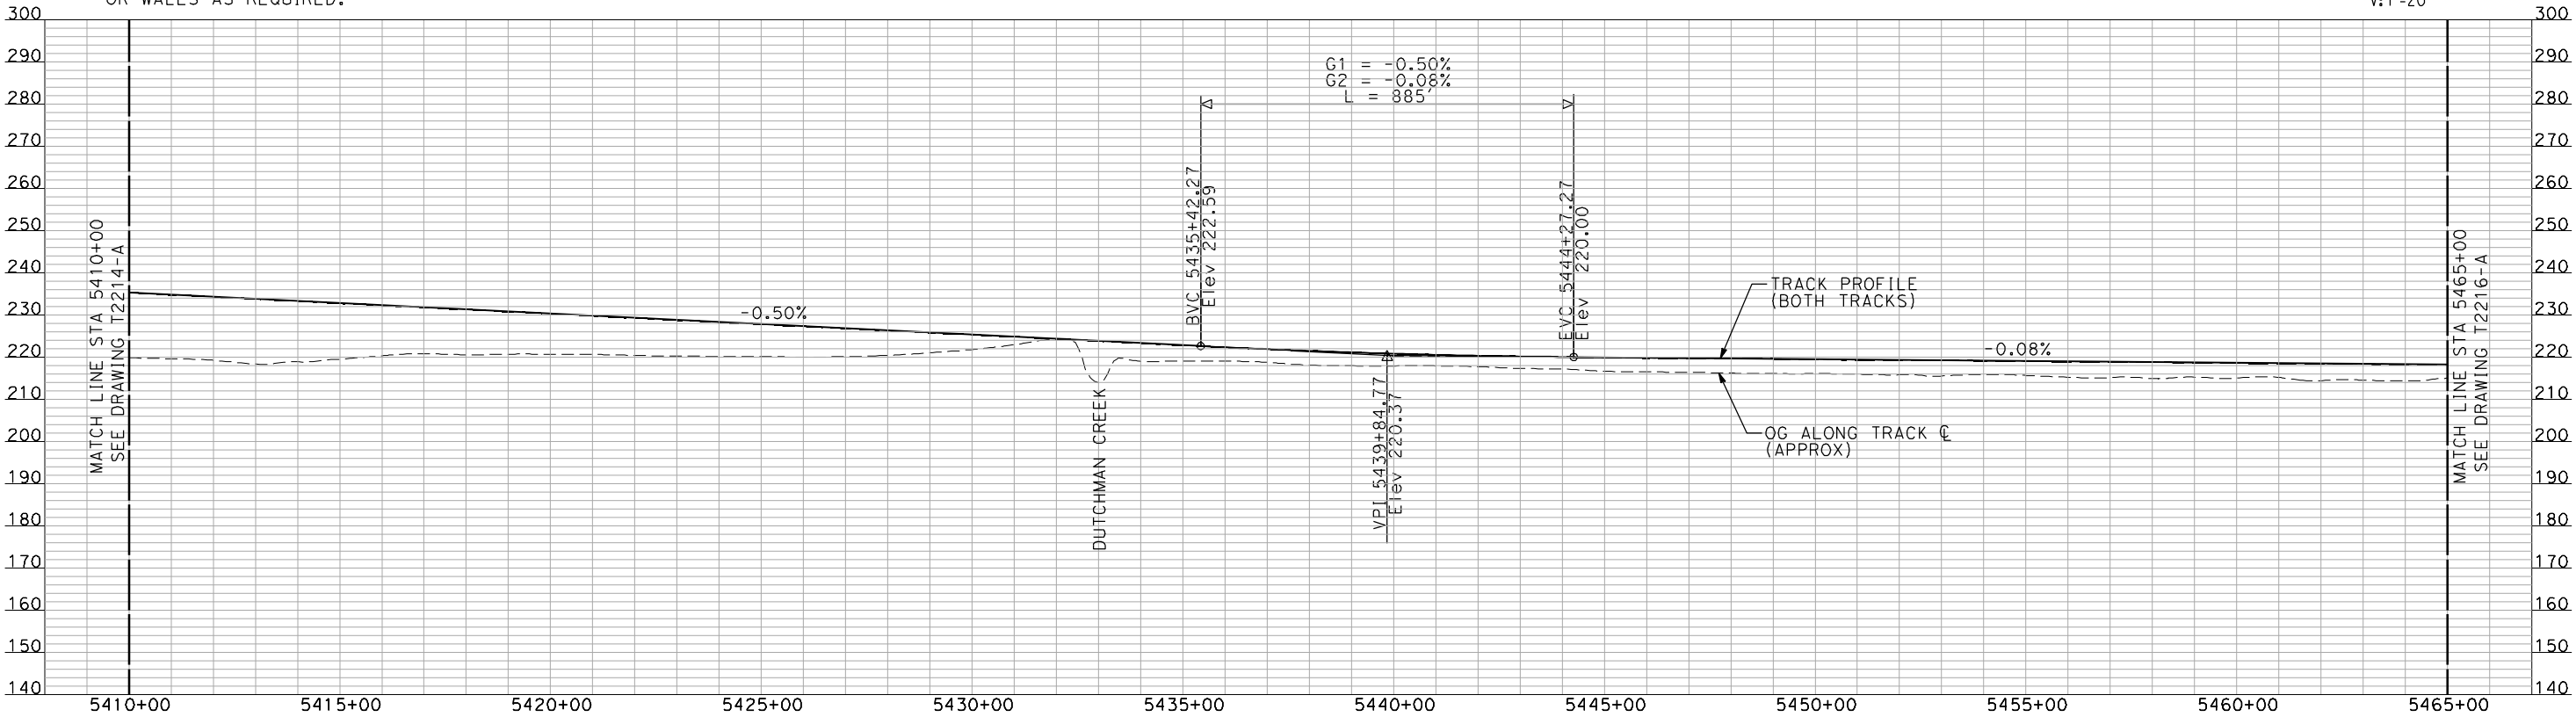
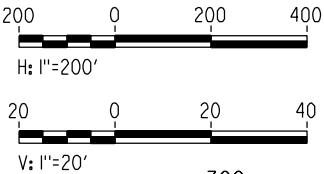




NOTES:

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PLAN



PROFILE

"SEE T3000-T3017 DRAWINGS FOR  
TYPICAL SECTION LIMITS AND DETAILS"

REV	DATE	BY	CHK	APP	DESCRIPTION

DESIGNED BY A. SHIELDS
DRAWN BY H. SULLIVAN
CHECKED BY A. BOONE
IN CHARGE A. BOONE
DATE 07/20/2011

RECORD SET  
15% DESIGN  
SUBMITTAL

NOT FOR  
CONSTRUCTION



CALIFORNIA  
HIGH-SPEED RAIL AUTHORITY

CALIFORNIA HIGH-SPEED TRAIN PROJECT  
MERCED TO FRESNO

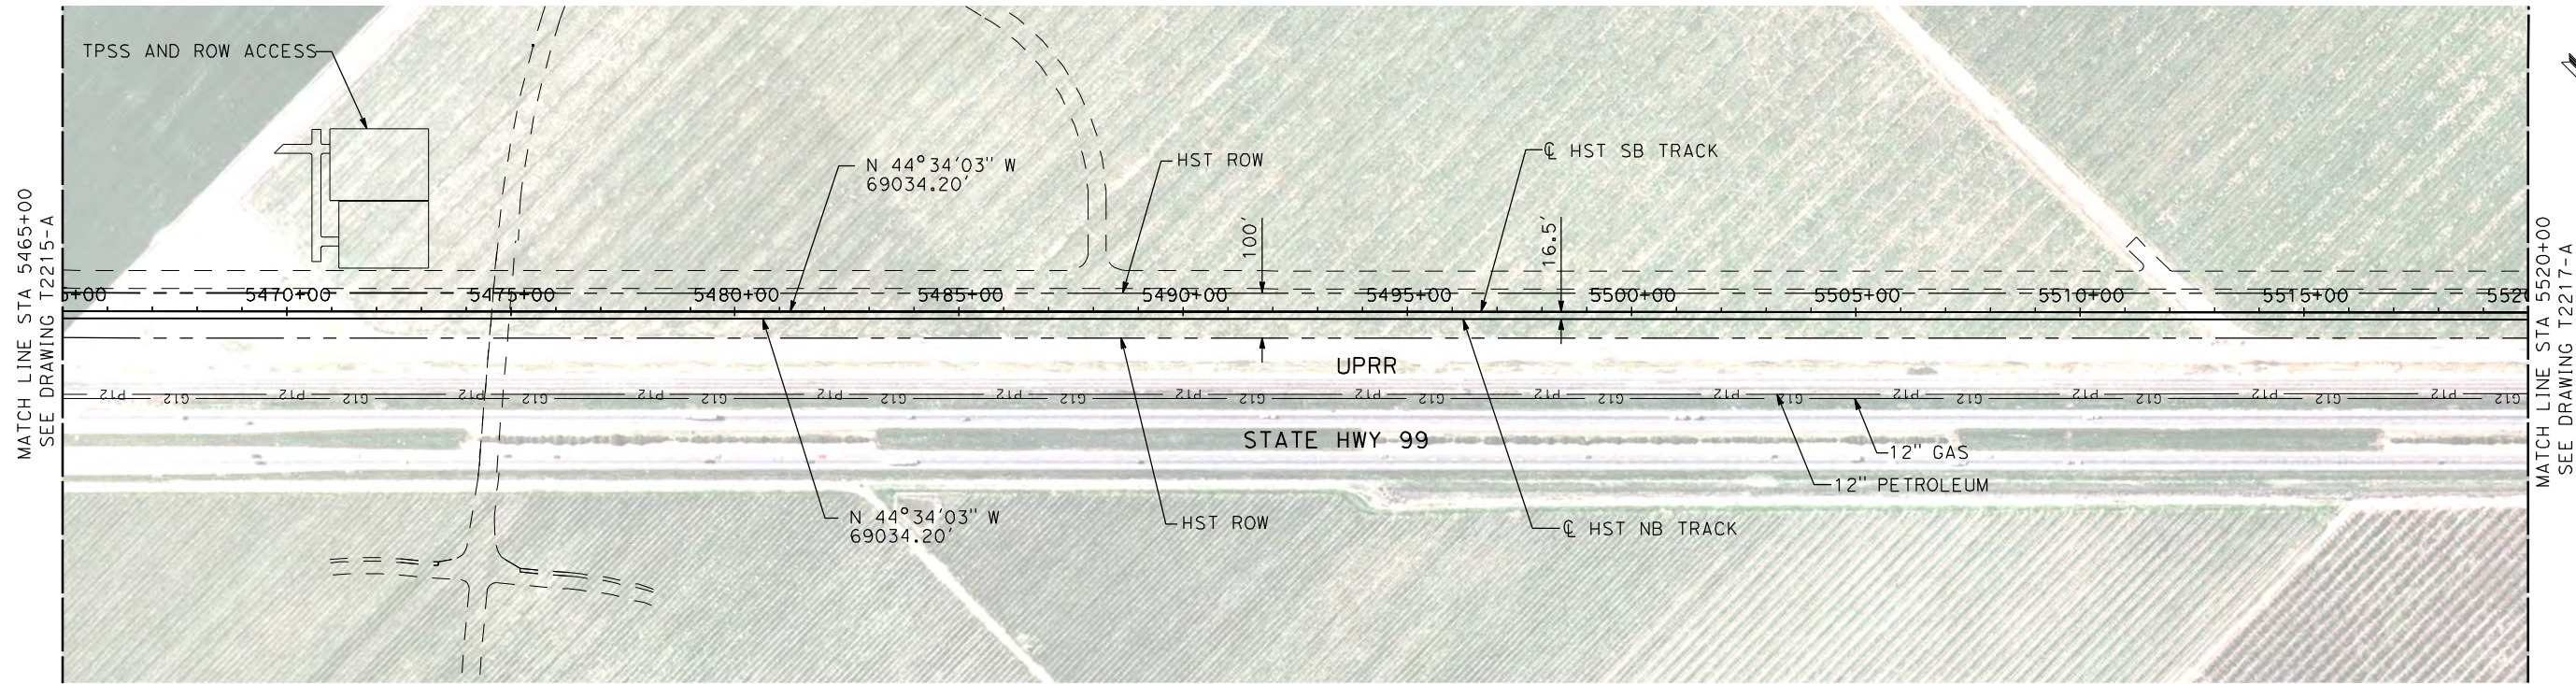
UPRR/SR 99 MERCED CONNECTION

PLAN AND PROFILE  
STA 5410+00 TO STA 5465+00

CONTRACT NO. HSR06-007
DRAWING NO. T2215-A
SCALE AS SHOWN
SHEET NO. ### OF ###



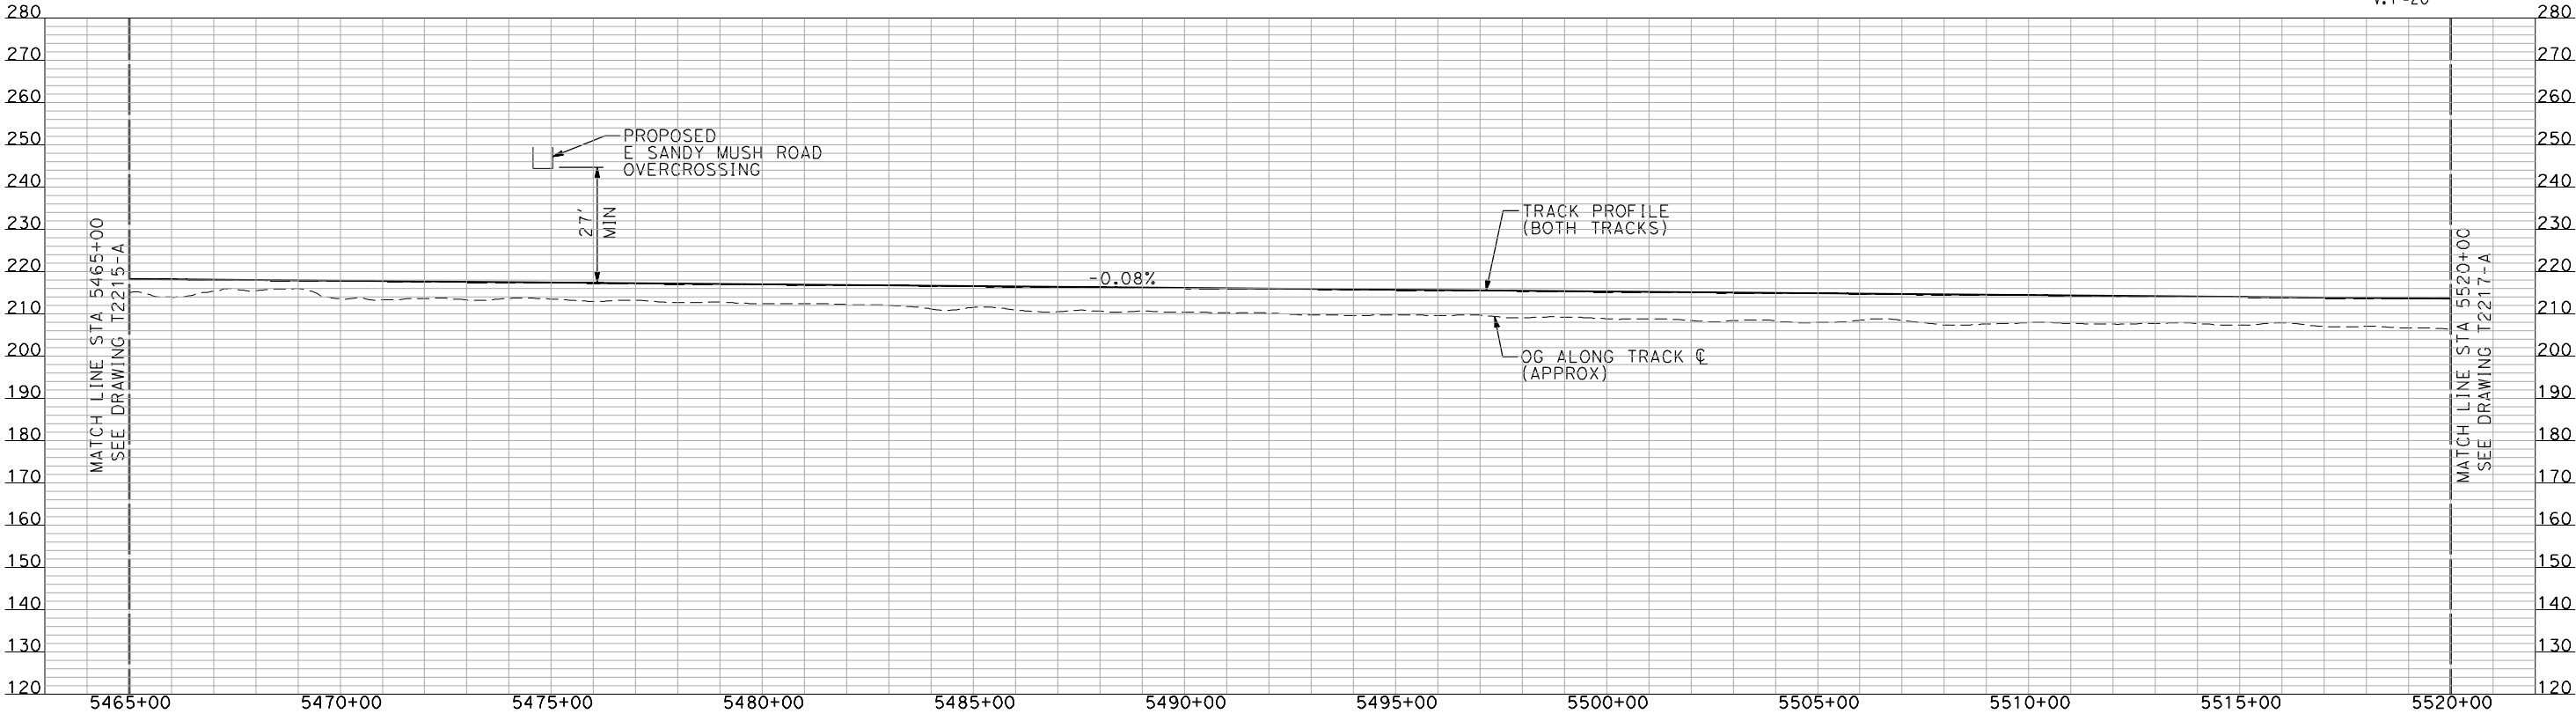
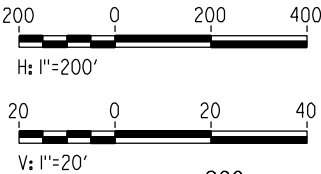
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NOTES:

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PLAN



PROFILE

"SEE T3000-T3017 DRAWINGS FOR  
TYPICAL SECTION LIMITS AND DETAILS"

REV	DATE	BY	CHK	APP	DESCRIPTION

DESIGNED BY A. SHIELDS
DRAWN BY H. SULLIVAN
CHECKED BY A. BOONE
IN CHARGE A. BOONE
DATE 07/20/2011

RECORD SET  
15% DESIGN  
SUBMITTAL

NOT FOR  
CONSTRUCTION



**CALIFORNIA HIGH-SPEED TRAIN PROJECT  
MERCED TO FRESNO**

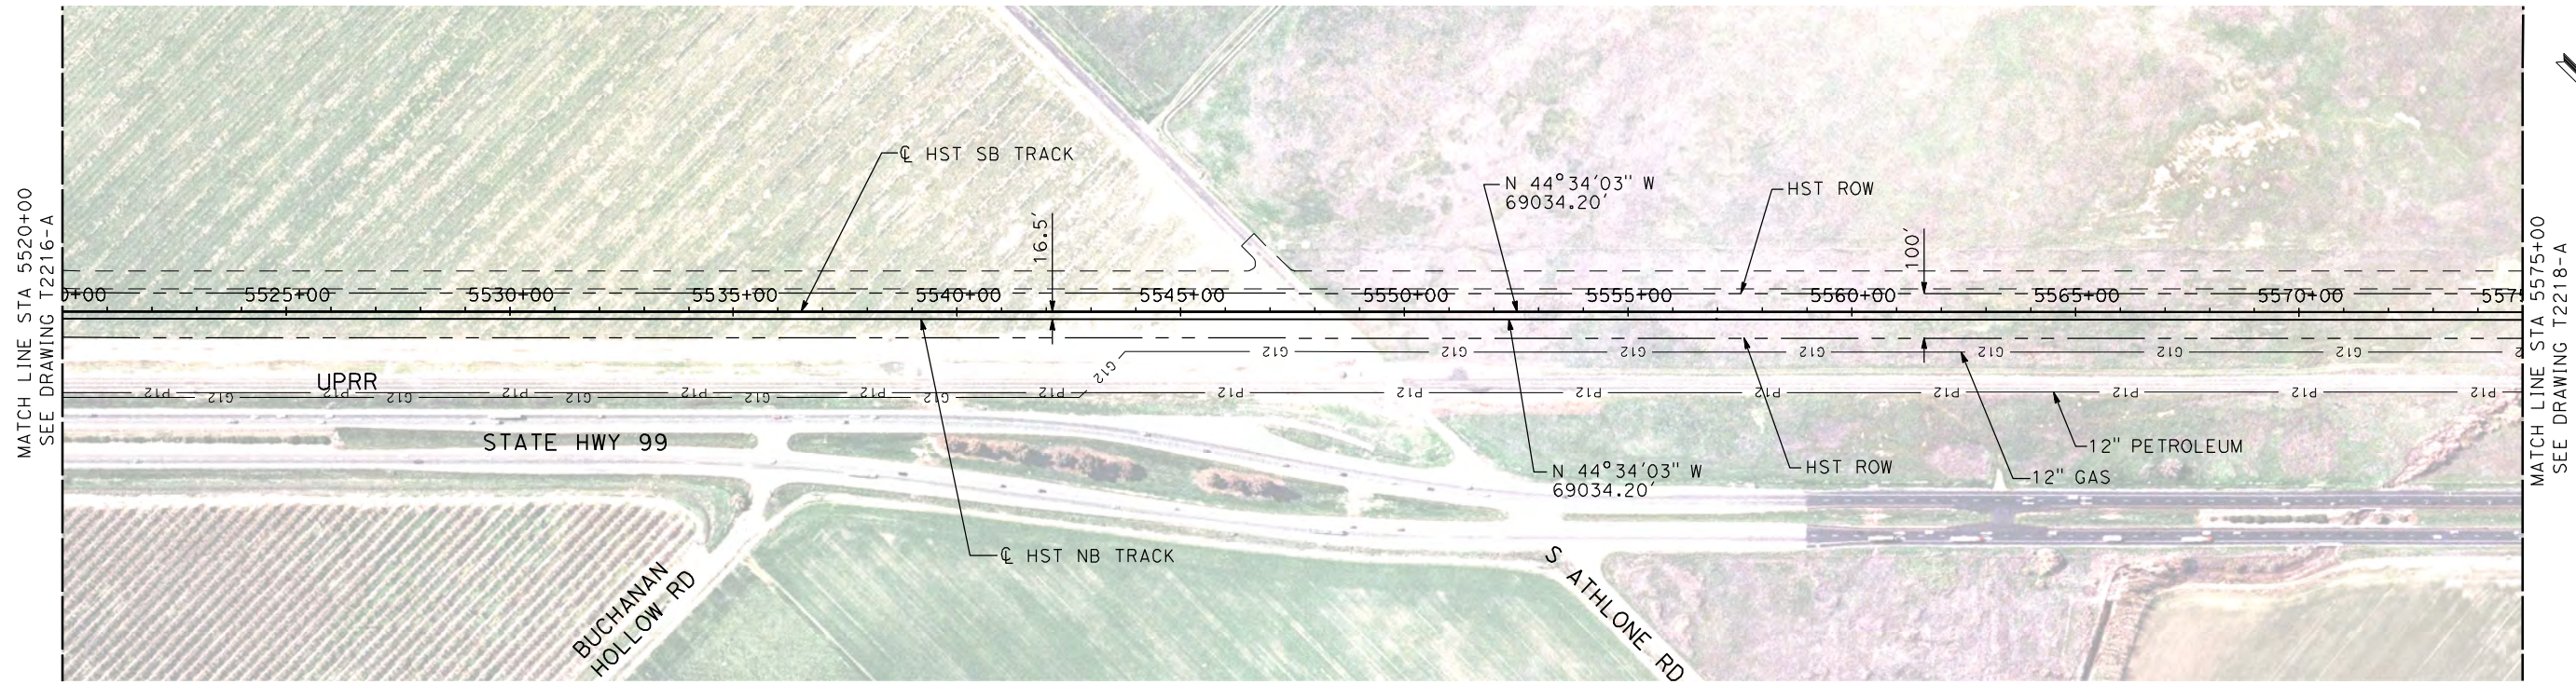
UPRR/SR 99 MERCED CONNECTION

PLAN AND PROFILE  
STA 5465+00 TO STA 5520+00

CONTRACT NO. HSR06-007
DRAWING NO. T2216-A
SCALE AS SHOWN
SHEET NO. ### OF ###



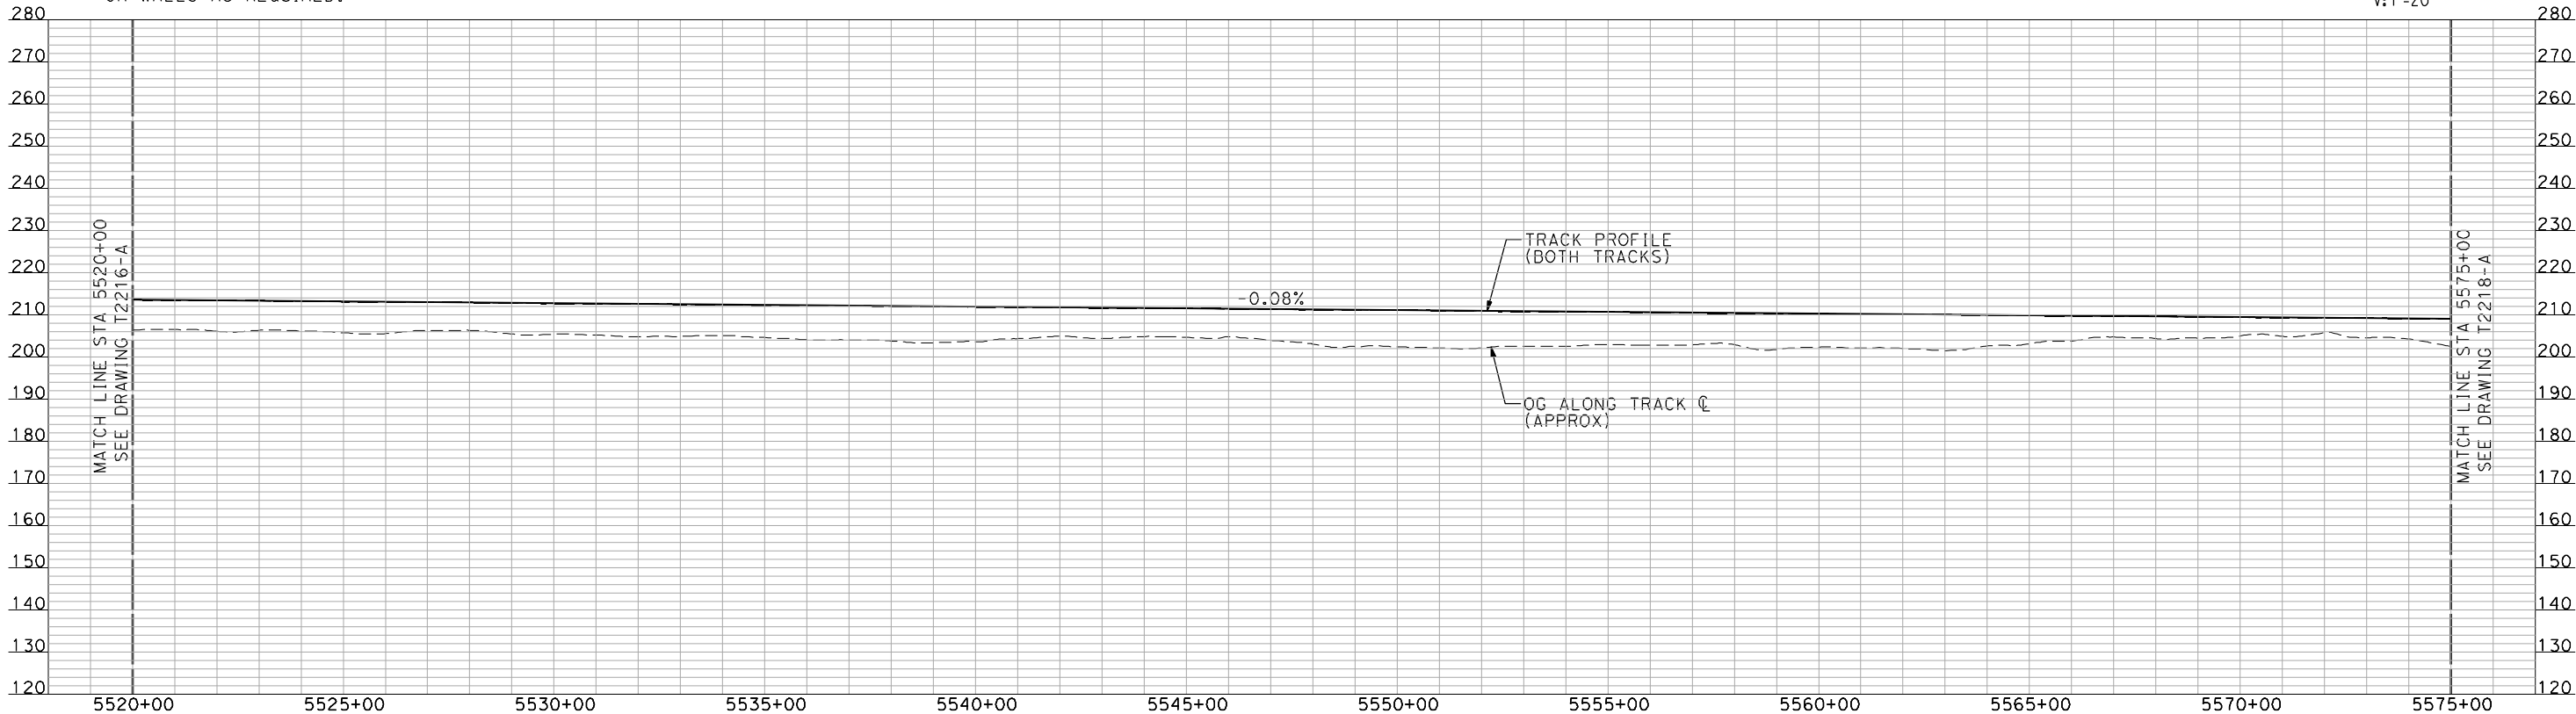
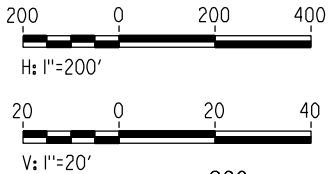
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NOTES:

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PLAN



PROFILE

"SEE T3000-T3017 DRAWINGS FOR  
TYPICAL SECTION LIMITS AND DETAILS"

REV	DATE	BY	CHK	APP	DESCRIPTION

DESIGNED BY  
A. SHIELDS  
DRAWN BY  
H. SULLIVAN  
CHECKED BY  
A. BOONE  
IN CHARGE  
A. BOONE  
DATE  
07/20/2011

RECORD SET  
15% DESIGN  
SUBMITTAL

NOT FOR  
CONSTRUCTION

**AECOM**  
Technical Services, Inc.  
2020 L Street, Suite 300  
Sacramento, CA 95811  
**CH2MHILL**



**CALIFORNIA**  
HIGH-SPEED RAIL AUTHORITY

**CALIFORNIA HIGH-SPEED TRAIN PROJECT  
MERCED TO FRESNO**

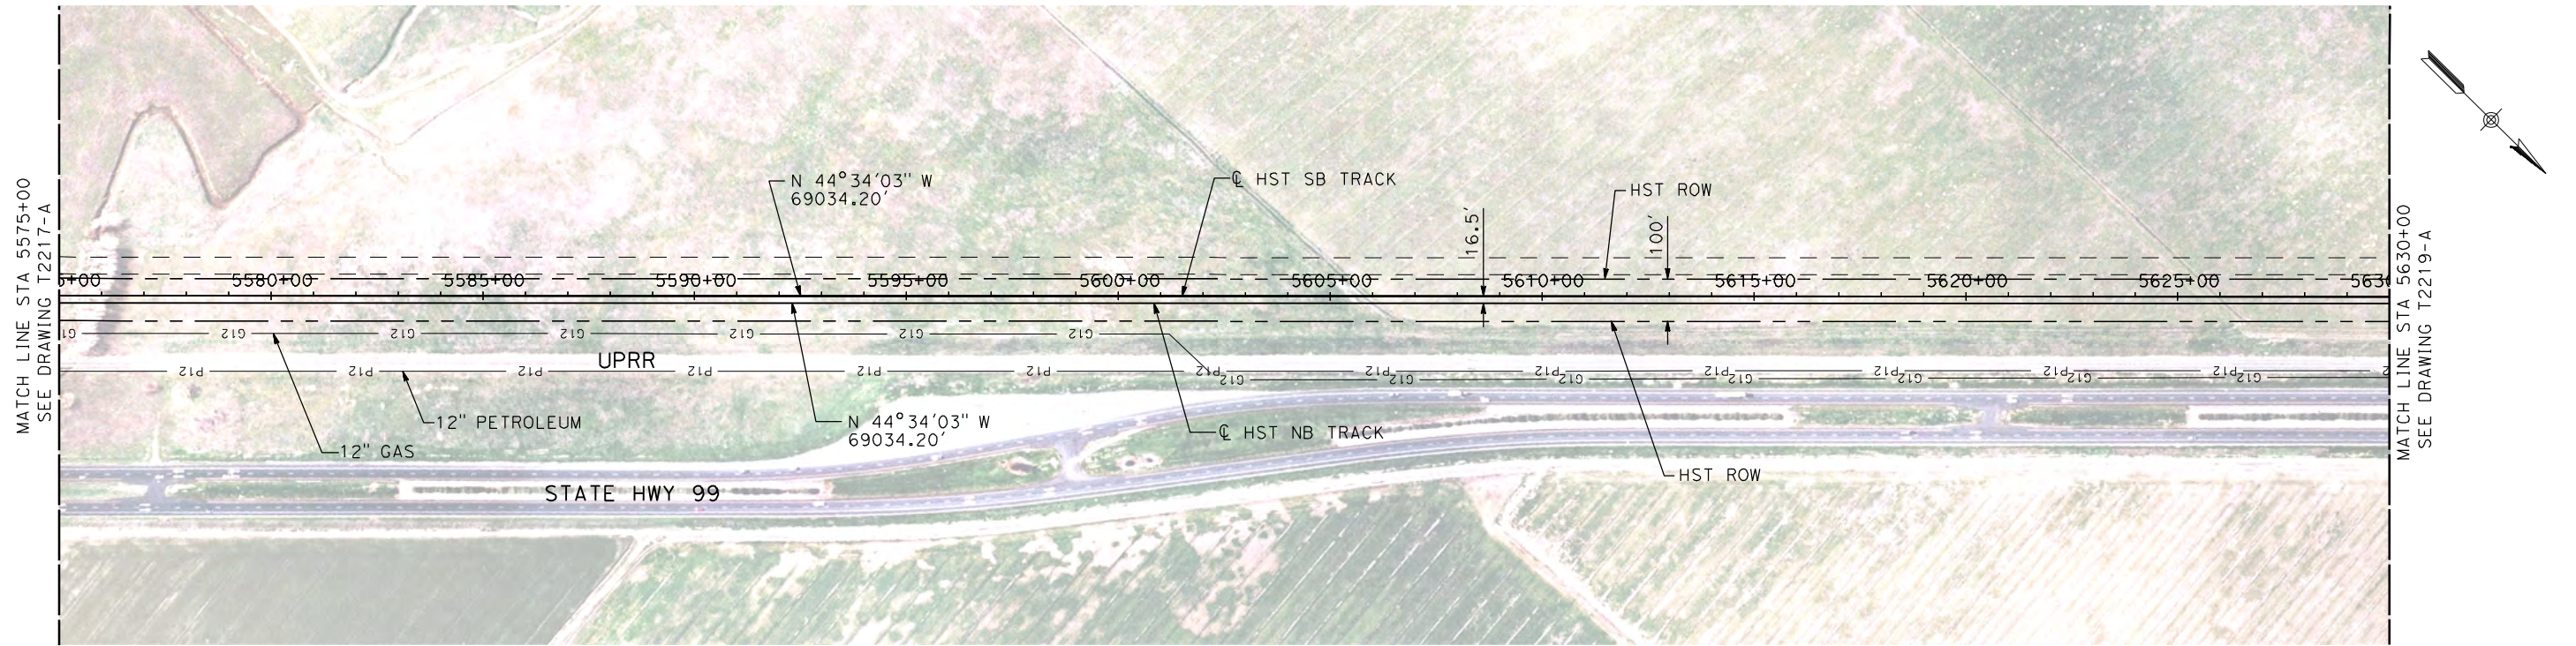
UPRR/SR 99 MERCED CONNECTION

PLAN AND PROFILE  
STA 5520+00 TO STA 5575+00

CONTRACT NO.  
HSR06-007  
DRAWING NO.  
T2217-A  
SCALE  
AS SHOWN  
SHEET NO.  
### OF ###



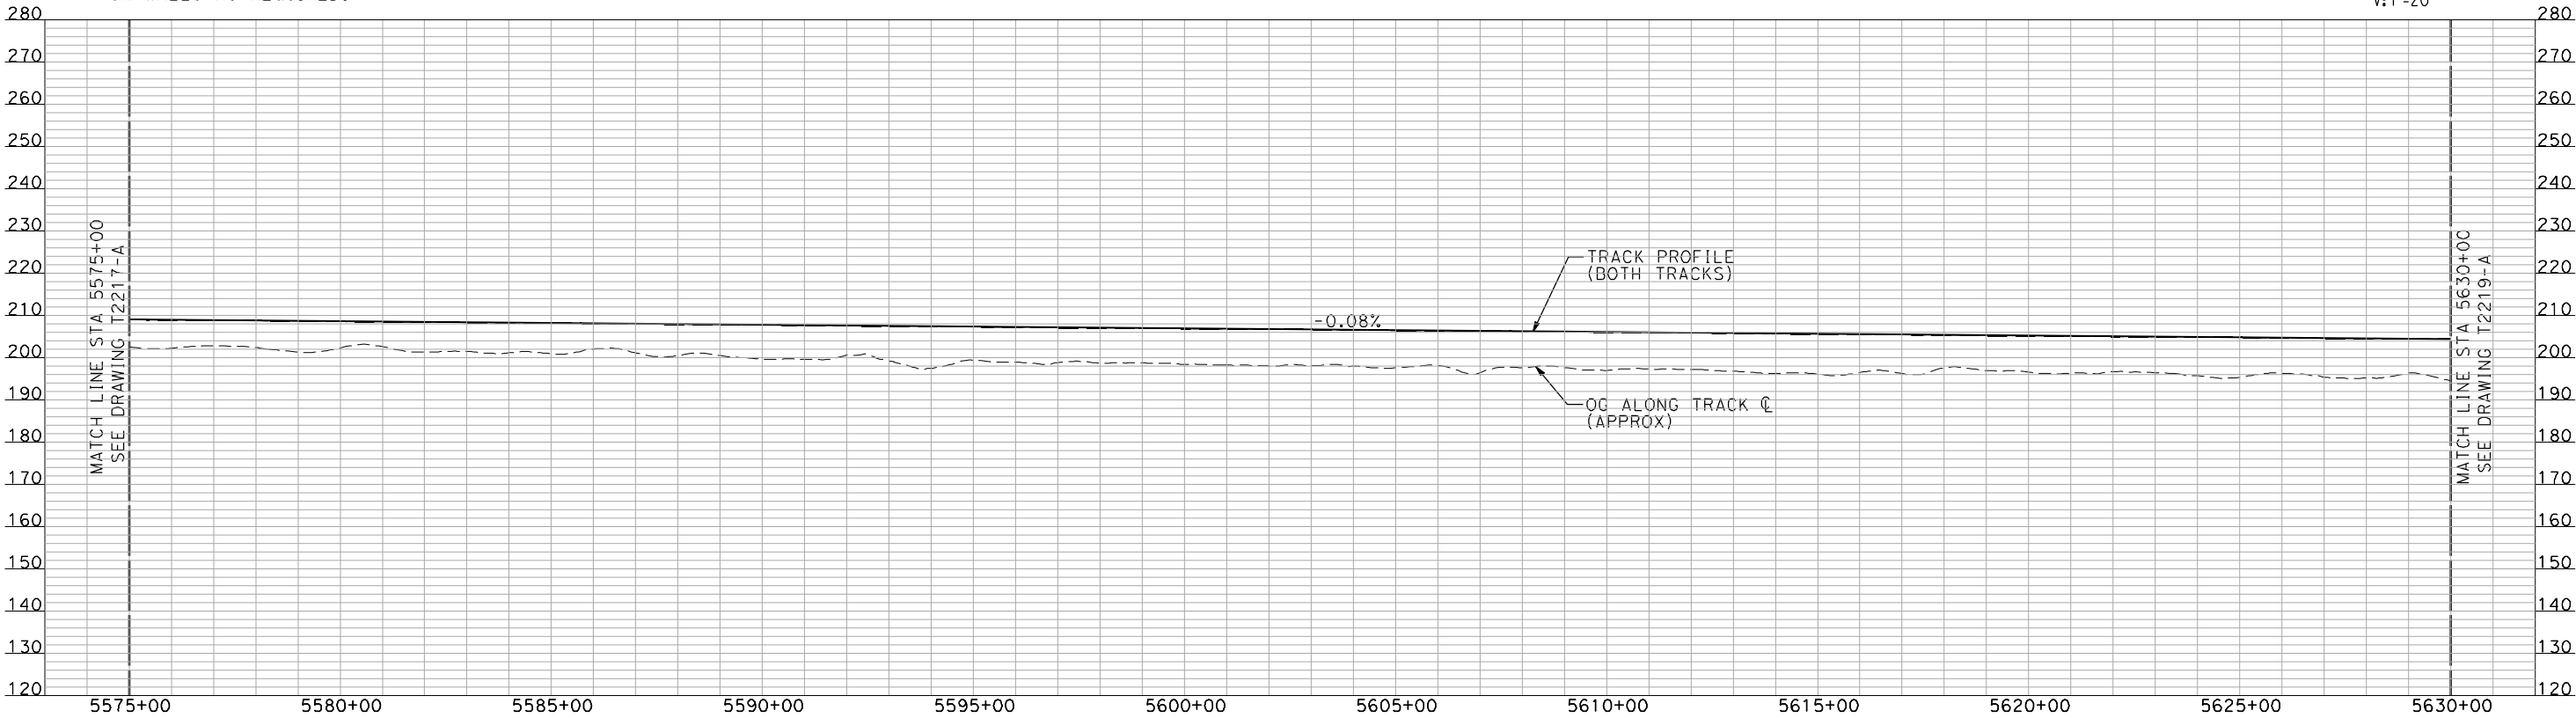
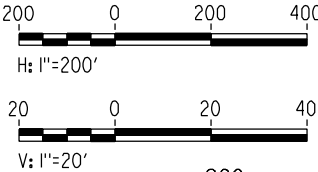
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NOTES:

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PLAN



PROFILE

"SEE T3000-T3017 DRAWINGS FOR  
TYPICAL SECTION LIMITS AND DETAILS"

REV	DATE	BY	CHK	APP	DESCRIPTION

DESIGNED BY  
A. SHIELDS  
DRAWN BY  
H. SULLIVAN  
CHECKED BY  
A. BOONE  
IN CHARGE  
A. BOONE  
DATE  
07/20/2011

RECORD SET  
15% DESIGN  
SUBMITTAL  
  
NOT FOR  
CONSTRUCTION

**AECOM**  
Technical Services, Inc.  
2020 L Street, Suite 300  
Sacramento, CA 95811  
**CH2MHILL**



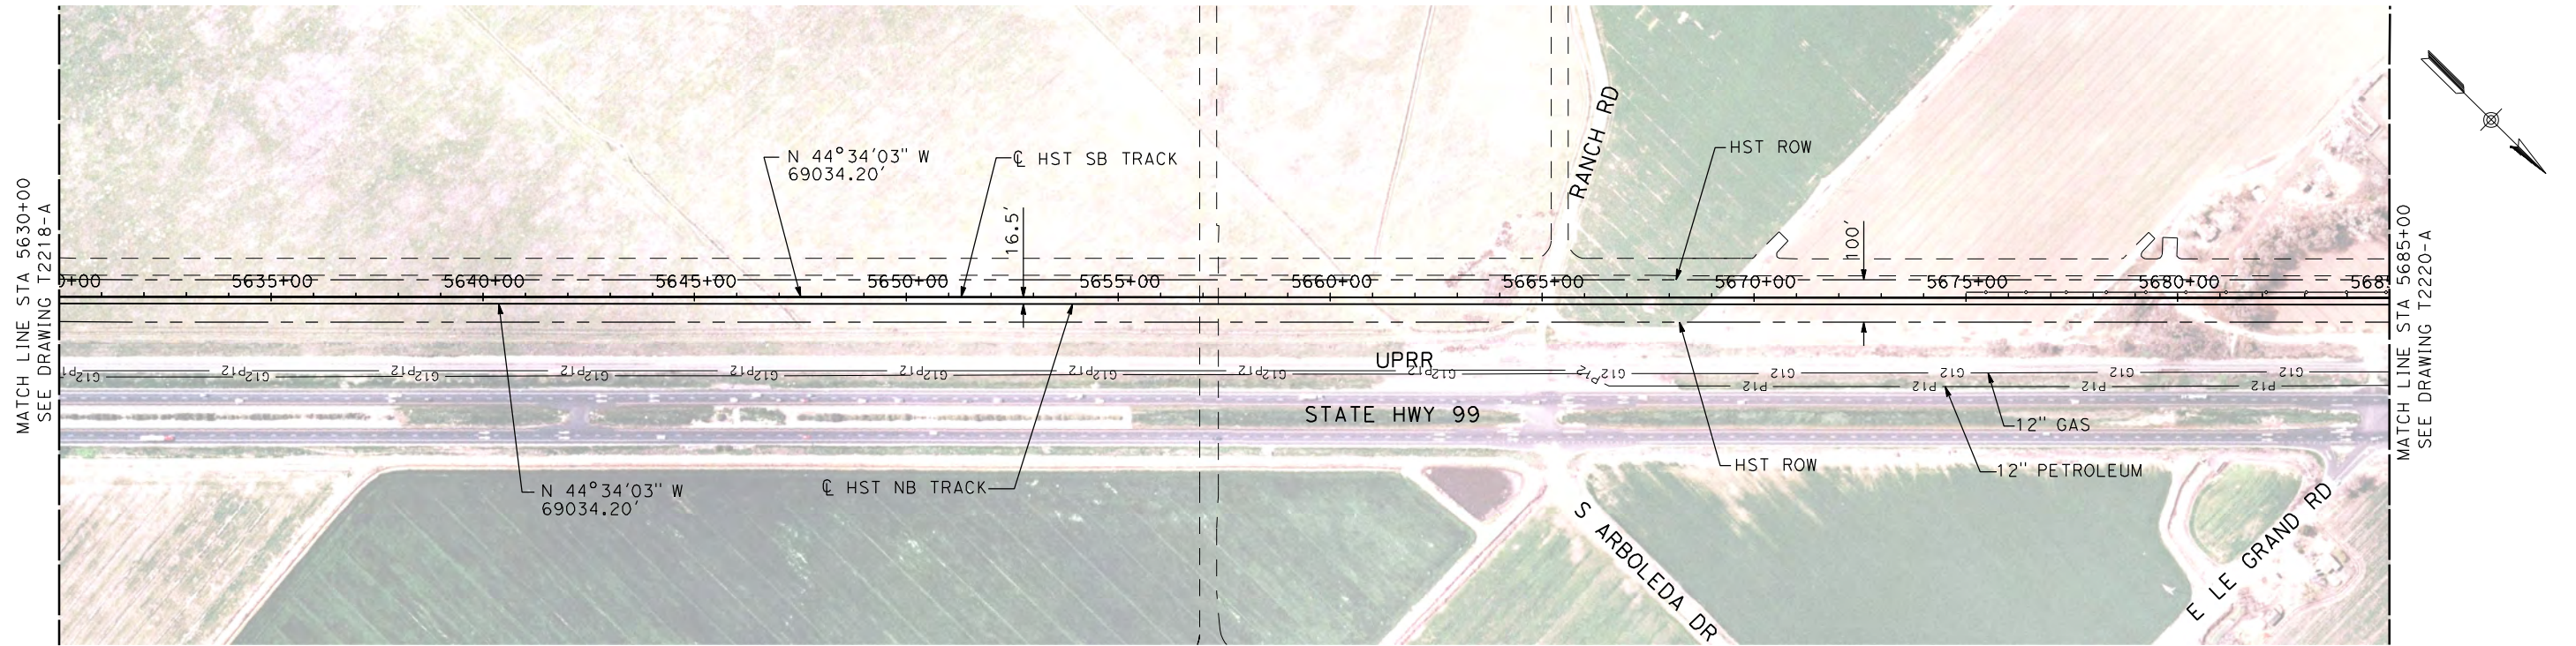
**CALIFORNIA HIGH-SPEED TRAIN PROJECT  
MERCED TO FRESNO**  
UPRR/SR 99 MERCED CONNECTION  
  
PLAN AND PROFILE  
STA 5575+00 TO STA 5630+00

CONTRACT NO.  
HSR06-007  
DRAWING NO.  
T2218-A  
SCALE  
AS SHOWN  
SHEET NO.  
### OF ###



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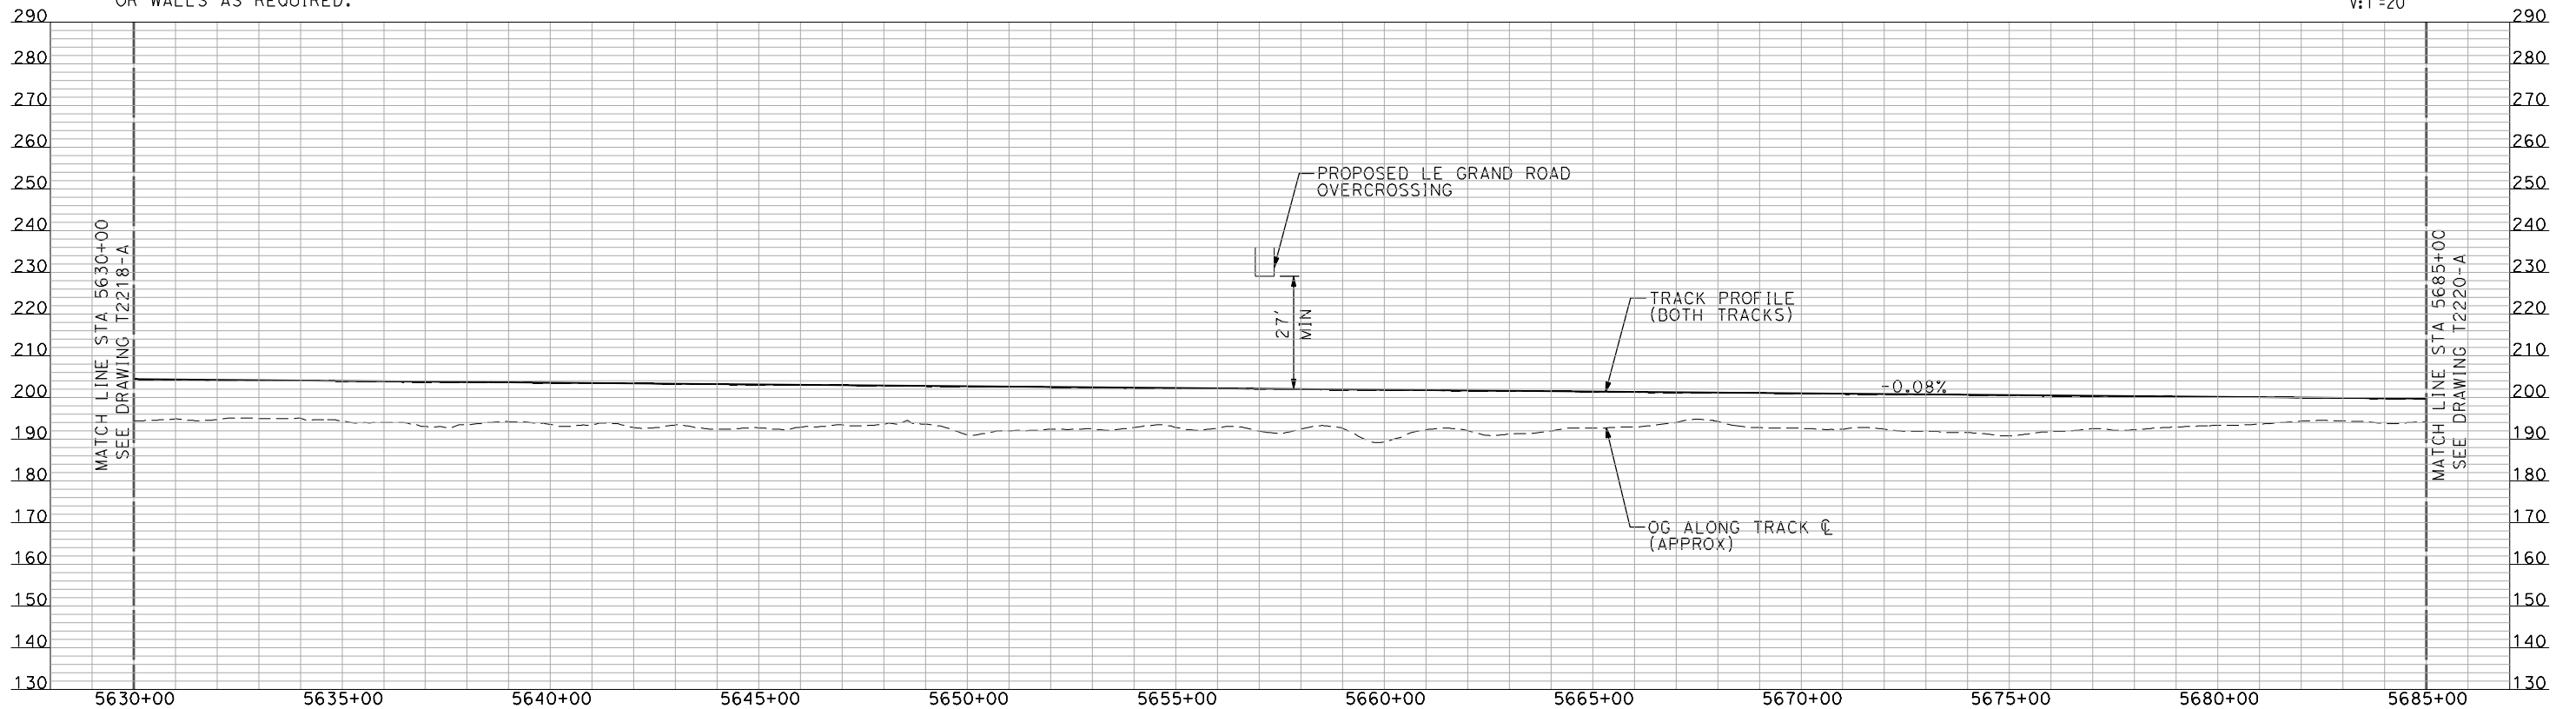
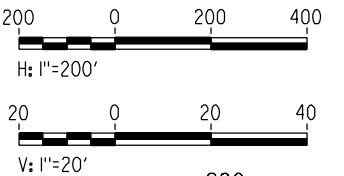
SullivanH



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PLAN



PROFILE

"SEE T3000-T3017 DRAWINGS FOR  
TYPICAL SECTION LIMITS AND DETAILS"

REV	DATE	BY	CHK	APP	DESCRIPTION

DESIGNED BY A. SHIELDS
DRAWN BY H. SULLIVAN
CHECKED BY A. BOONE
IN CHARGE A. BOONE
DATE 07/20/2011

RECORD SET  
15% DESIGN  
SUBMITTAL

NOT FOR  
CONSTRUCTION

**AECOM**  
Technical Services, Inc.  
2020 L Street, Suite 300  
Sacramento, CA 95811

**CH2M HILL**



**CALIFORNIA**  
HIGH-SPEED RAIL AUTHORITY

**CALIFORNIA HIGH-SPEED TRAIN PROJECT  
MERCED TO FRESNO**

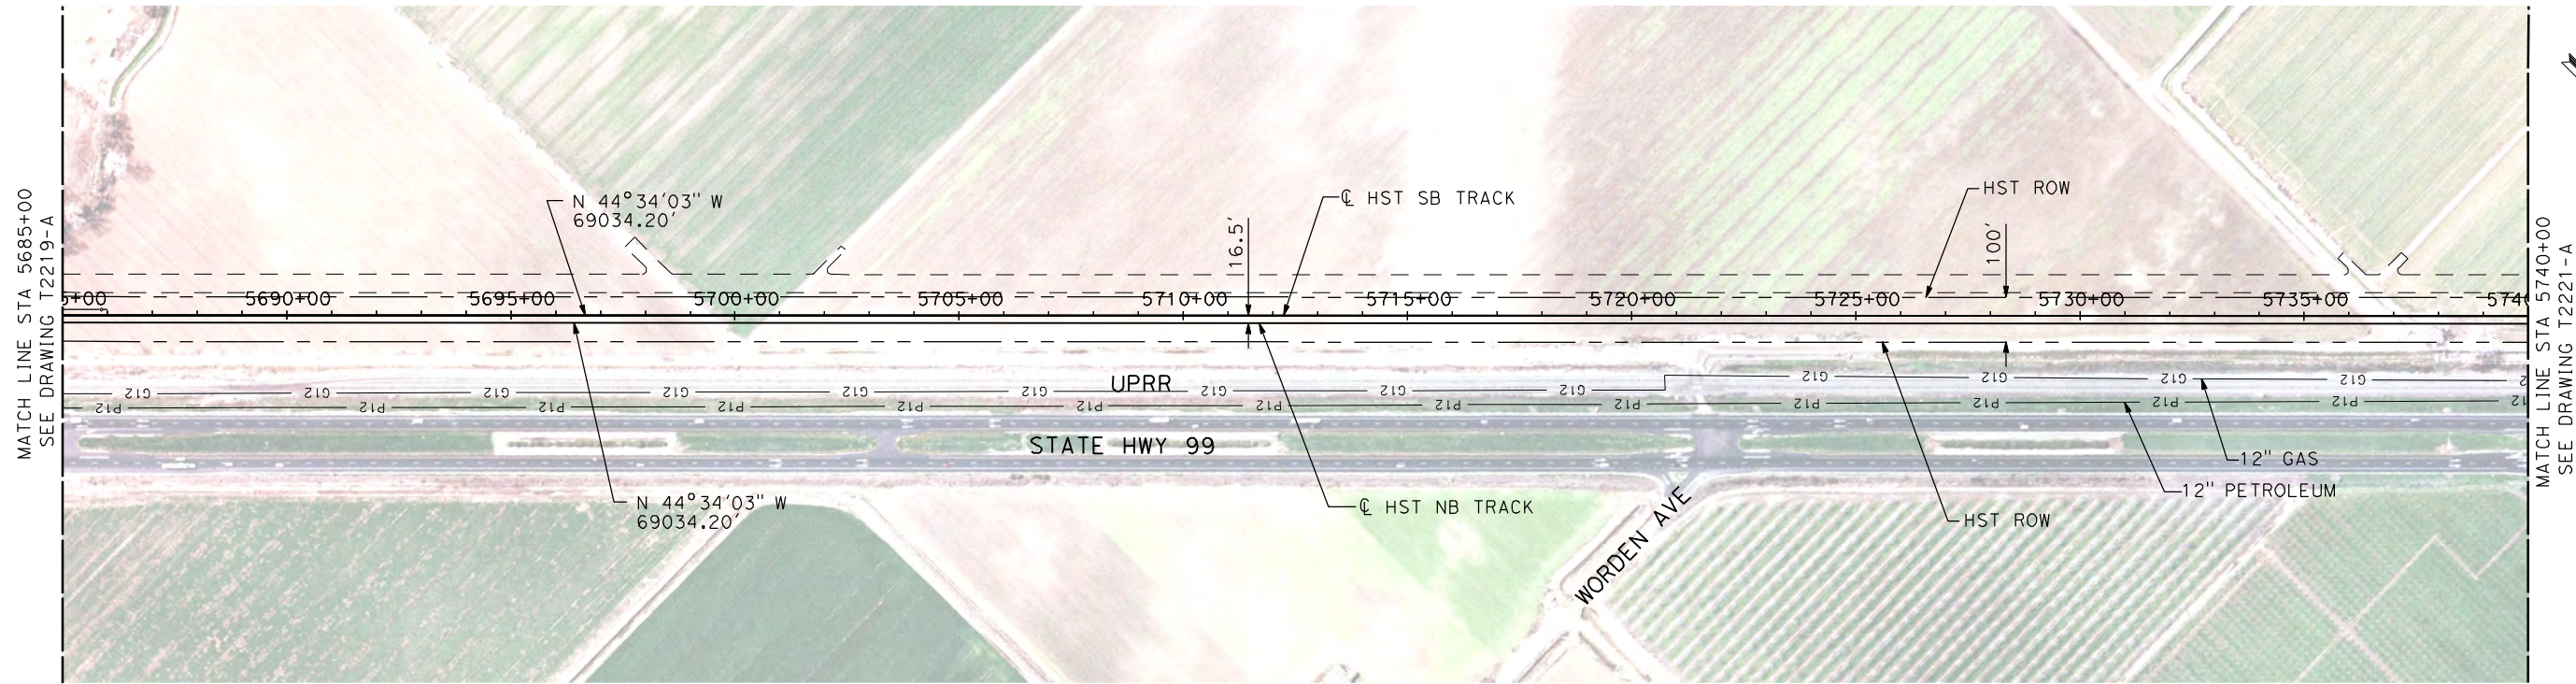
UPRR/SR 99 MERCED CONNECTION

PLAN AND PROFILE  
STA 5630+00 TO STA 5685+00

CONTRACT NO. HSR06-007
DRAWING NO. T2219-A
SCALE AS SHOWN
SHEET NO. ### OF ###

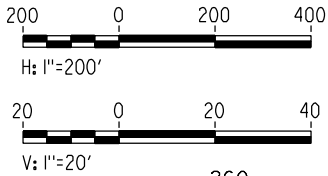


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PLAN



PROFILE

"SEE T3000-T3017 DRAWINGS FOR  
TYPICAL SECTION LIMITS AND DETAILS"

REV	DATE	BY	CHK	APP	DESCRIPTION

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DRAWN BY H. SULLIVAN
CHECKED BY A. BOONE
IN CHARGE A. BOONE
DATE 07/20/2011

RECORD SET  
15% DESIGN  
SUBMITTAL

NOT FOR  
CONSTRUCTION



CALIFORNIA  
HIGH-SPEED RAIL AUTHORITY

CALIFORNIA HIGH-SPEED TRAIN PROJECT  
MERCED TO FRESNO

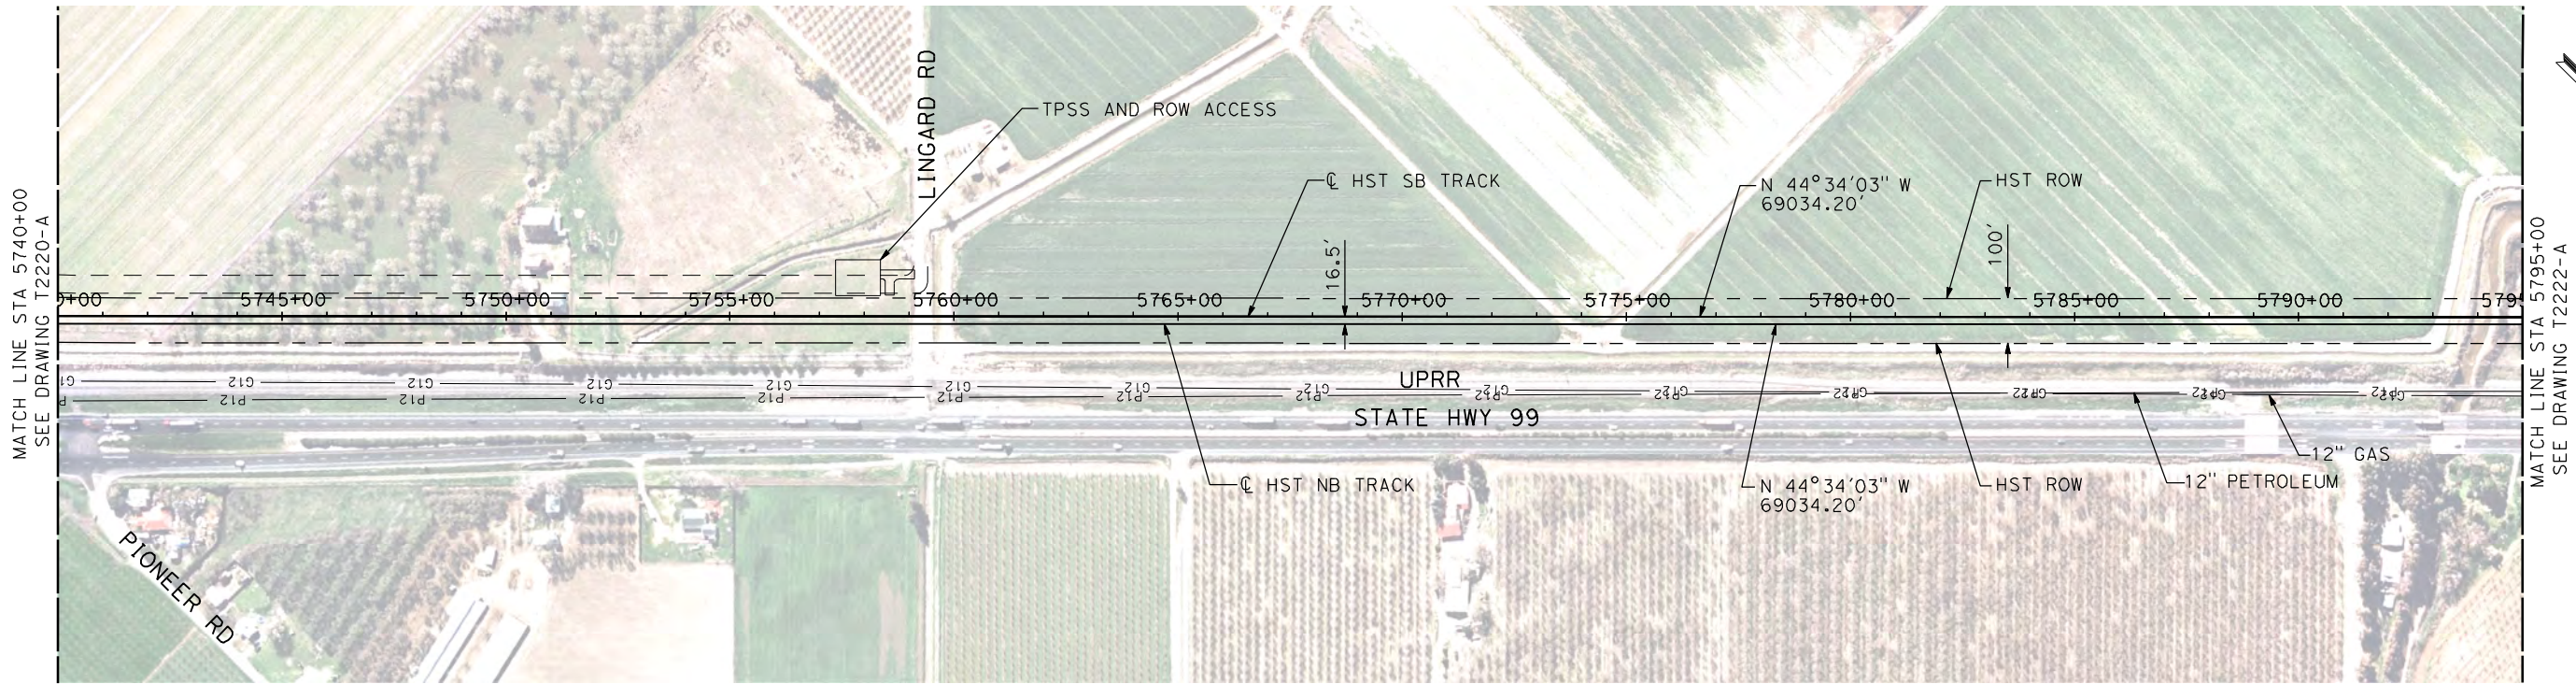
UPRR/SR 99 MERCED CONNECTION

PLAN AND PROFILE  
STA 5685+00 TO STA 5740+00

CONTRACT NO. HSR06-007
DRAWING NO. T2220-A
SCALE AS SHOWN
SHEET NO. ### OF ###



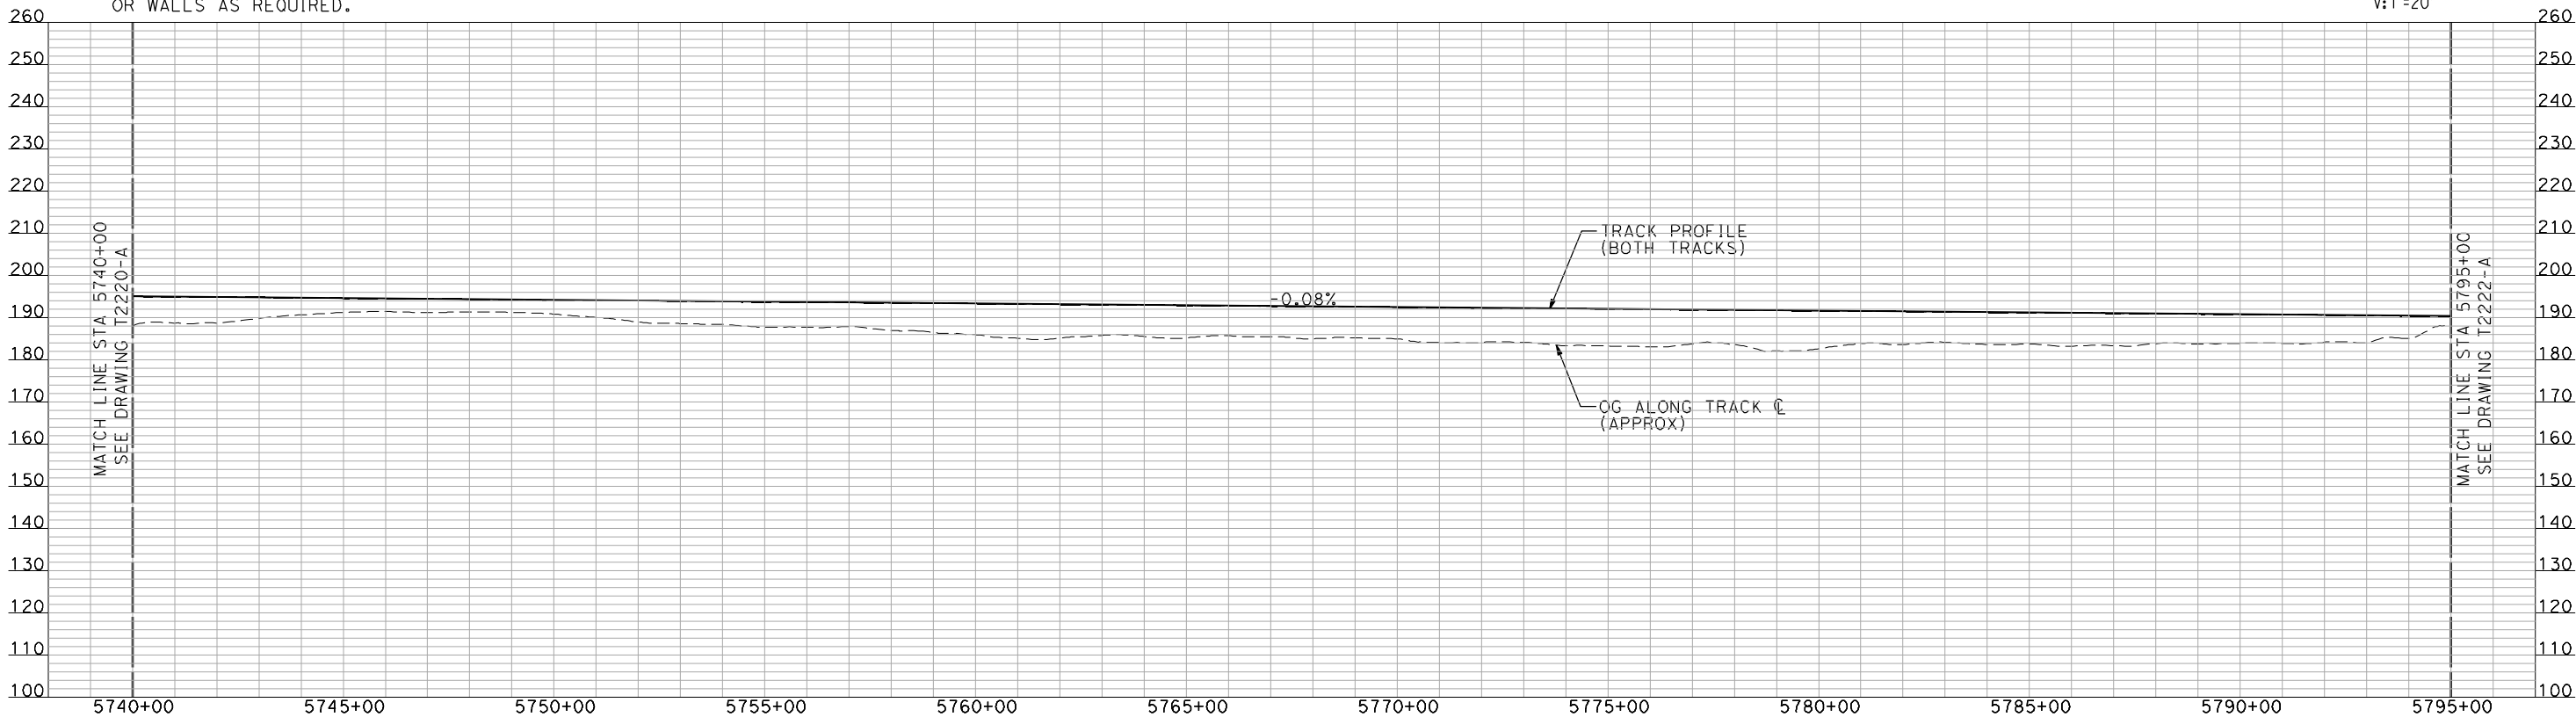
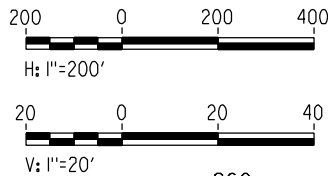
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NOTES:

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PLAN



PROFILE

"SEE T3000-T3017 DRAWINGS FOR  
TYPICAL SECTION LIMITS AND DETAILS"

REV	DATE	BY	CHK	APP	DESCRIPTION

DESIGNED BY  
A. SHIELDS  
DRAWN BY  
H. SULLIVAN  
CHECKED BY  
A. BOONE  
IN CHARGE  
A. BOONE  
DATE  
07/20/2011

RECORD SET  
15% DESIGN  
SUBMITTAL

NOT FOR  
CONSTRUCTION

**AECOM**  
Technical Services, Inc.  
2020 L Street, Suite 300  
Sacramento, CA 95811  
**CH2M HILL**



**CALIFORNIA**  
HIGH-SPEED RAIL AUTHORITY

**CALIFORNIA HIGH-SPEED TRAIN PROJECT  
MERCED TO FRESNO**

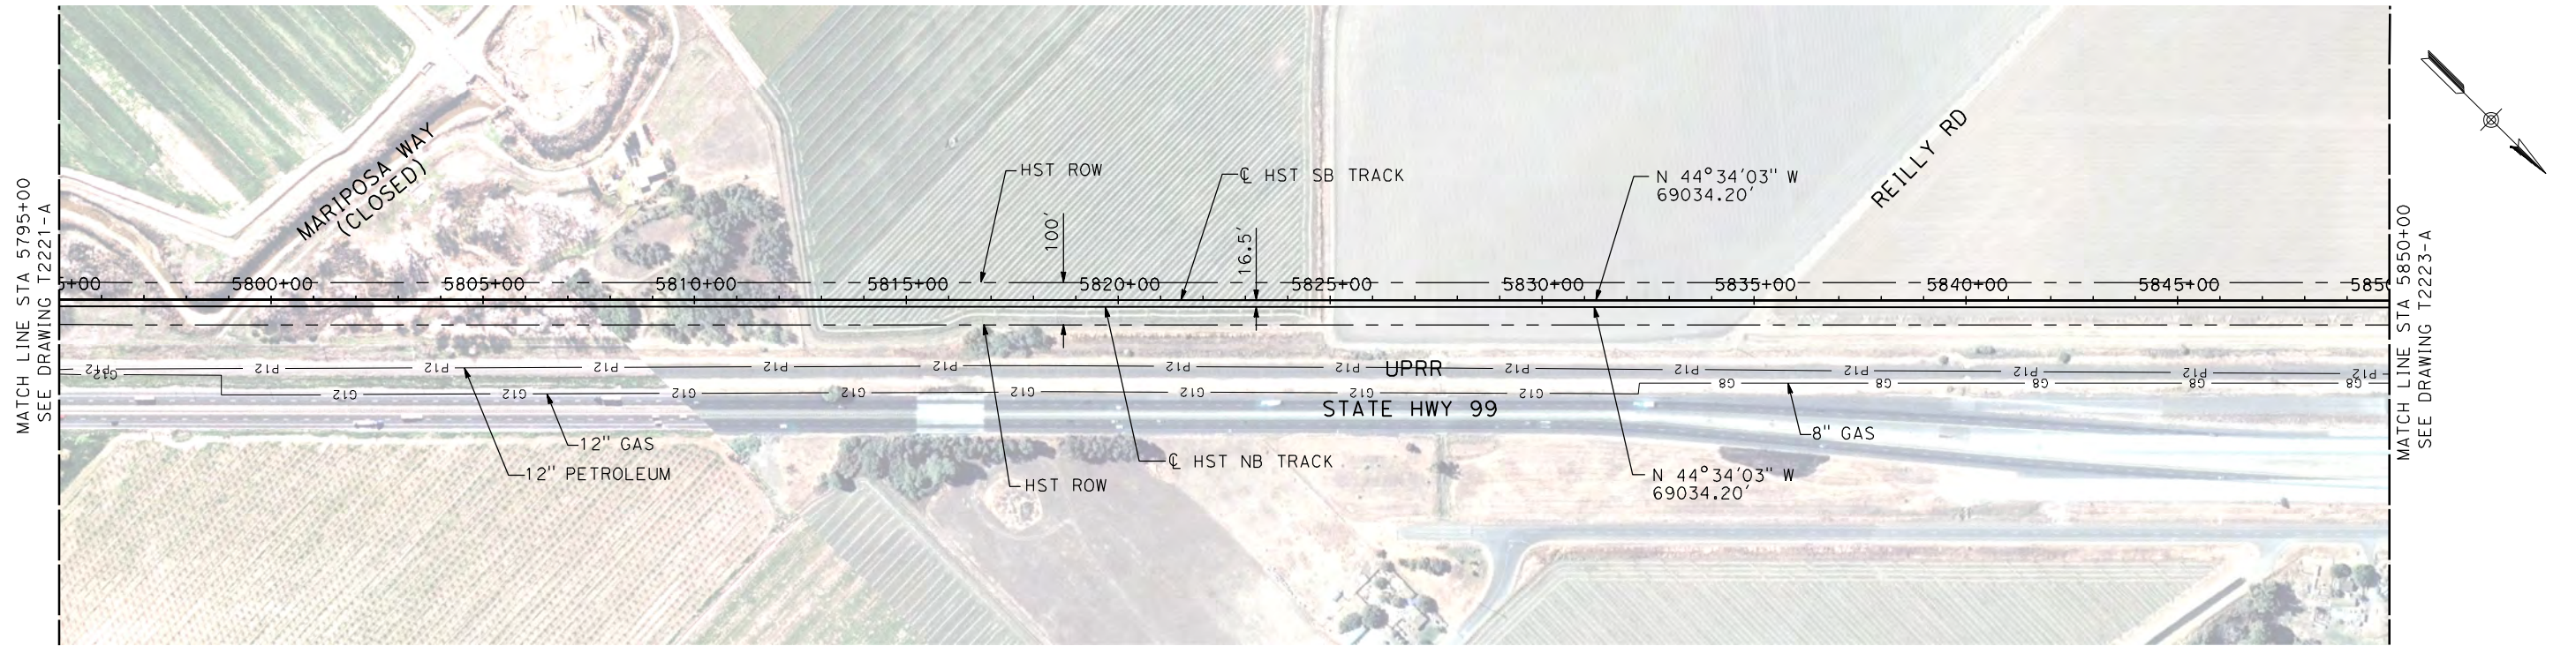
UPRR/SR 99 MERCED CONNECTION

PLAN AND PROFILE  
STA 5740+00 TO STA 5795+00

CONTRACT NO.  
HSR06-007  
DRAWING NO.  
T2221-A  
SCALE  
AS SHOWN  
SHEET NO.  
### OF ###



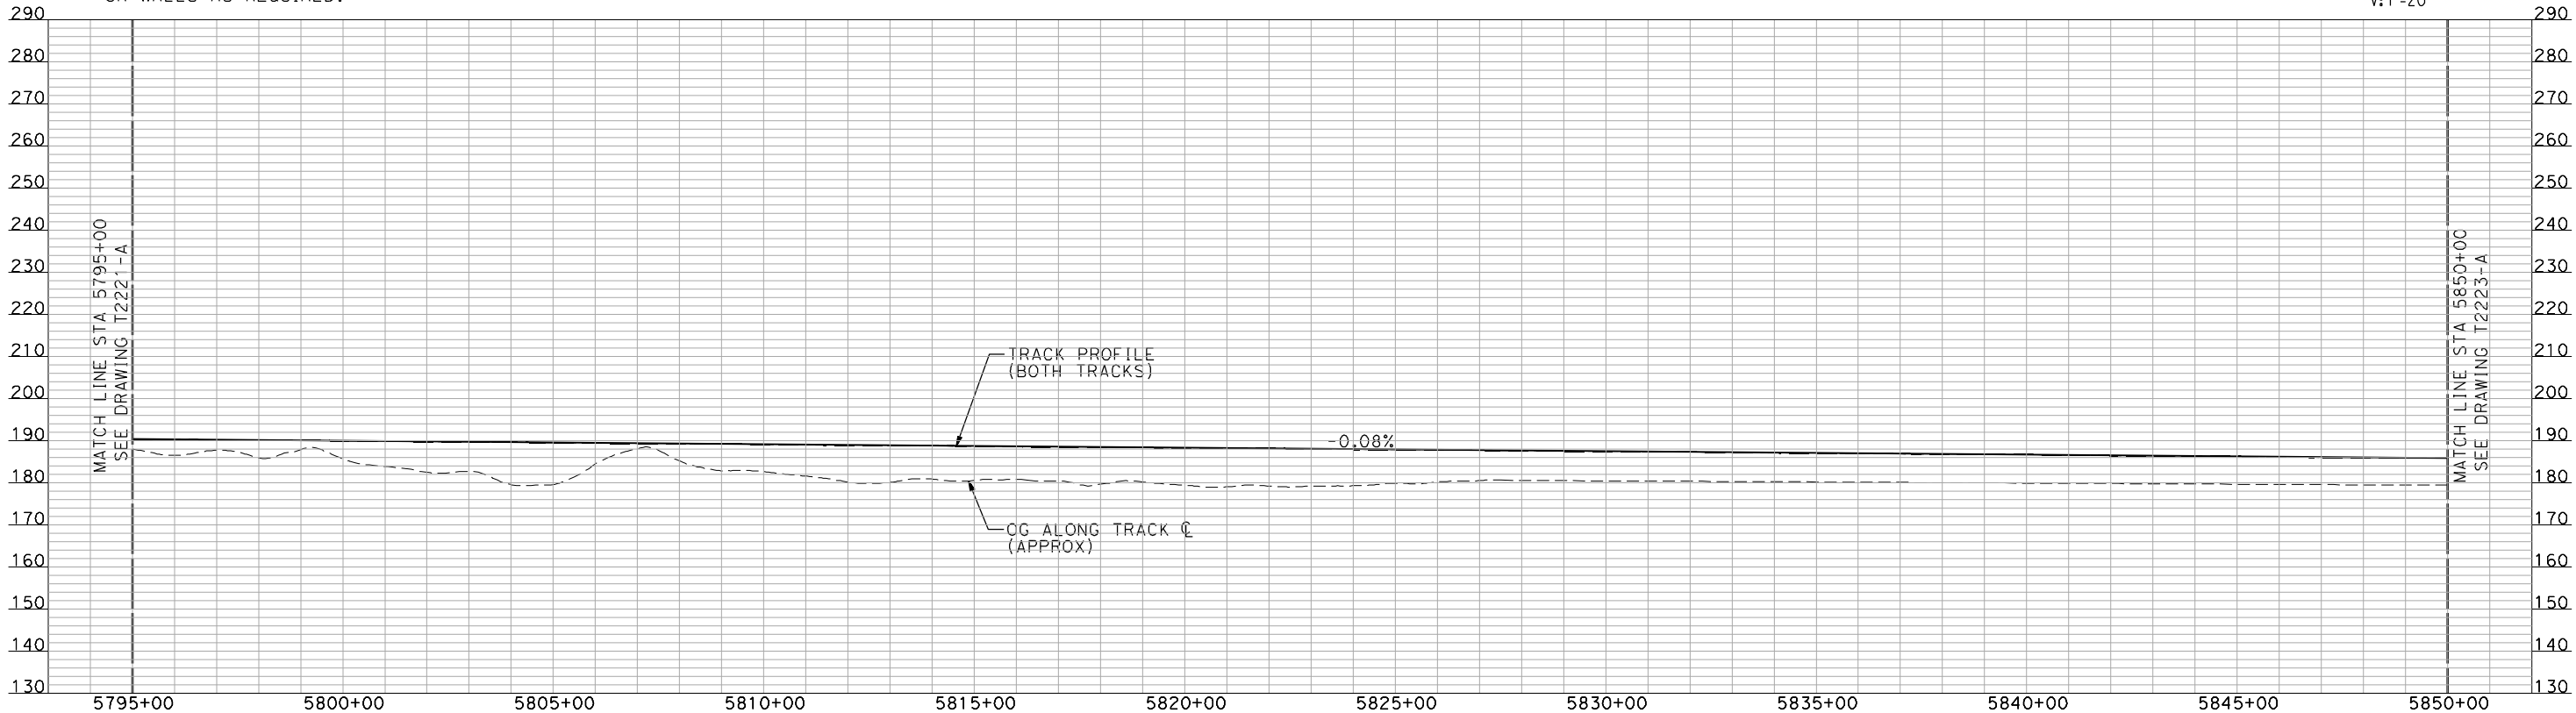
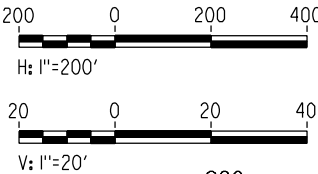
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NOTES:

1. ALL UTILITIES SHOWN ARE EXISTING UTILITY LINES BASED ON RECORD DRAWINGS AND ARE SHOWN FOR INFORMATIONAL PURPOSES ONLY.
2. TRACKS CLOSER THAN 102 FT TO THE NEAREST EXISTING FREIGHT TRACKS WILL INCLUDE SAFETY BARRIERS, BERMS, OR WALLS AS REQUIRED.

PLAN



PROFILE

"SEE T3000-T3017 DRAWINGS FOR  
TYPICAL SECTION LIMITS AND DETAILS"

REV	DATE	BY	CHK	APP	DESCRIPTION

DESIGNED BY  
A. SHIELDS  
DRAWN BY  
H. SULLIVAN  
CHECKED BY  
A. BOONE  
IN CHARGE  
A. BOONE  
DATE  
07/20/2011

RECORD SET  
15% DESIGN  
SUBMITTAL

NOT FOR  
CONSTRUCTION

**AECOM**  
Technical Services, Inc.  
2020 L Street, Suite 300  
Sacramento, CA 95811  
**CH2M HILL**



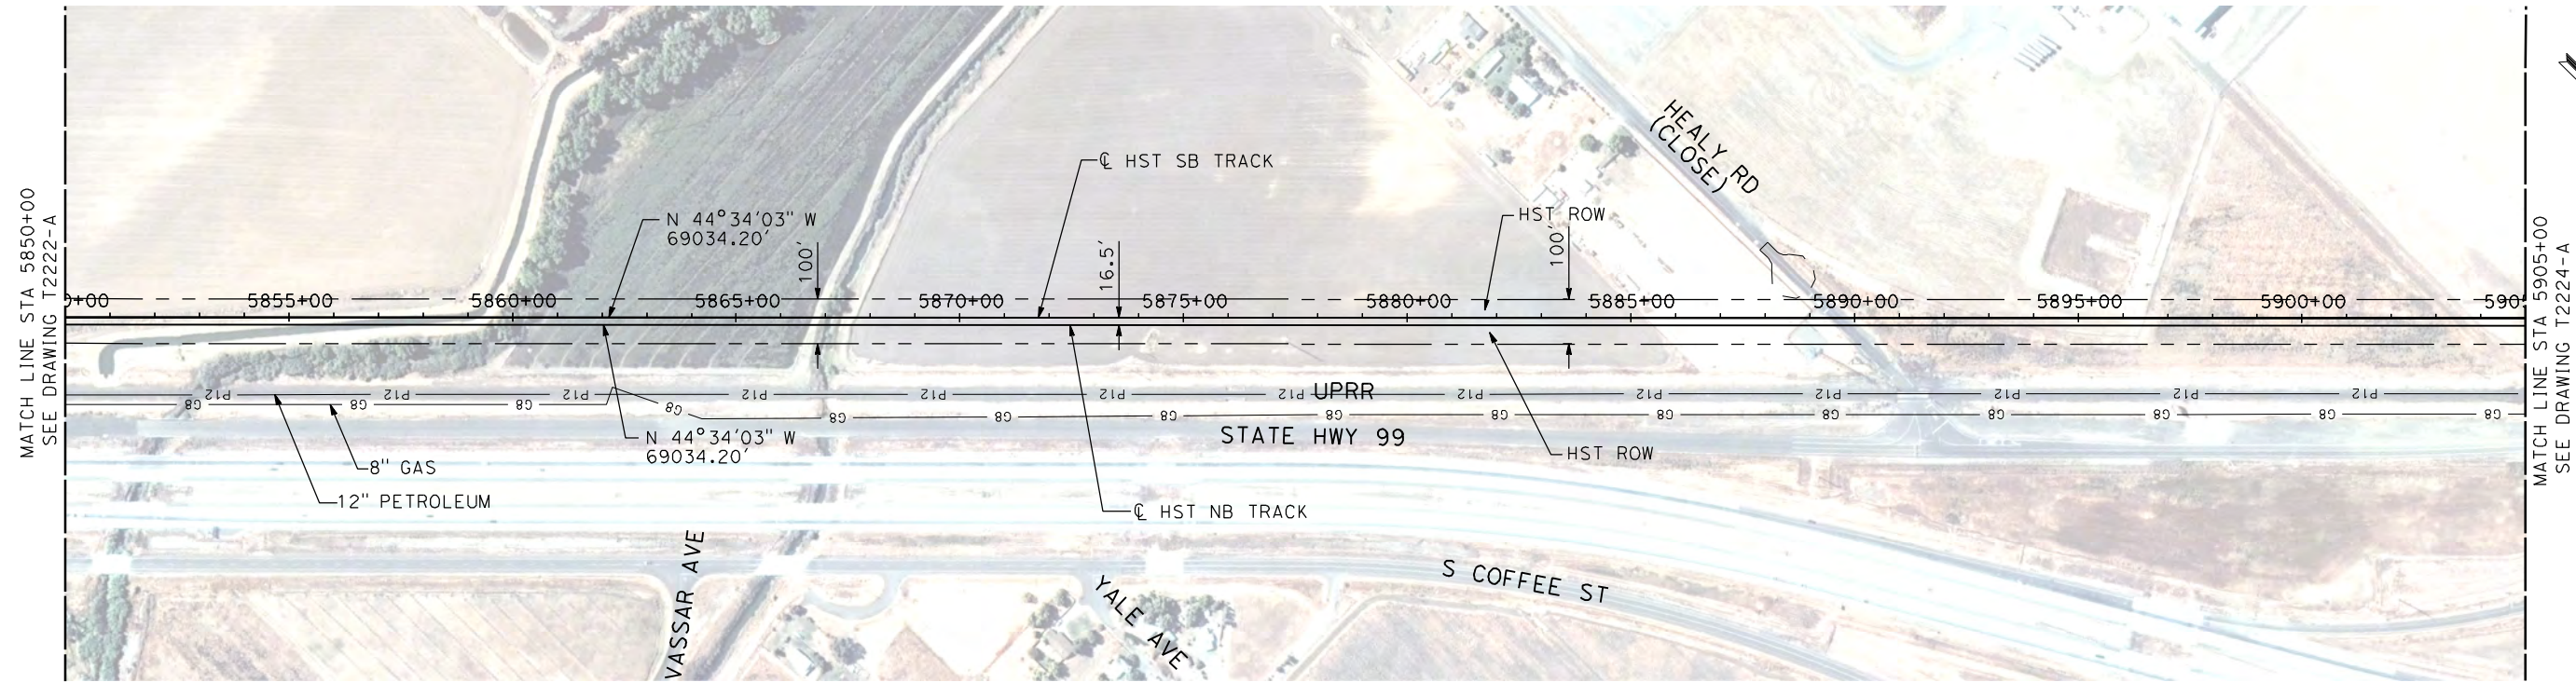
**CALIFORNIA HIGH-SPEED TRAIN PROJECT  
MERCED TO FRESNO**

UPRR/SR 99 MERCED CONNECTION

PLAN AND PROFILE  
STA 5795+00 TO STA 5850+00

CONTRACT NO.  
HSR06-007  
DRAWING NO.  
T2222-A  
SCALE  
AS SHOWN  
SHEET NO.  
### OF ###

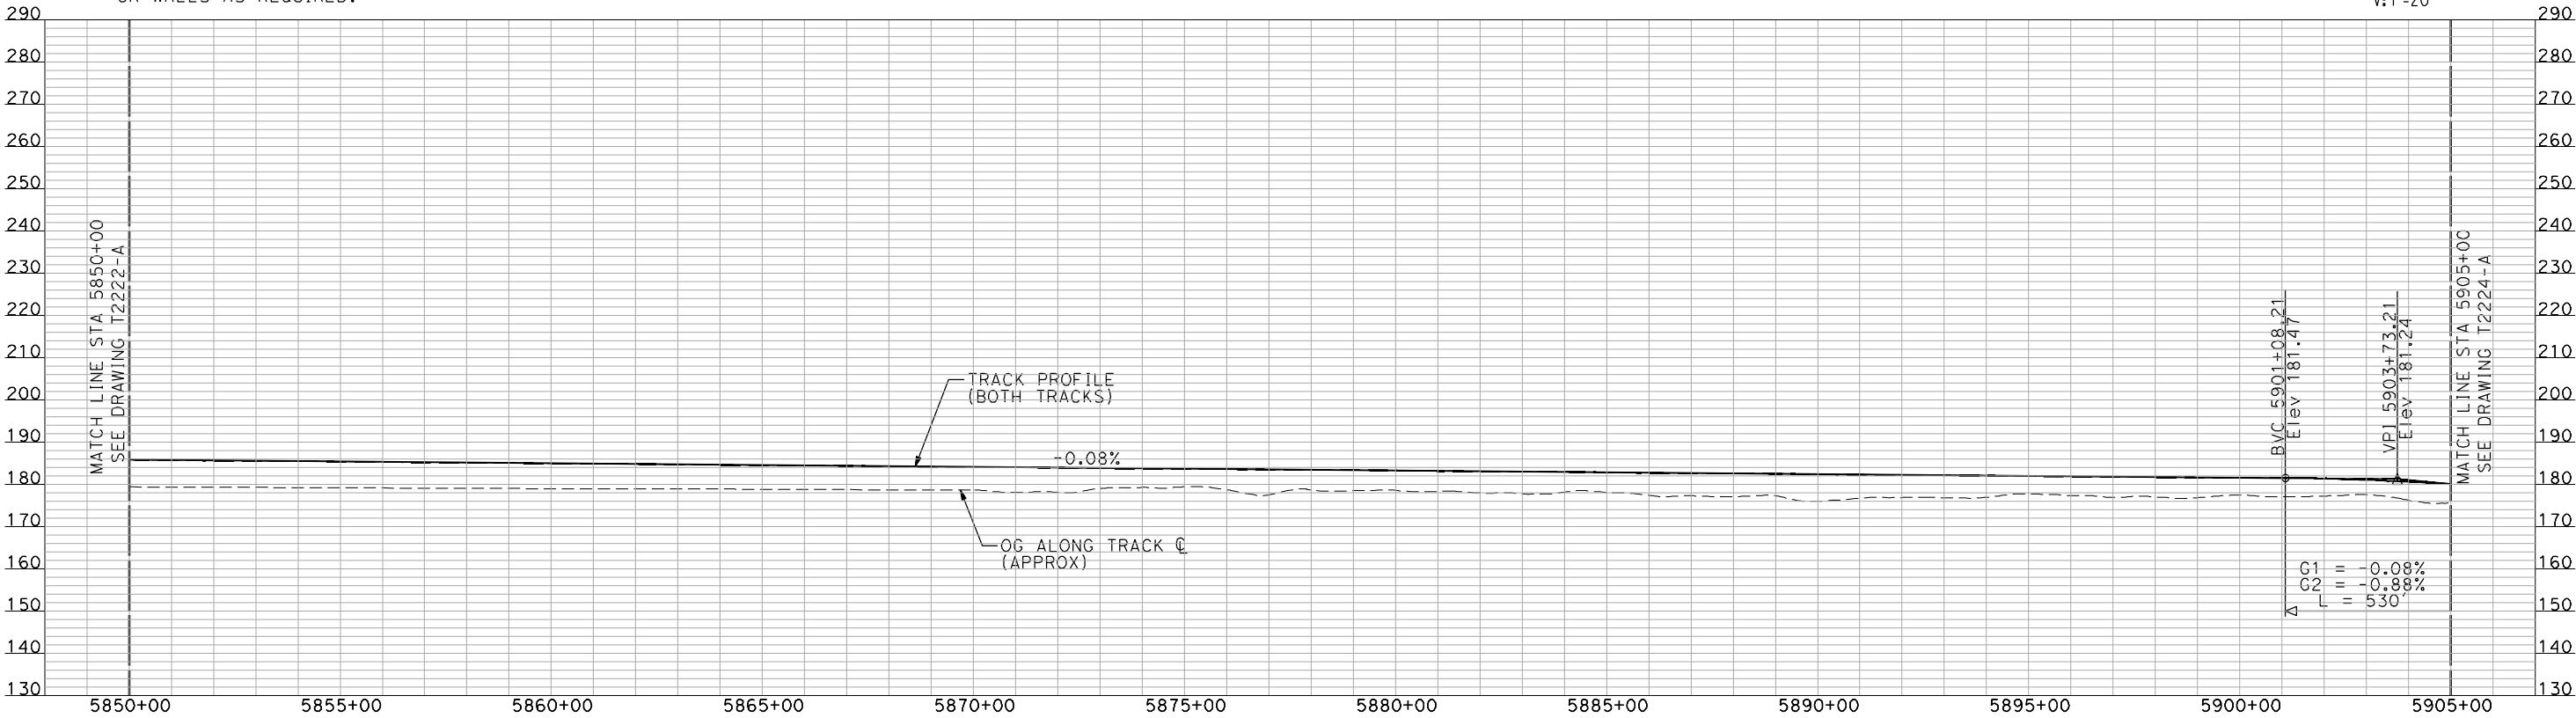
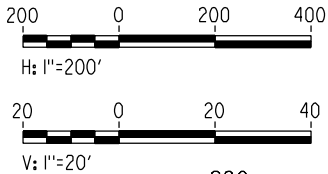




NOTES:

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- 2. TRACKS CLOSER THAN 102 FT TO THE NEAREST EXISTING FREIGHT TRACKS WILL INCLUDE SAFETY BARRIERS, BERMS, OR WALLS AS REQUIRED.

PLAN



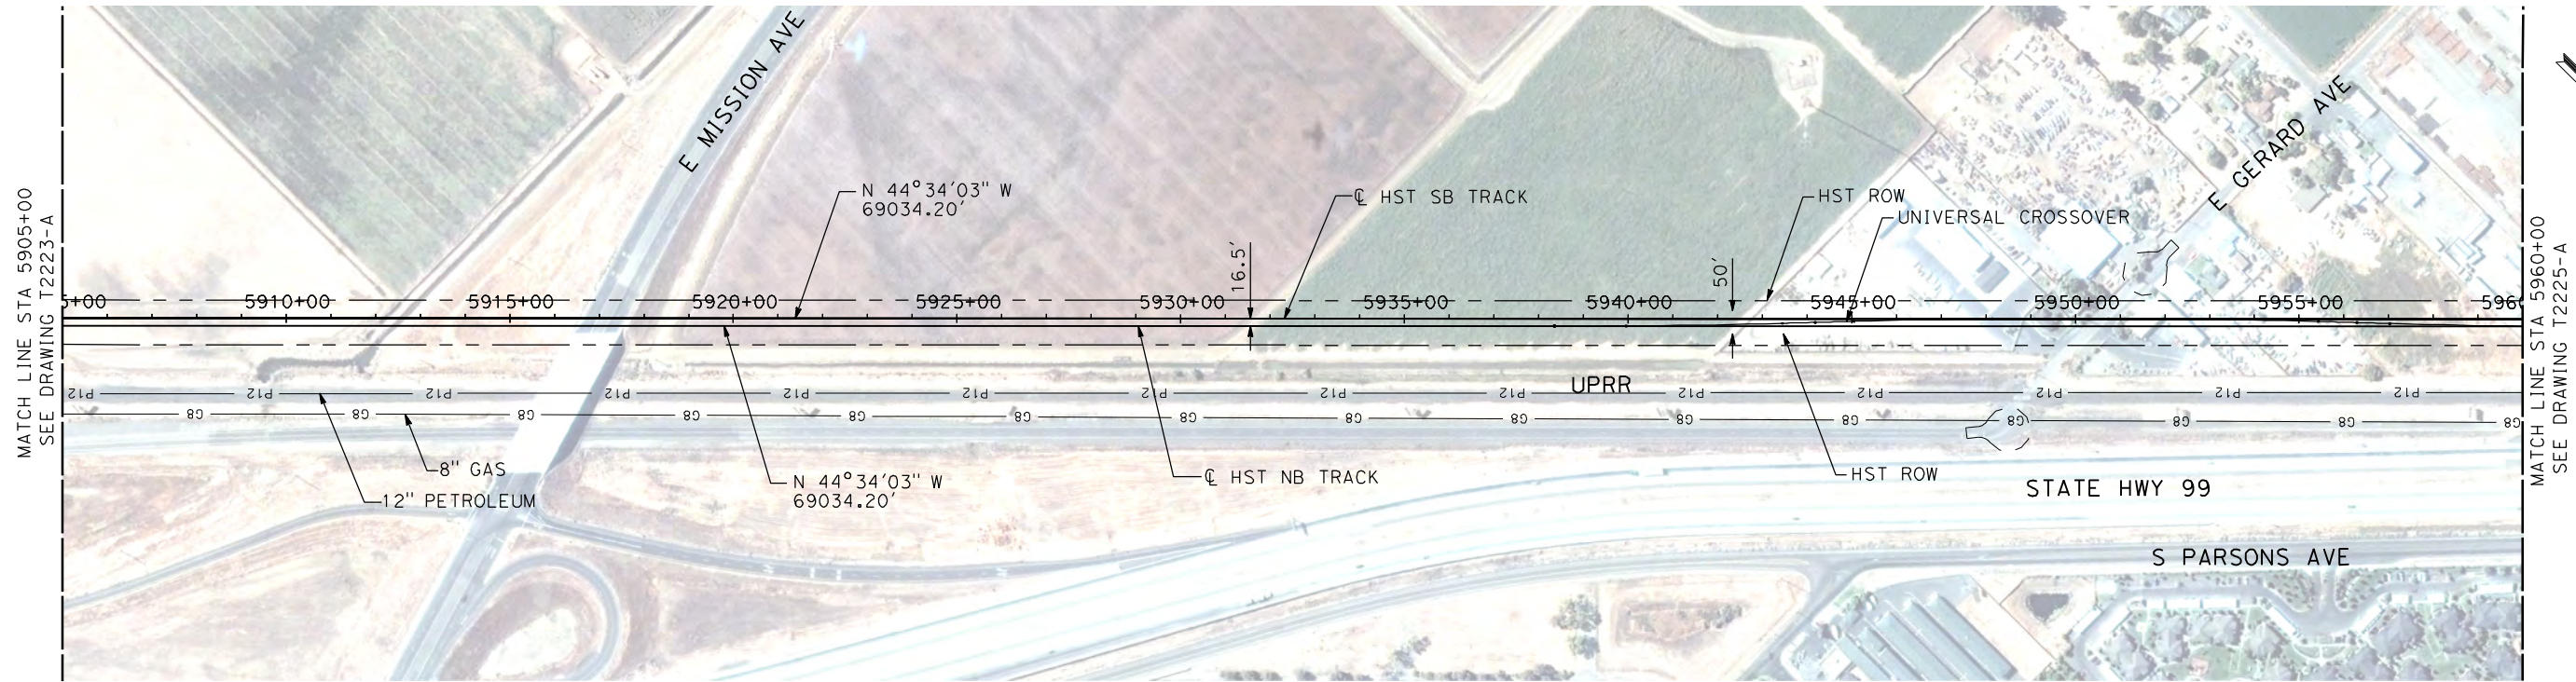
PROFILE

"SEE T3000-T3017 DRAWINGS FOR TYPICAL SECTION LIMITS AND DETAILS"

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REV	DATE	BY	CHK	APP	DESCRIPTION											



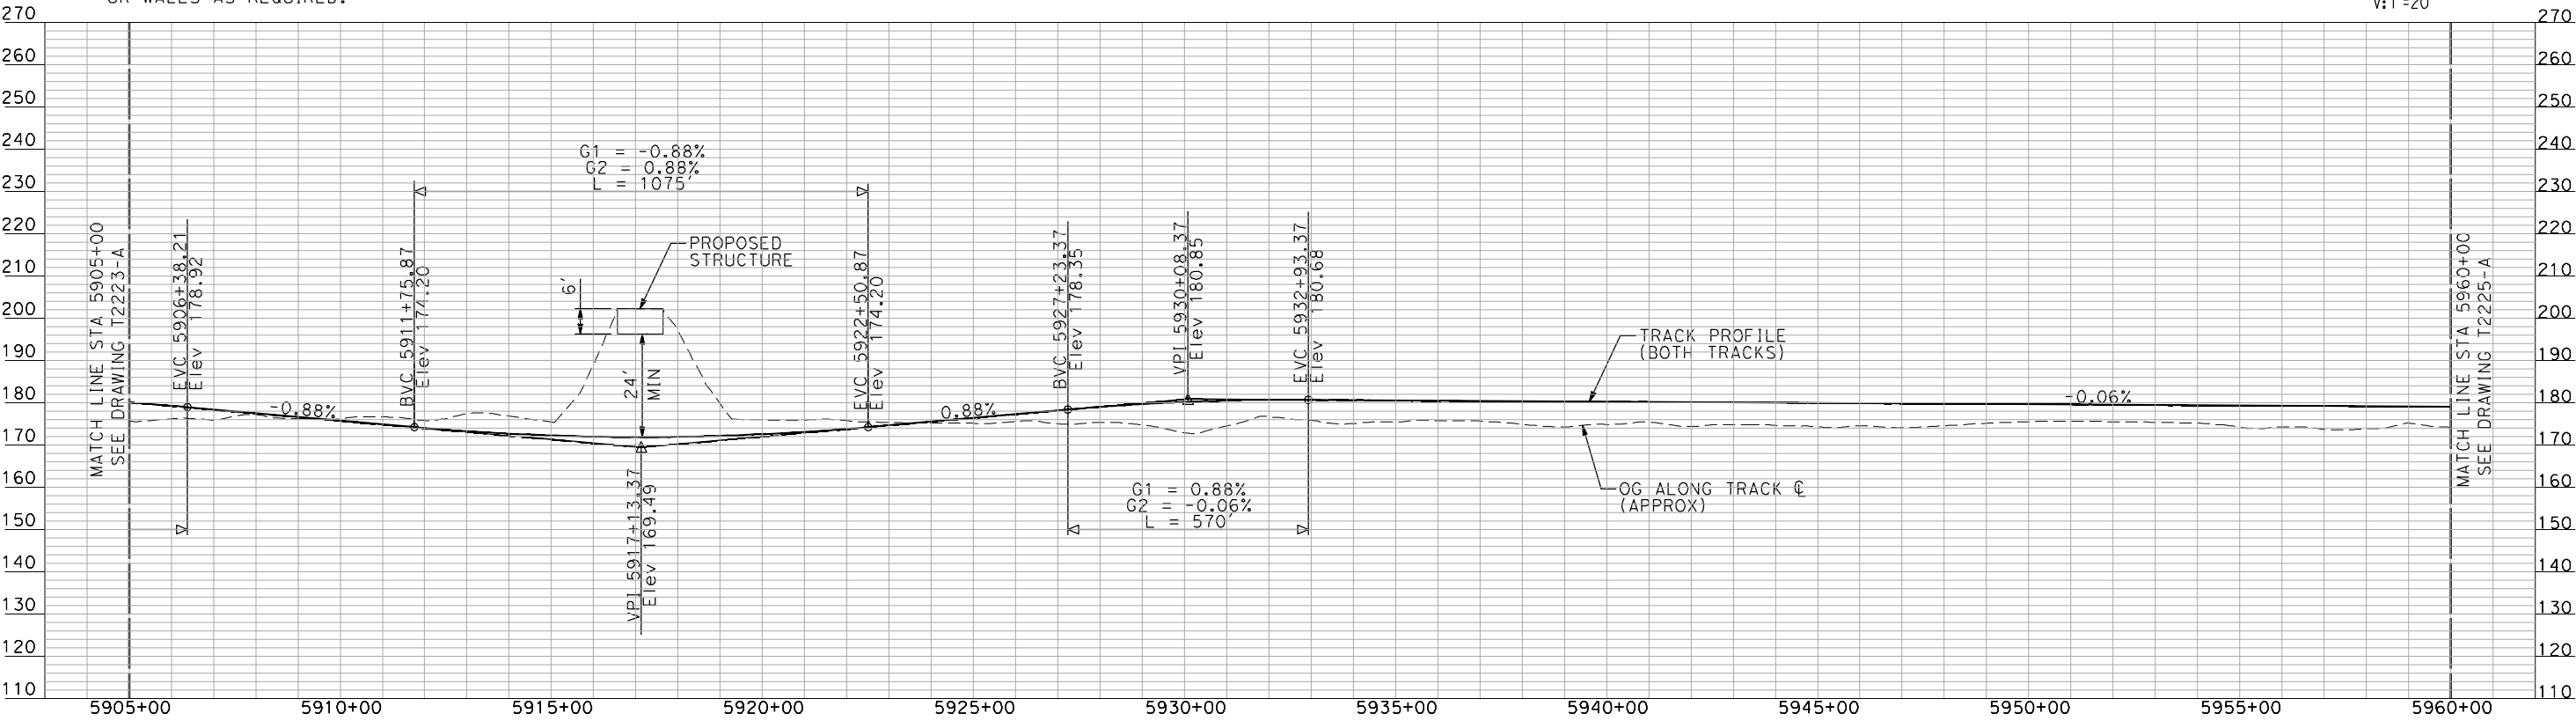
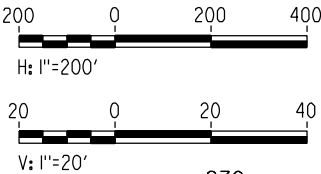
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NOTES:

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PLAN



PROFILE

"SEE T3000-T3017 DRAWINGS FOR  
TYPICAL SECTION LIMITS AND DETAILS"

REV	DATE	BY	CHK	APP	DESCRIPTION

DESIGNED BY A. SHIELDS
DRAWN BY H. SULLIVAN
CHECKED BY A. BOONE
IN CHARGE A. BOONE
DATE 07/20/2011

RECORD SET  
15% DESIGN  
SUBMITTAL

NOT FOR  
CONSTRUCTION



CALIFORNIA  
HIGH-SPEED RAIL AUTHORITY

CALIFORNIA HIGH-SPEED TRAIN PROJECT  
MERCED TO FRESNO

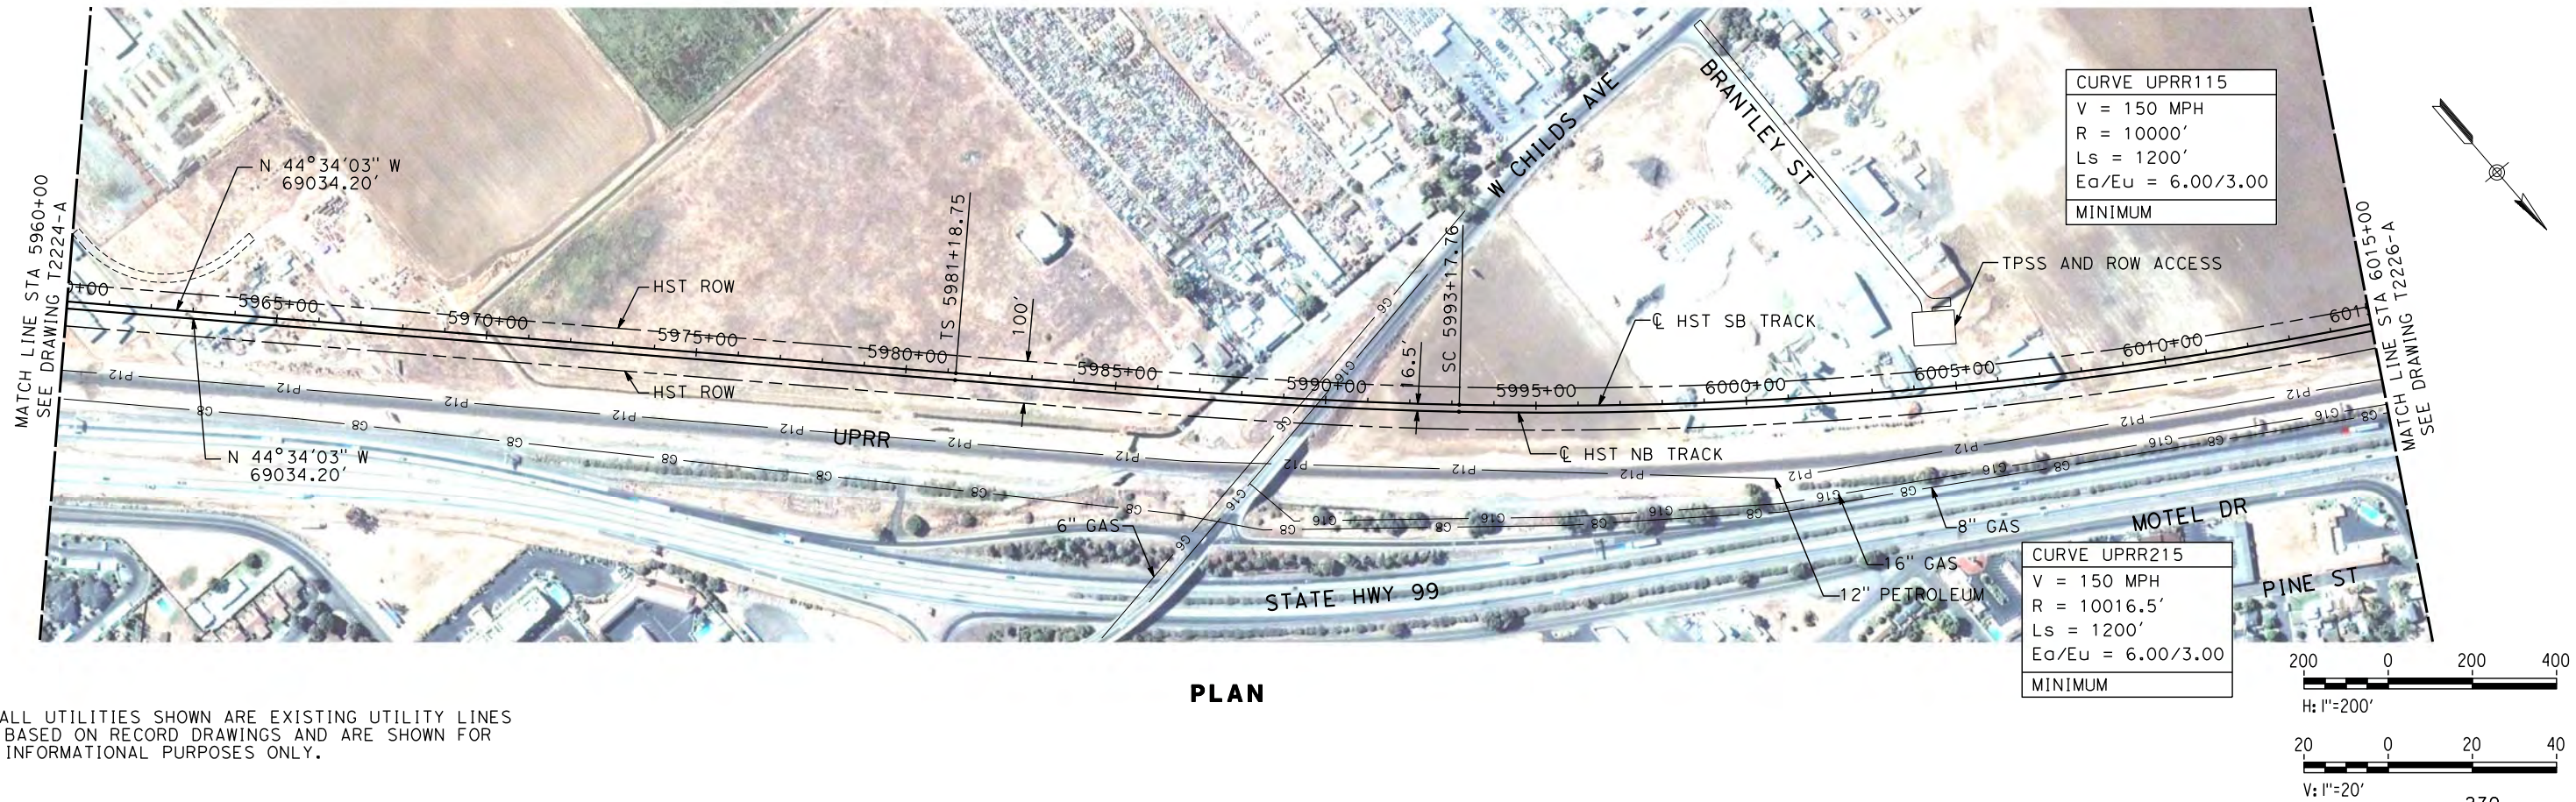
UPRR/SR 99 MERCED CONNECTION

PLAN AND PROFILE  
STA 5905+00 TO STA 5960+00

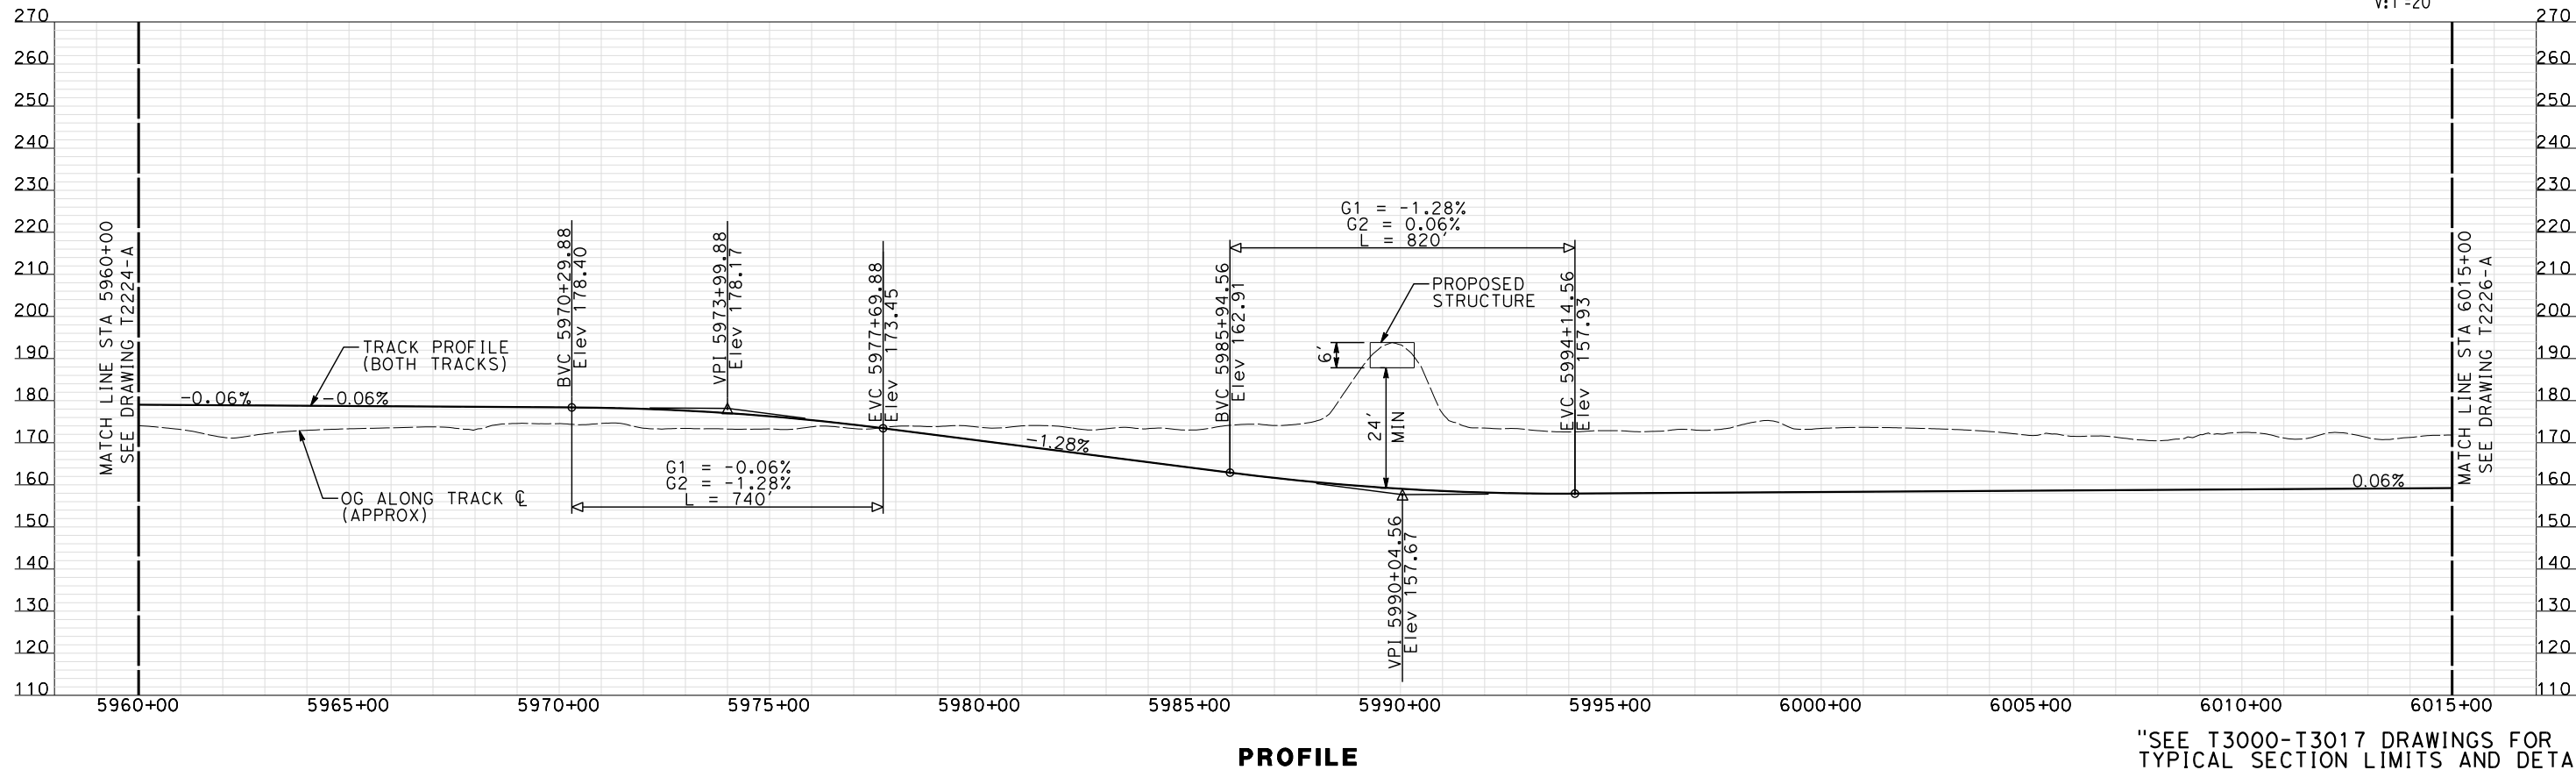
CONTRACT NO. HSR06-007
DRAWING NO. T2224-A
SCALE AS SHOWN
SHEET NO. ### OF ###



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NOTES:  
1. ALL UTILITIES SHOWN ARE EXISTING UTILITY LINES BASED ON RECORD DRAWINGS AND ARE SHOWN FOR INFORMATIONAL PURPOSES ONLY.



"SEE T3000-T3017 DRAWINGS FOR  
TYPICAL SECTION LIMITS AND DETAILS"

REV	DATE	BY	CHK	APP	DESCRIPTION
1	12/12/2011	AS			TRACK REALIGNMENT

DESIGNED BY A. SHIELDS
DRAWN BY H. SULLIVAN
CHECKED BY A. BOONE
IN CHARGE A. BOONE
DATE 07/27/2011

RECORD SET  
15% DESIGN  
SUBMITTAL

NOT FOR  
CONSTRUCTION



CALIFORNIA  
HIGH-SPEED RAIL AUTHORITY

CALIFORNIA HIGH-SPEED TRAIN PROJECT  
MERCED TO FRESNO

UPRR/SR 99 MERCED CONNECTION

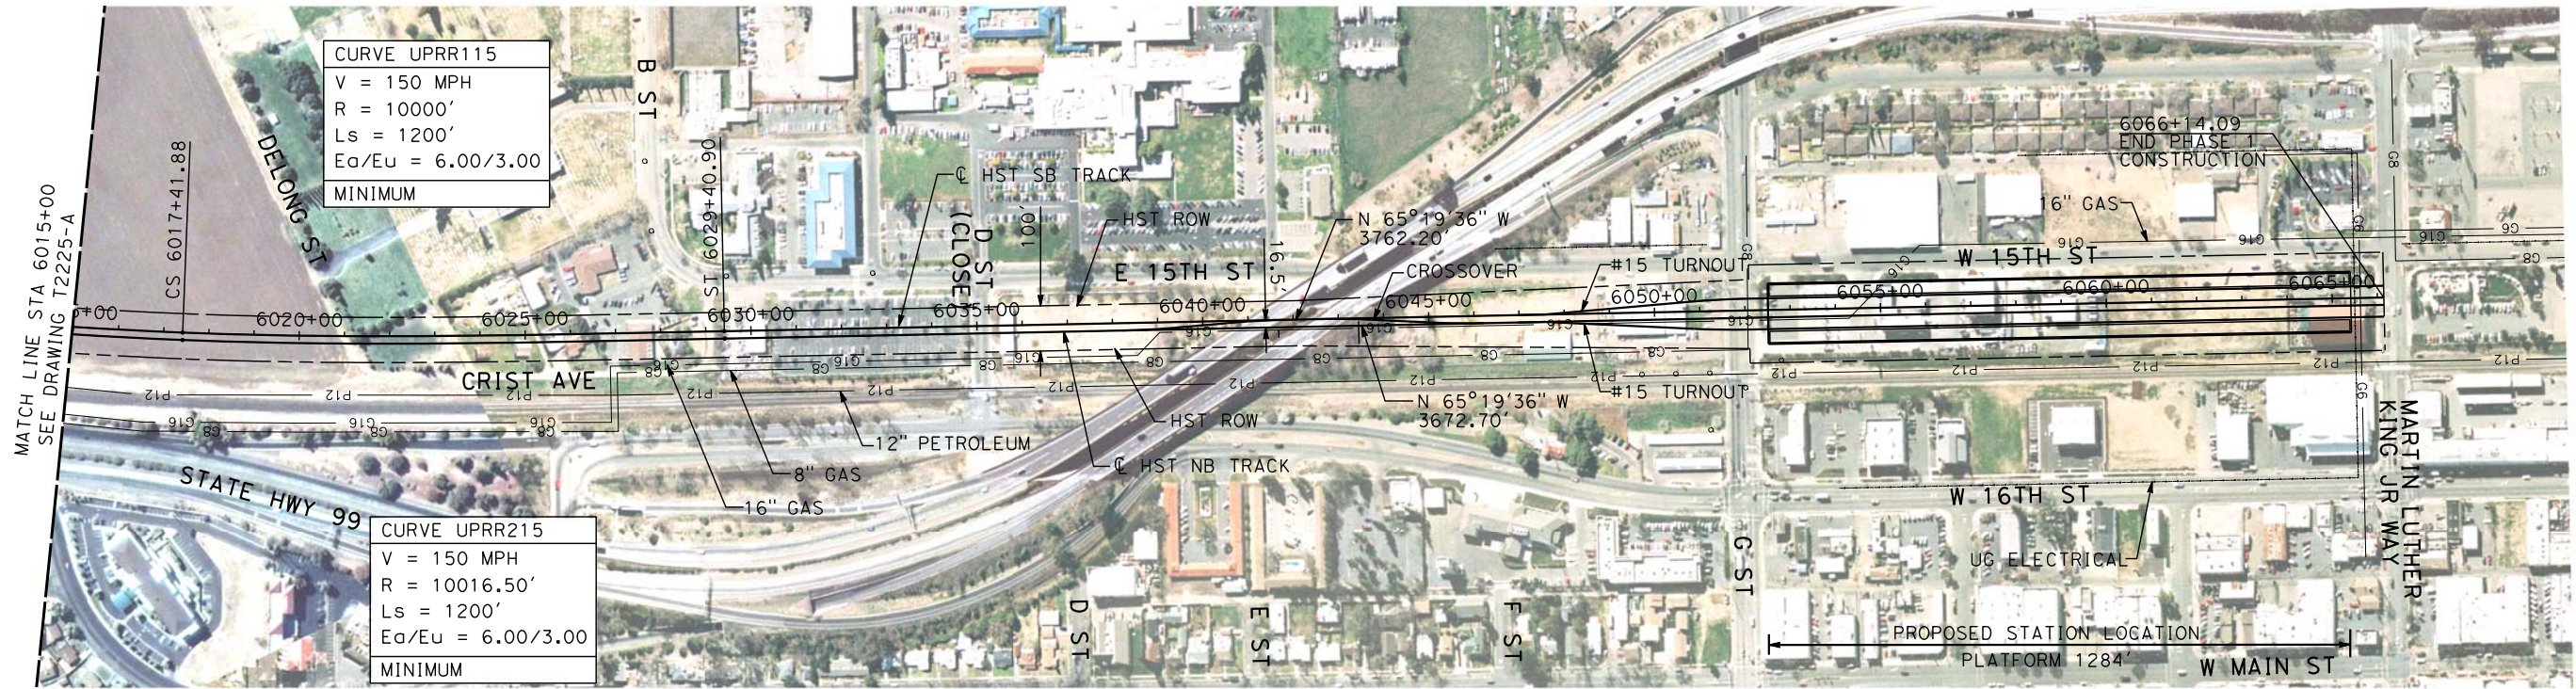
PLAN AND PROFILE  
STA 5960+00 TO STA 6015+00

CONTRACT NO. HSR06-007
DRAWING NO. T2225-A
SCALE AS SHOWN
SHEET NO. ### OF ###



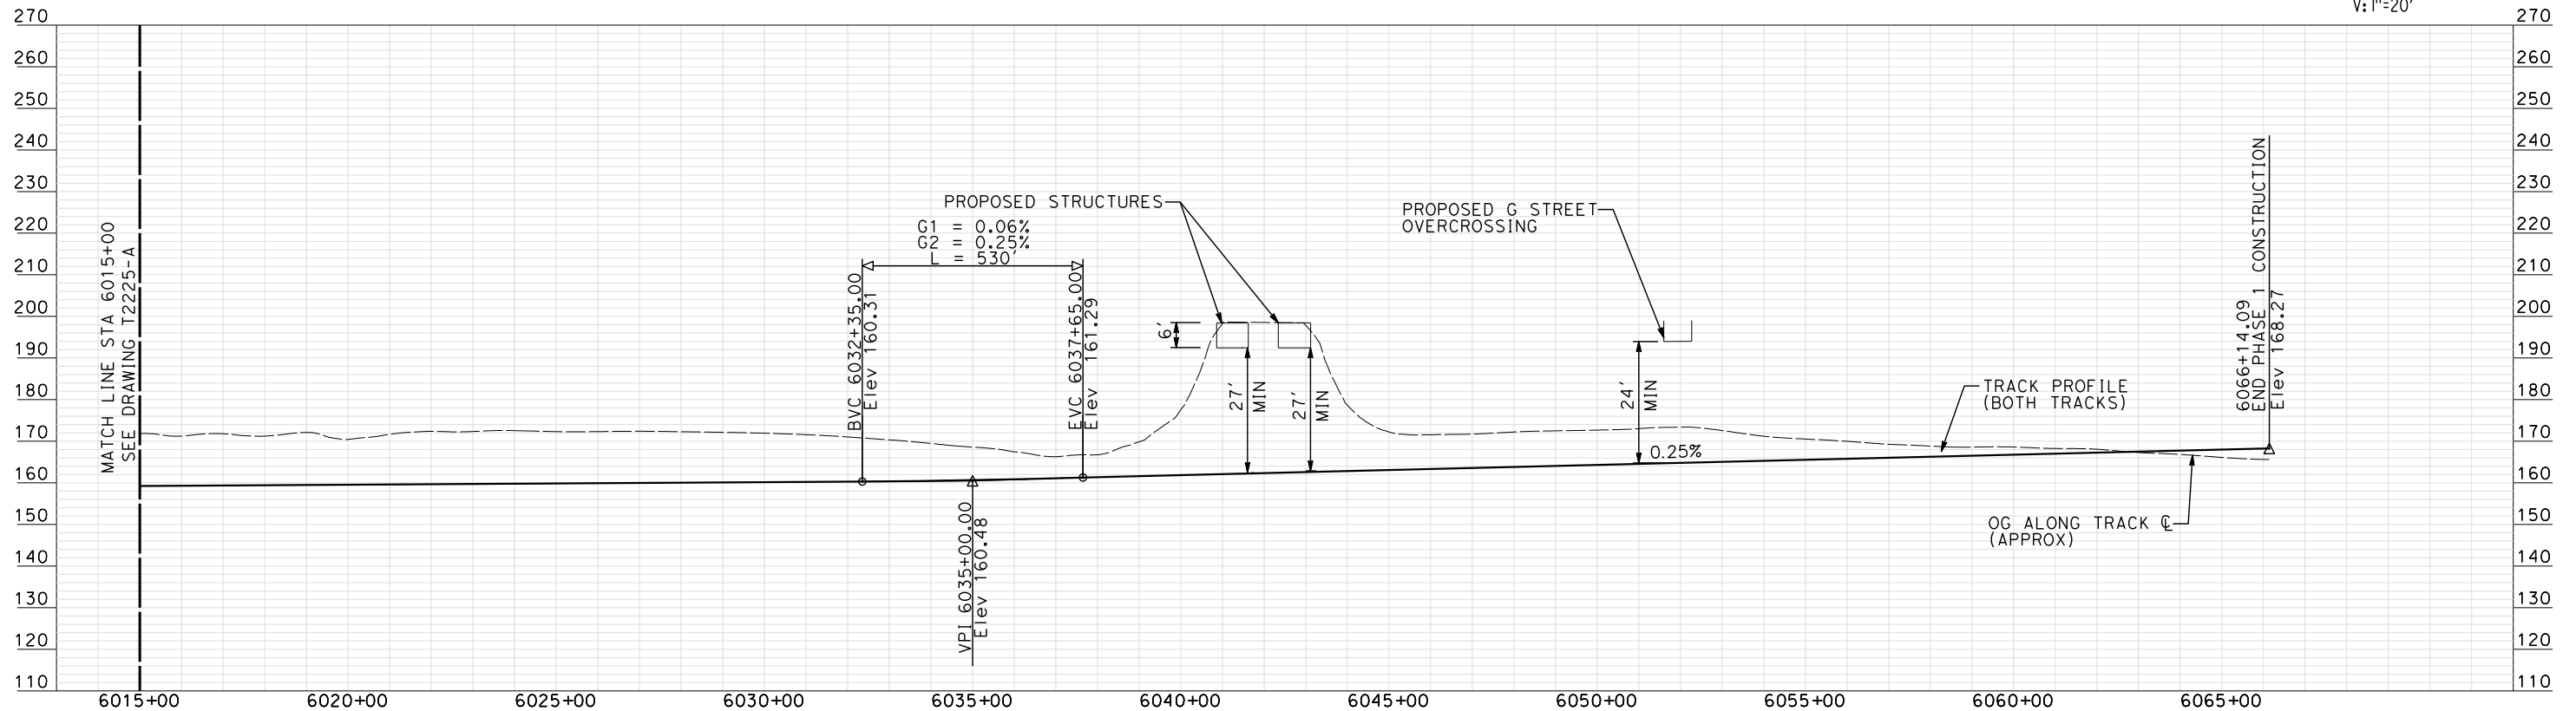
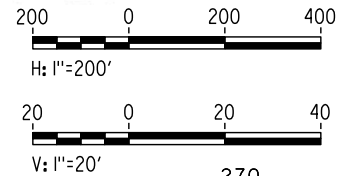
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shieldsa



NOTE:  
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BASED ON RECORD DRAWINGS AND ARE SHOWN FOR  
INFORMATIONAL PURPOSES ONLY.

PLAN



PROFILE

"SEE T3000-T3017 DRAWINGS FOR  
TYPICAL SECTION LIMITS AND DETAILS"

REV	DATE	BY	CHK	APP	DESCRIPTION
1	12/12/2011	AS			TRACK REALIGNMENT

DESIGNED BY  
A. SHIELDS  
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IN CHARGE  
A. BOONE  
DATE  
07/27/2011

RECORD SET  
15% DESIGN  
SUBMITTAL

NOT FOR  
CONSTRUCTION

**AECOM**  
Technical Services, Inc.  
2020 L Street, Suite 300  
Sacramento, CA 95811  
**CH2MHILL**



**CALIFORNIA HIGH-SPEED TRAIN PROJECT  
MERCED TO FRESNO**

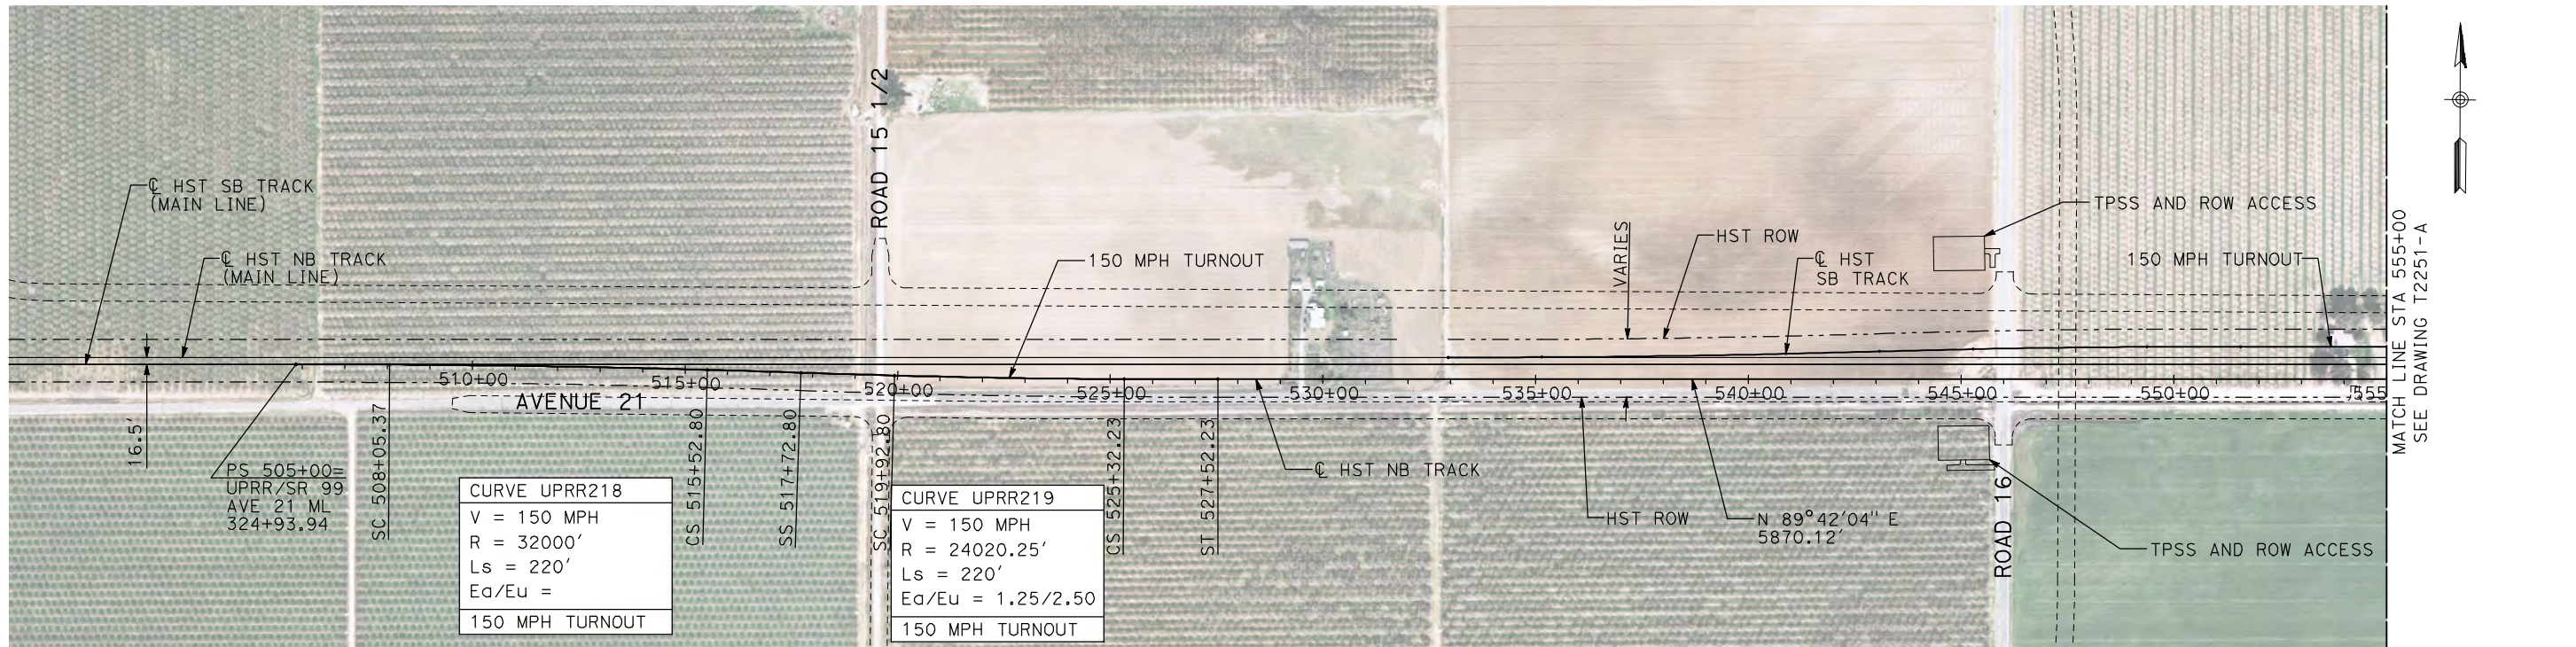
UPRR/SR 99 MERCED CONNECTION

PLAN AND PROFILE  
STA 6015+00 TO STA 6066+14.09

CONTRACT NO.  
HSR06-007  
DRAWING NO.  
T2226-A  
SCALE  
AS SHOWN  
SHEET NO.  
### OF ###

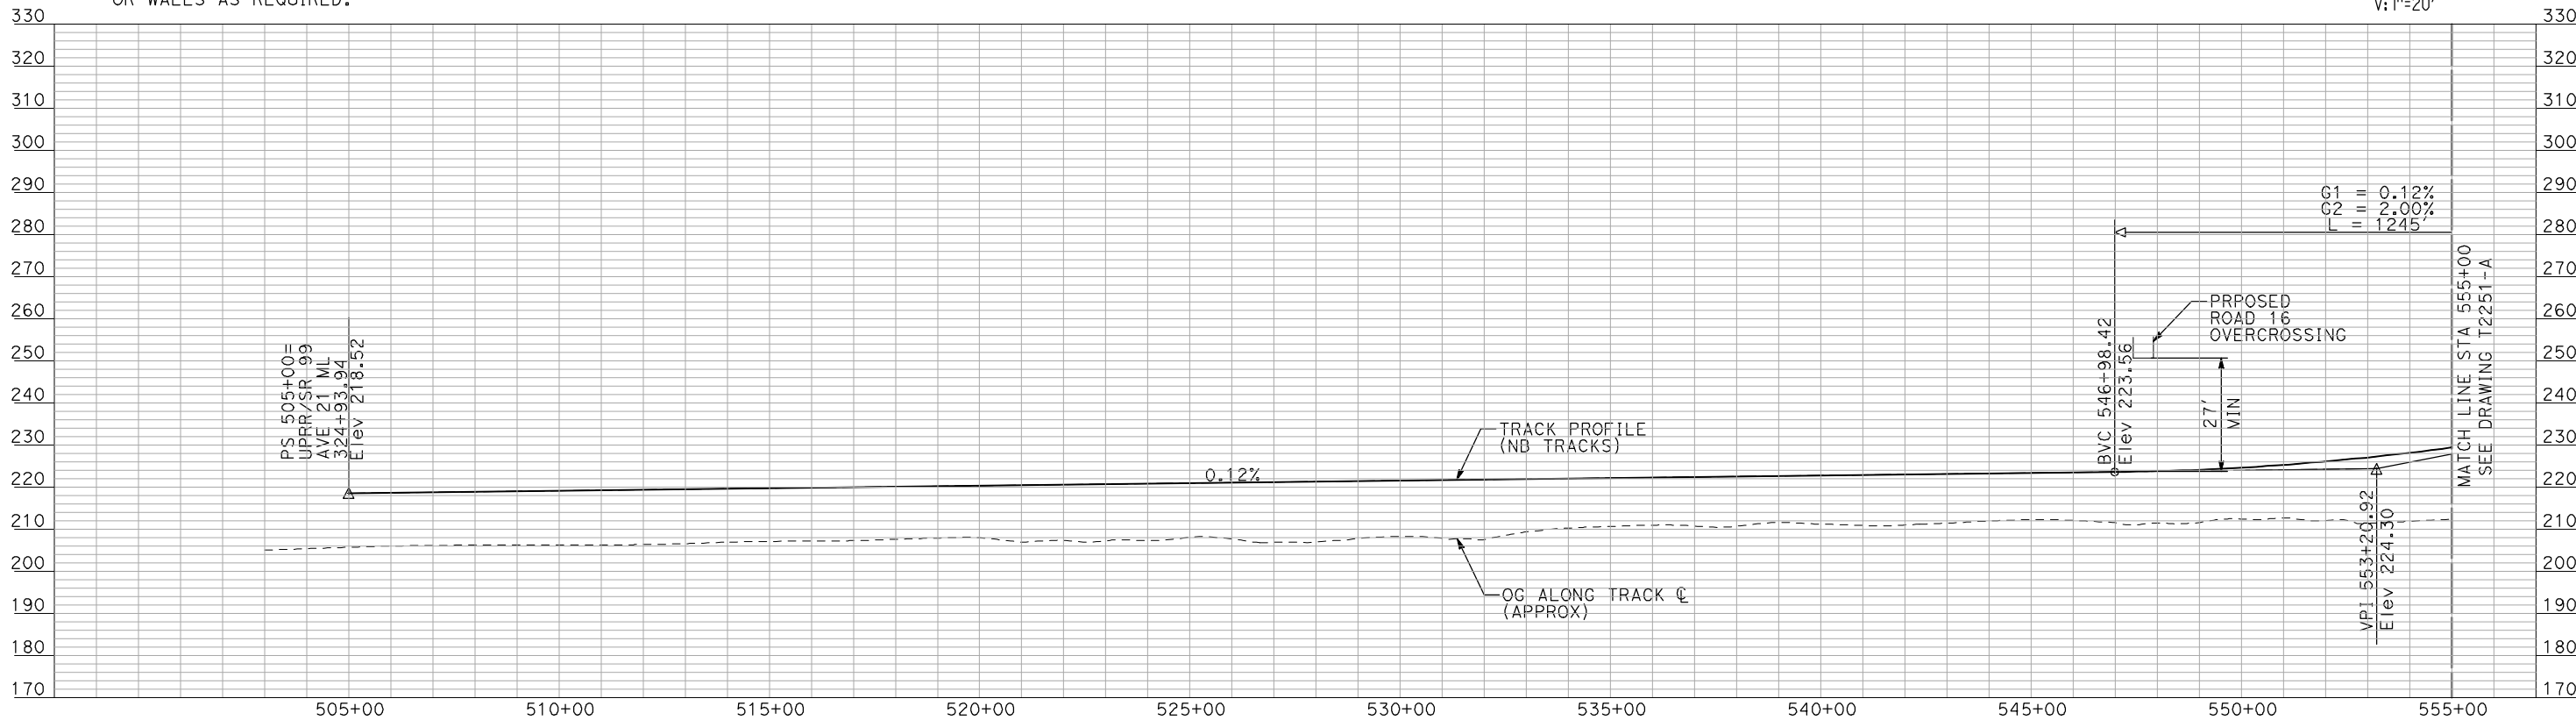
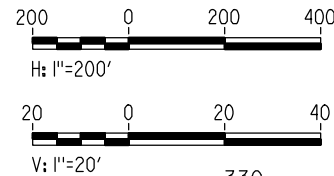


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NOTES:

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"SEE T3000-T3017 DRAWINGS FOR  
TYPICAL SECTION LIMITS AND DETAILS"

REV	DATE	BY	CHK	APP	DESCRIPTION

DESIGNED BY A. SHIELDS
DRAWN BY H. SULLIVAN
CHECKED BY A. BOONE
IN CHARGE A. BOONE
DATE 07/20/2011

RECORD SET  
15% DESIGN  
SUBMITTAL

NOT FOR  
CONSTRUCTION



CALIFORNIA  
HIGH-SPEED RAIL AUTHORITY

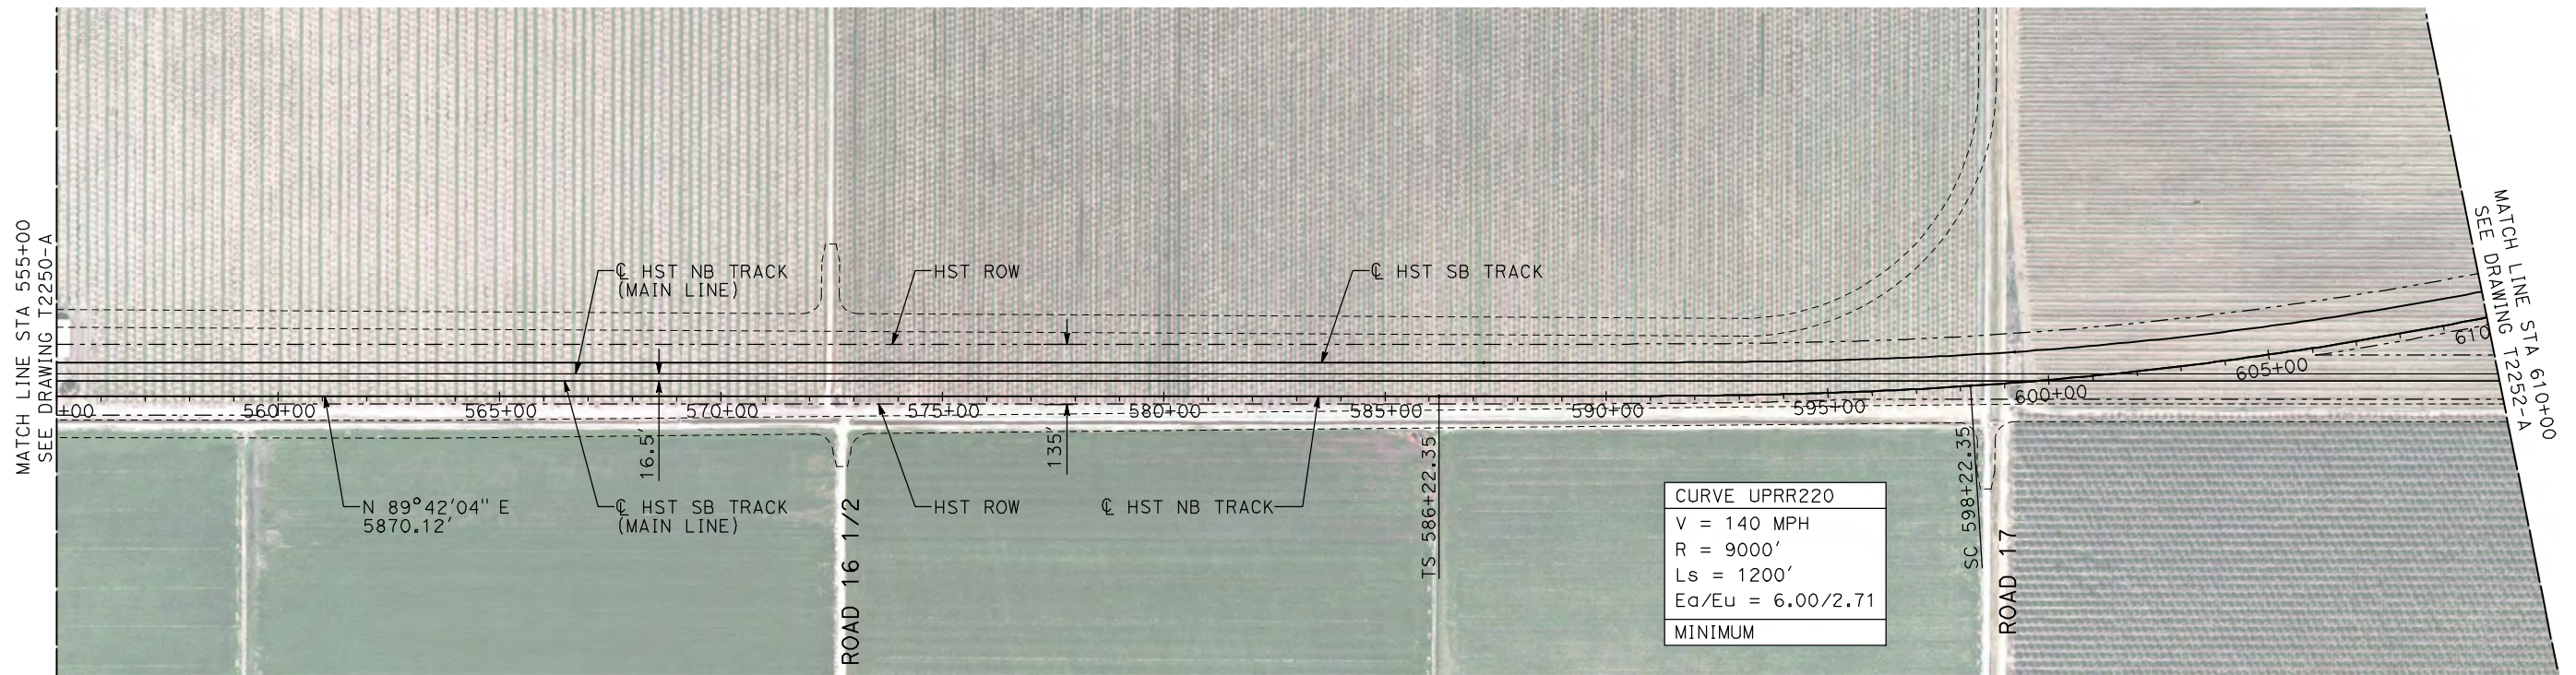
CALIFORNIA HIGH-SPEED TRAIN PROJECT  
MERCED TO FRESNO

UPRR/SR 99 WYE - NB CONNECTION  
AVENUE 21  
PLAN AND PROFILE  
STA 505+00 TO STA 555+00

CONTRACT NO. HSR06-007
DRAWING NO. T2250-A
SCALE AS SHOWN
SHEET NO. ### OF ###



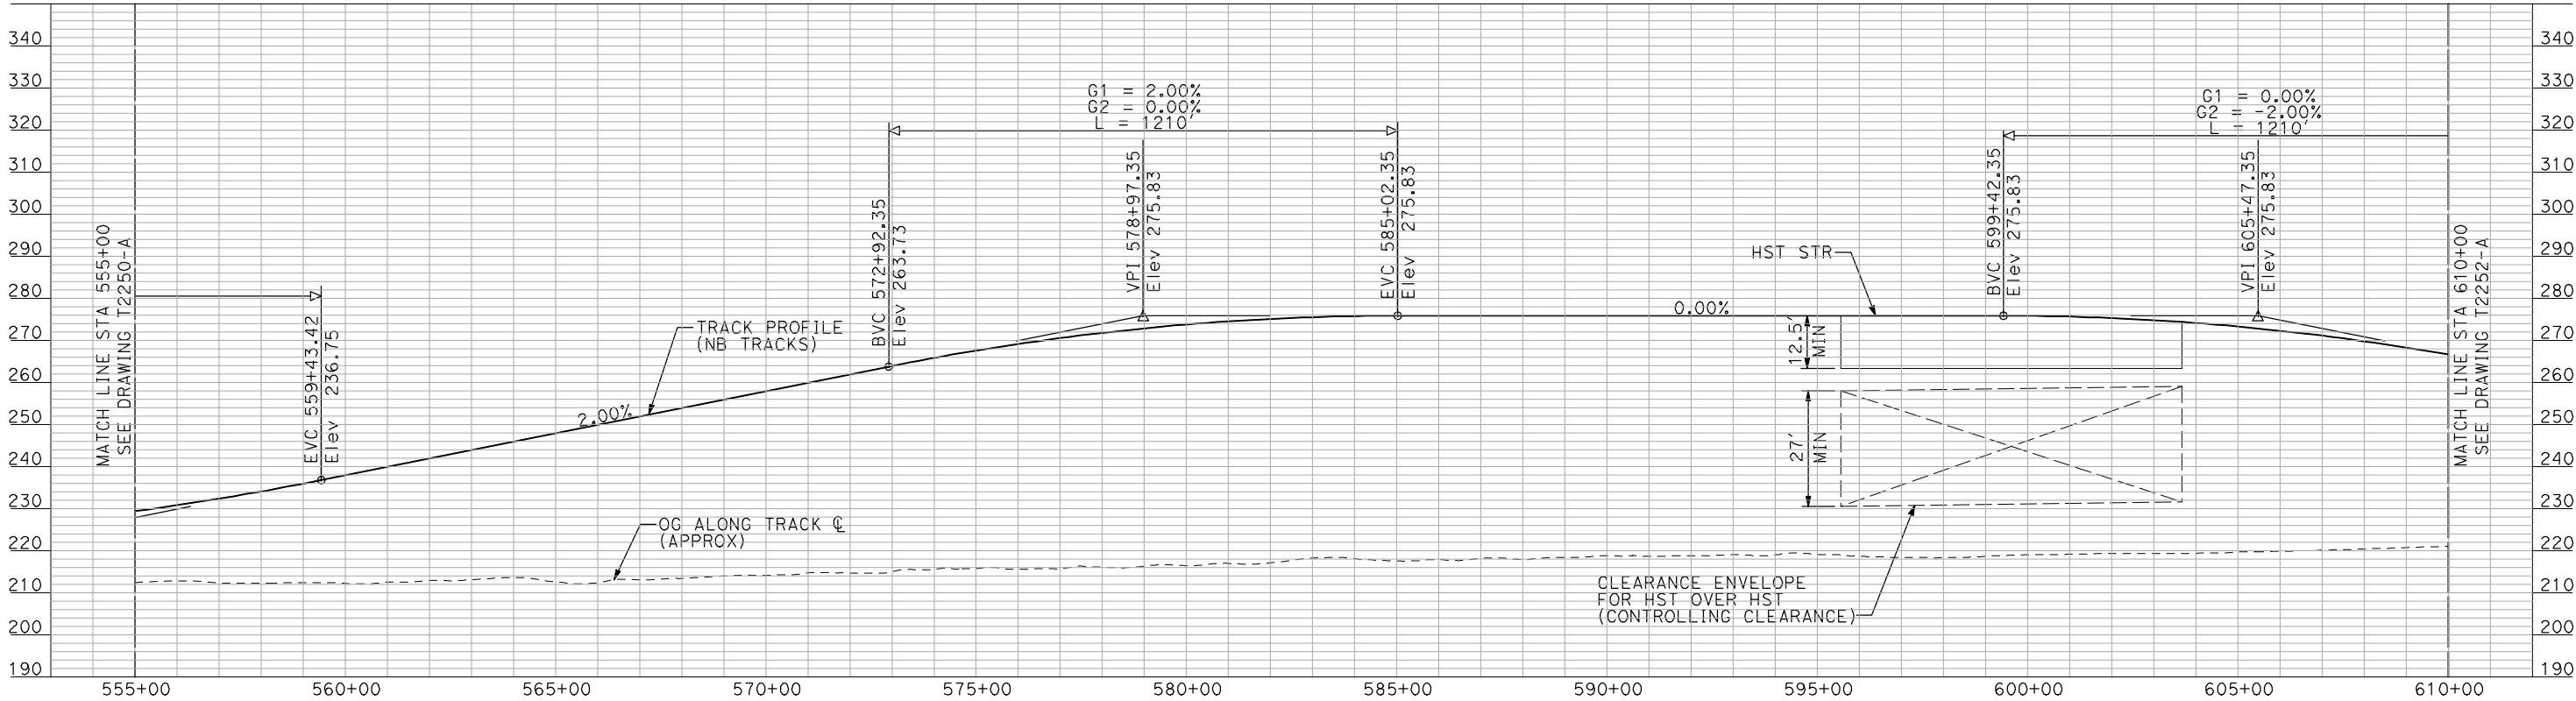
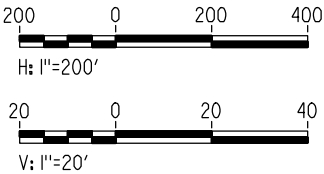
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NOTES:

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PLAN



"SEE T3000-T3017 DRAWINGS FOR  
TYPICAL SECTION LIMITS AND DETAILS"

REV	DATE	BY	CHK	APP	DESCRIPTION

DESIGNED BY A. SHIELDS
DRAWN BY H. SULLIVAN
CHECKED BY A. BOONE
IN CHARGE A. BOONE
DATE 07/20/2011

**RECORD SET**  
**15% DESIGN**  
**SUBMITTAL**

**NOT FOR**  
**CONSTRUCTION**

**AECOM**  
Technical Services, Inc.  
2020 L Street, Suite 300  
Sacramento, CA 95811

**CH2M HILL**



**CALIFORNIA HIGH-SPEED TRAIN PROJECT**  
**MERCED TO FRESNO**  
UPRR/SR 99 WYE - NB CONNECTION  
AVENUE 21  
PLAN AND PROFILE  
STA 555+00 TO STA 610+00

CONTRACT NO. HSR06-007
DRAWING NO. T2251-A
SCALE AS SHOWN
SHEET NO. ### OF ###



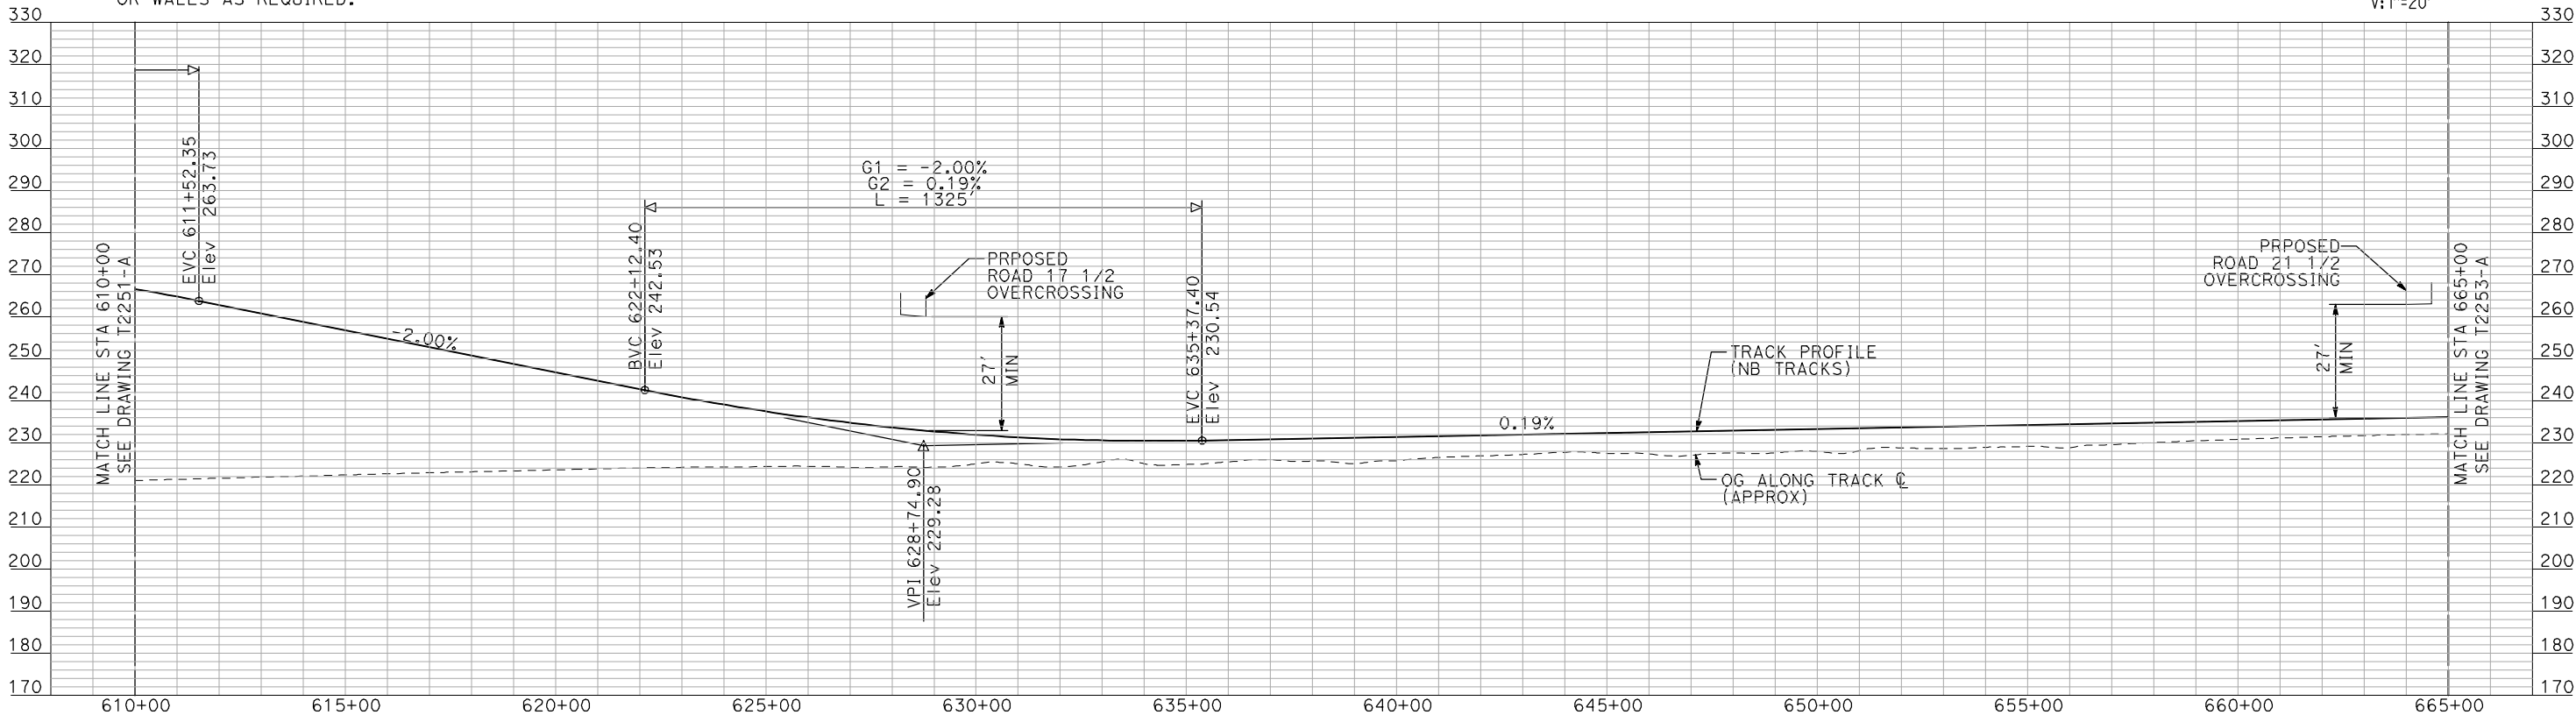
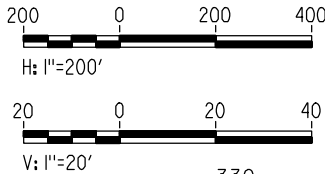
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PLAN



PROFILE

"SEE T3000-T3017 DRAWINGS FOR  
TYPICAL SECTION LIMITS AND DETAILS"

REV	DATE	BY	CHK	APP	DESCRIPTION

DESIGNED BY  
A. SHIELDS  
DRAWN BY  
H. SULLIVAN  
CHECKED BY  
A. BOONE  
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A. BOONE  
DATE  
07/20/2011

RECORD SET  
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SUBMITTAL  
  
NOT FOR  
CONSTRUCTION

**AECOM**  
Technical Services, Inc.  
2020 L Street, Suite 300  
Sacramento, CA 95811  
**CH2M HILL**

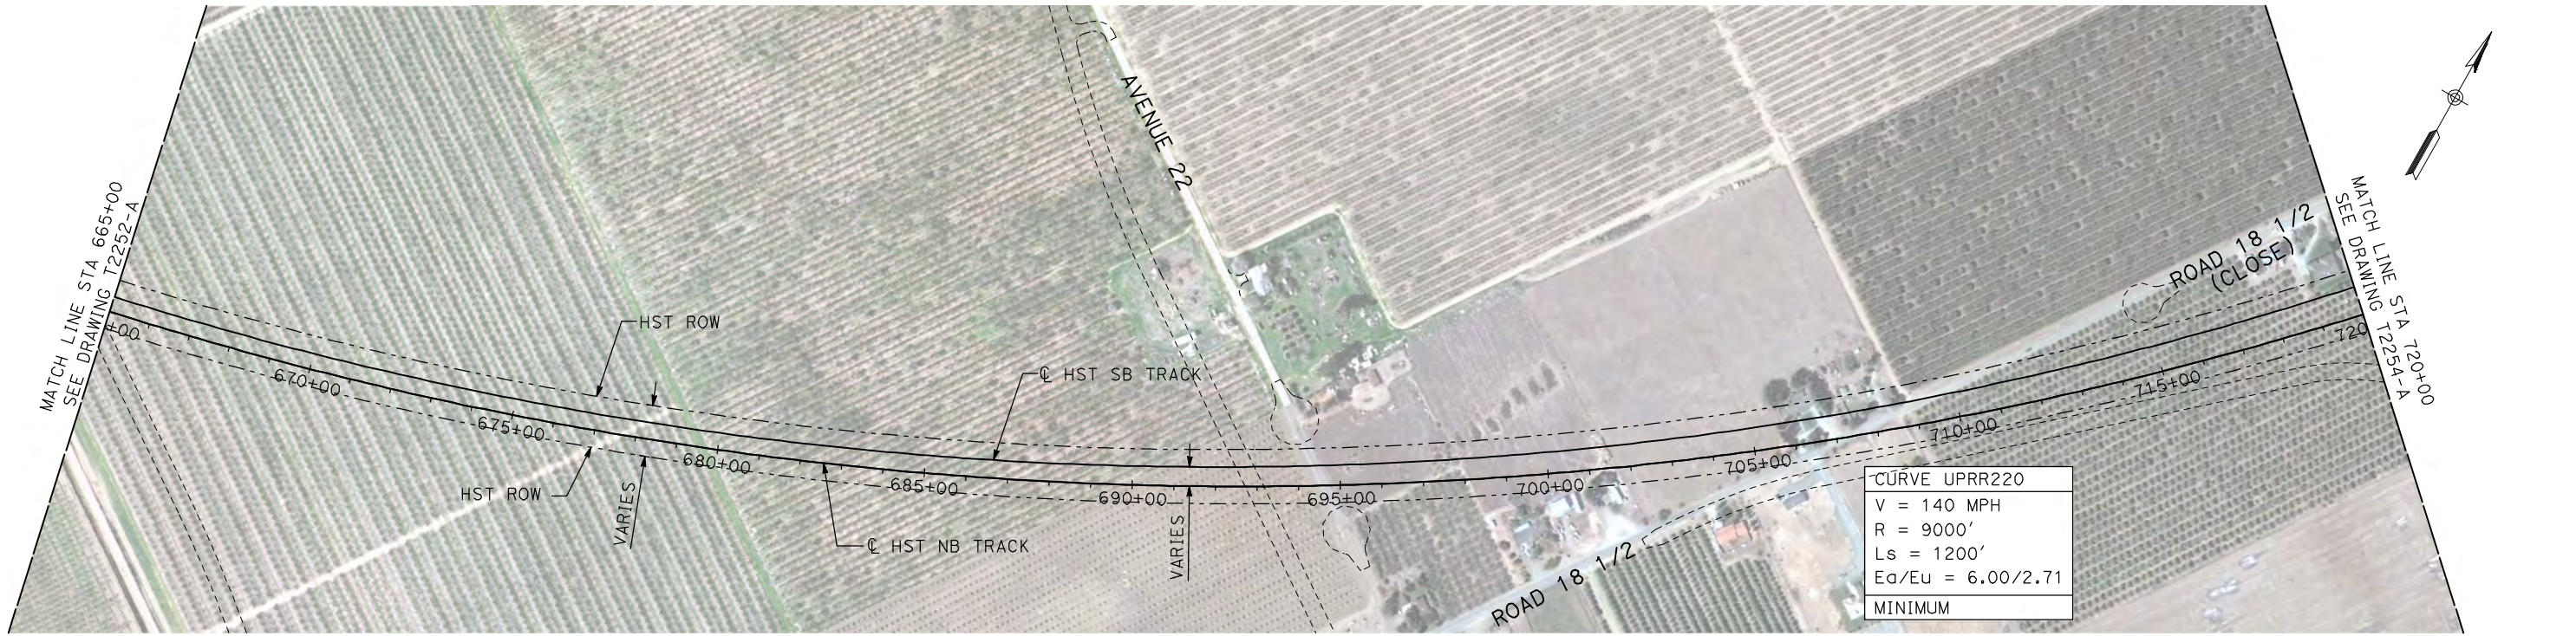


**CALIFORNIA HIGH-SPEED TRAIN PROJECT  
MERCED TO FRESNO**  
UPRR/SR 99 WYE - NB CONNECTION  
AVENUE 21  
PLAN AND PROFILE  
STA 610+00 TO STA 665+00

CONTRACT NO.  
HSR06-007  
DRAWING NO.  
T2252-A  
SCALE  
AS SHOWN  
SHEET NO.  
### OF ###



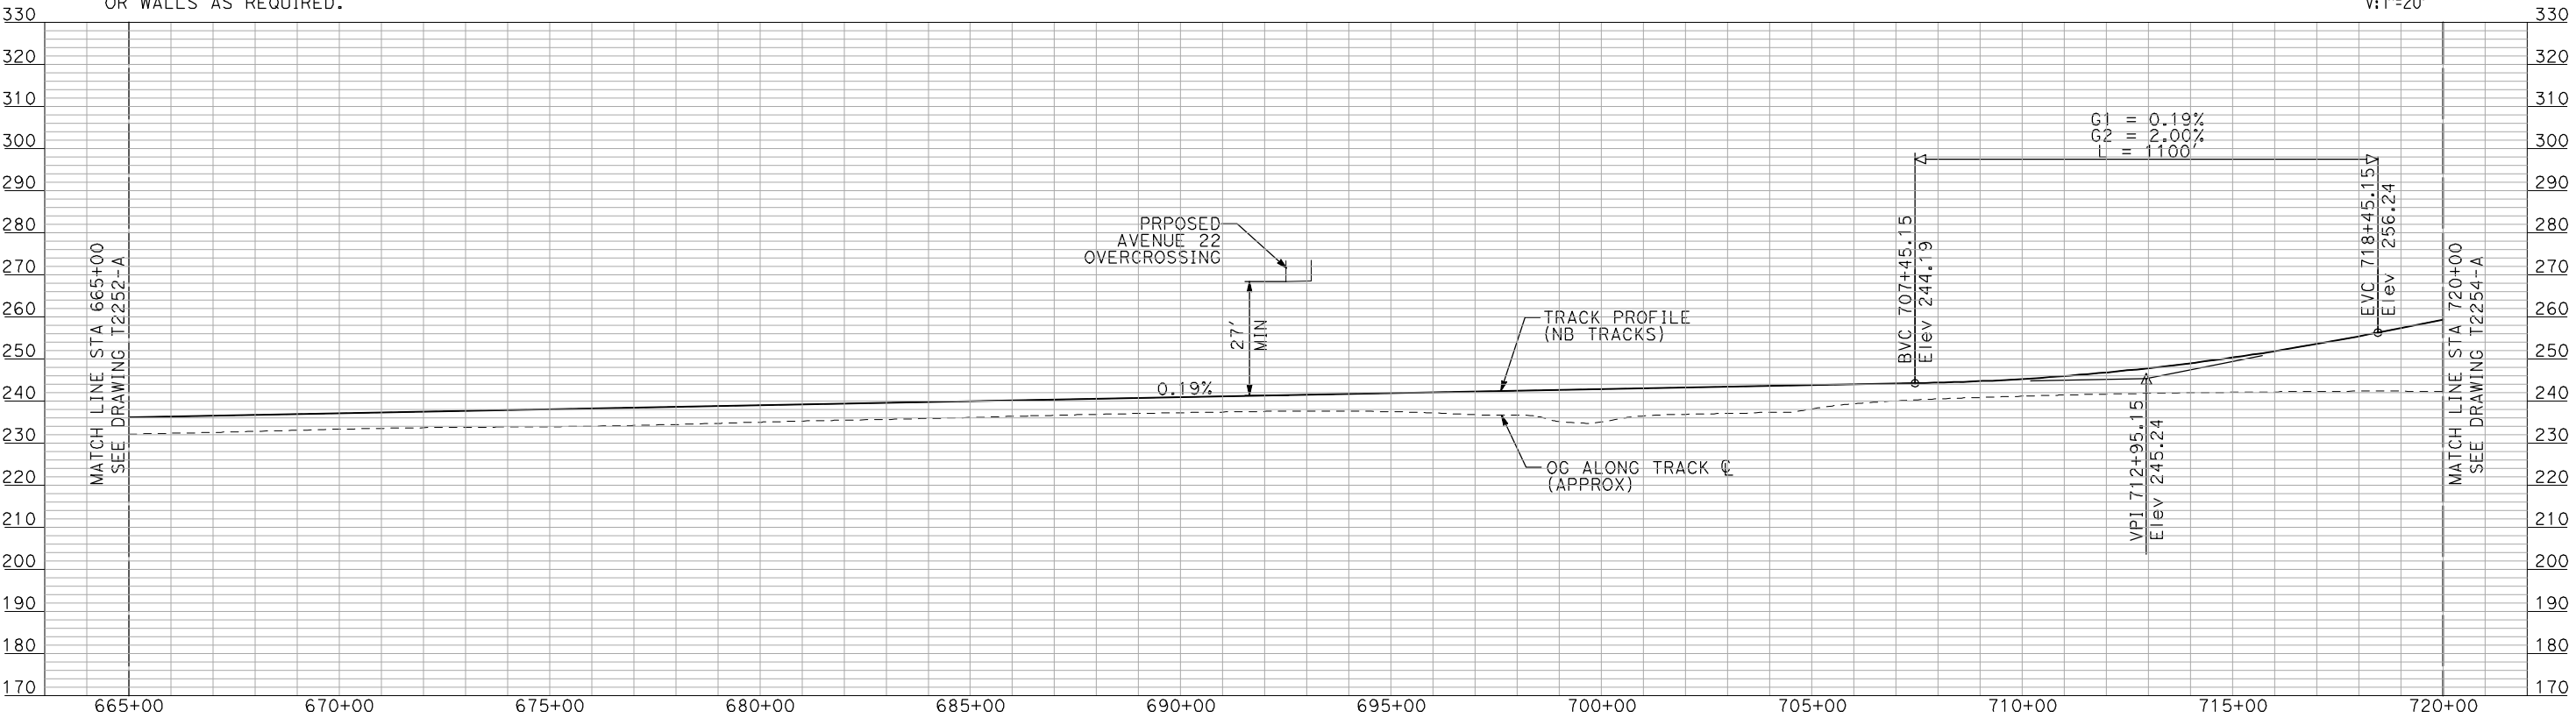
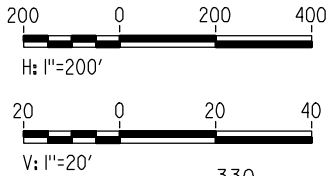
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NOTES:

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PLAN



PROFILE

"SEE T3000-T3017 DRAWINGS FOR  
TYPICAL SECTION LIMITS AND DETAILS"

REV	DATE	BY	CHK	APP	DESCRIPTION

DESIGNED BY A. SHIELDS
DRAWN BY H. SULLIVAN
CHECKED BY A. BOONE
IN CHARGE A. BOONE
DATE 07/20/2011

RECORD SET 15% DESIGN SUBMITTAL
NOT FOR CONSTRUCTION



Technical Services, Inc.  
2020 L Street, Suite 300  
Sacramento, CA 95811





CALIFORNIA  
HIGH-SPEED RAIL AUTHORITY

**CALIFORNIA HIGH-SPEED TRAIN PROJECT**  
**MERCED TO FRESNO**

UPRR/SR 99 WYE - NB CONNECTION  
AVENUE 21  
PLAN AND PROFILE  
STA 665+00 TO STA 720+00

CONTRACT NO. HSR06-007
DRAWING NO. T2253-A
SCALE AS SHOWN
SHEET NO. ### OF ###



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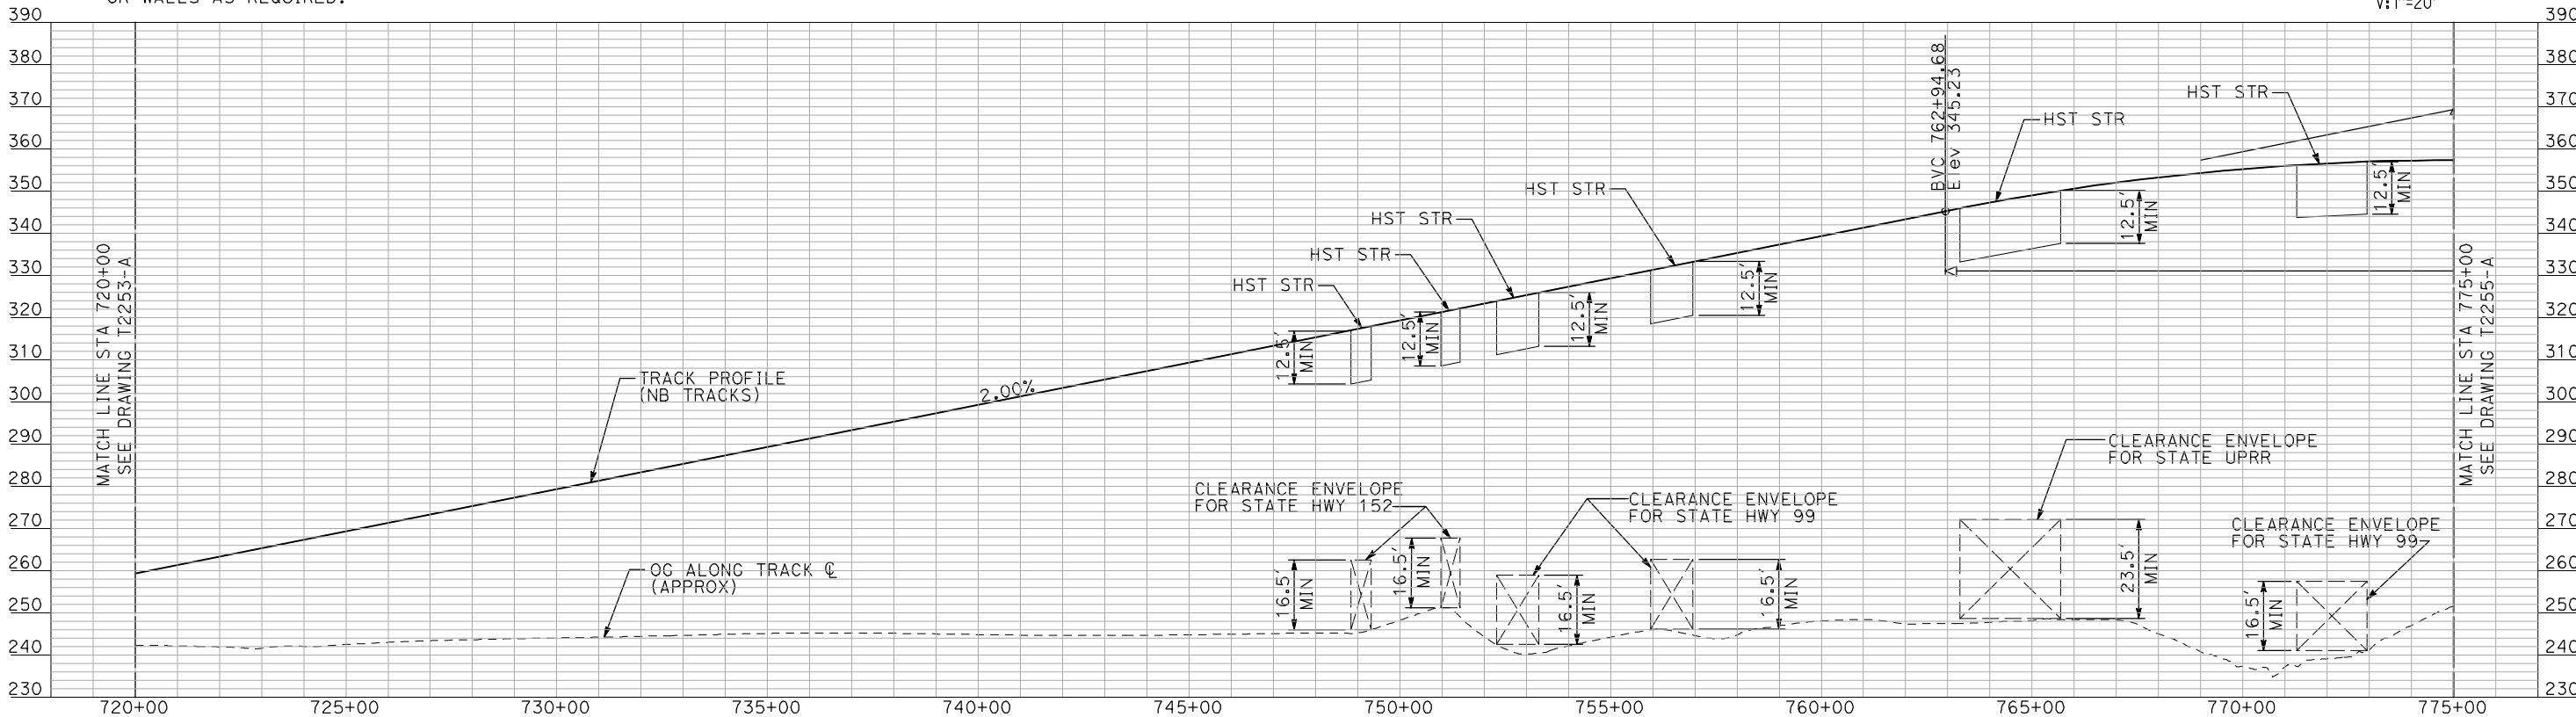
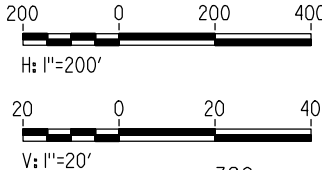


CURVE UPRR220
V = 140 MPH
R = 9000'
Ls = 1200'
Ea/Eu = 6.00/2.71
MINIMUM

NOTES:

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PLAN



PROFILE

"SEE T3000-T3017 DRAWINGS FOR  
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SUBMITTAL  
  
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CONSTRUCTION

**AECOM**  
Technical Services, Inc.  
2020 L Street, Suite 300  
Sacramento, CA 95811  
**CH2M HILL**

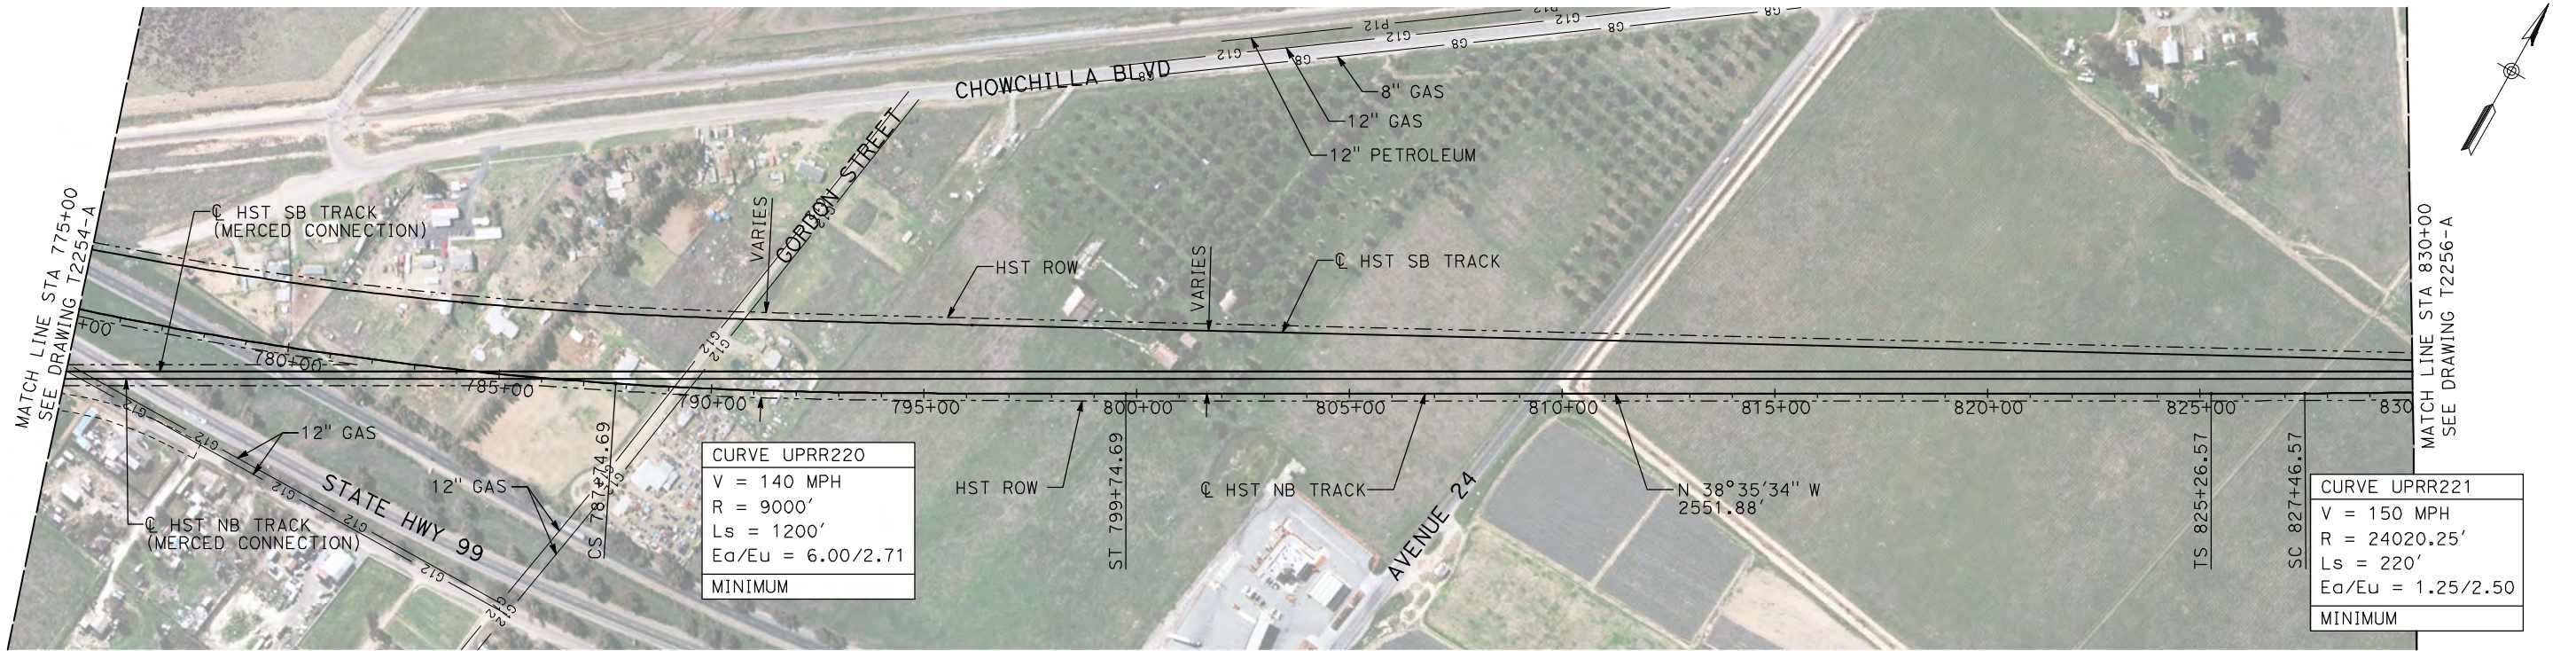


**CALIFORNIA HIGH-SPEED TRAIN PROJECT  
MERCED TO FRESNO**  
UPRR/SR 99 WYE - NB CONNECTION  
AVENUE 21  
PLAN AND PROFILE  
STA 720+00 TO STA 775+00

CONTRACT NO. HSR06-007
DRAWING NO. T2254-A
SCALE AS SHOWN
SHEET NO. ### OF ###



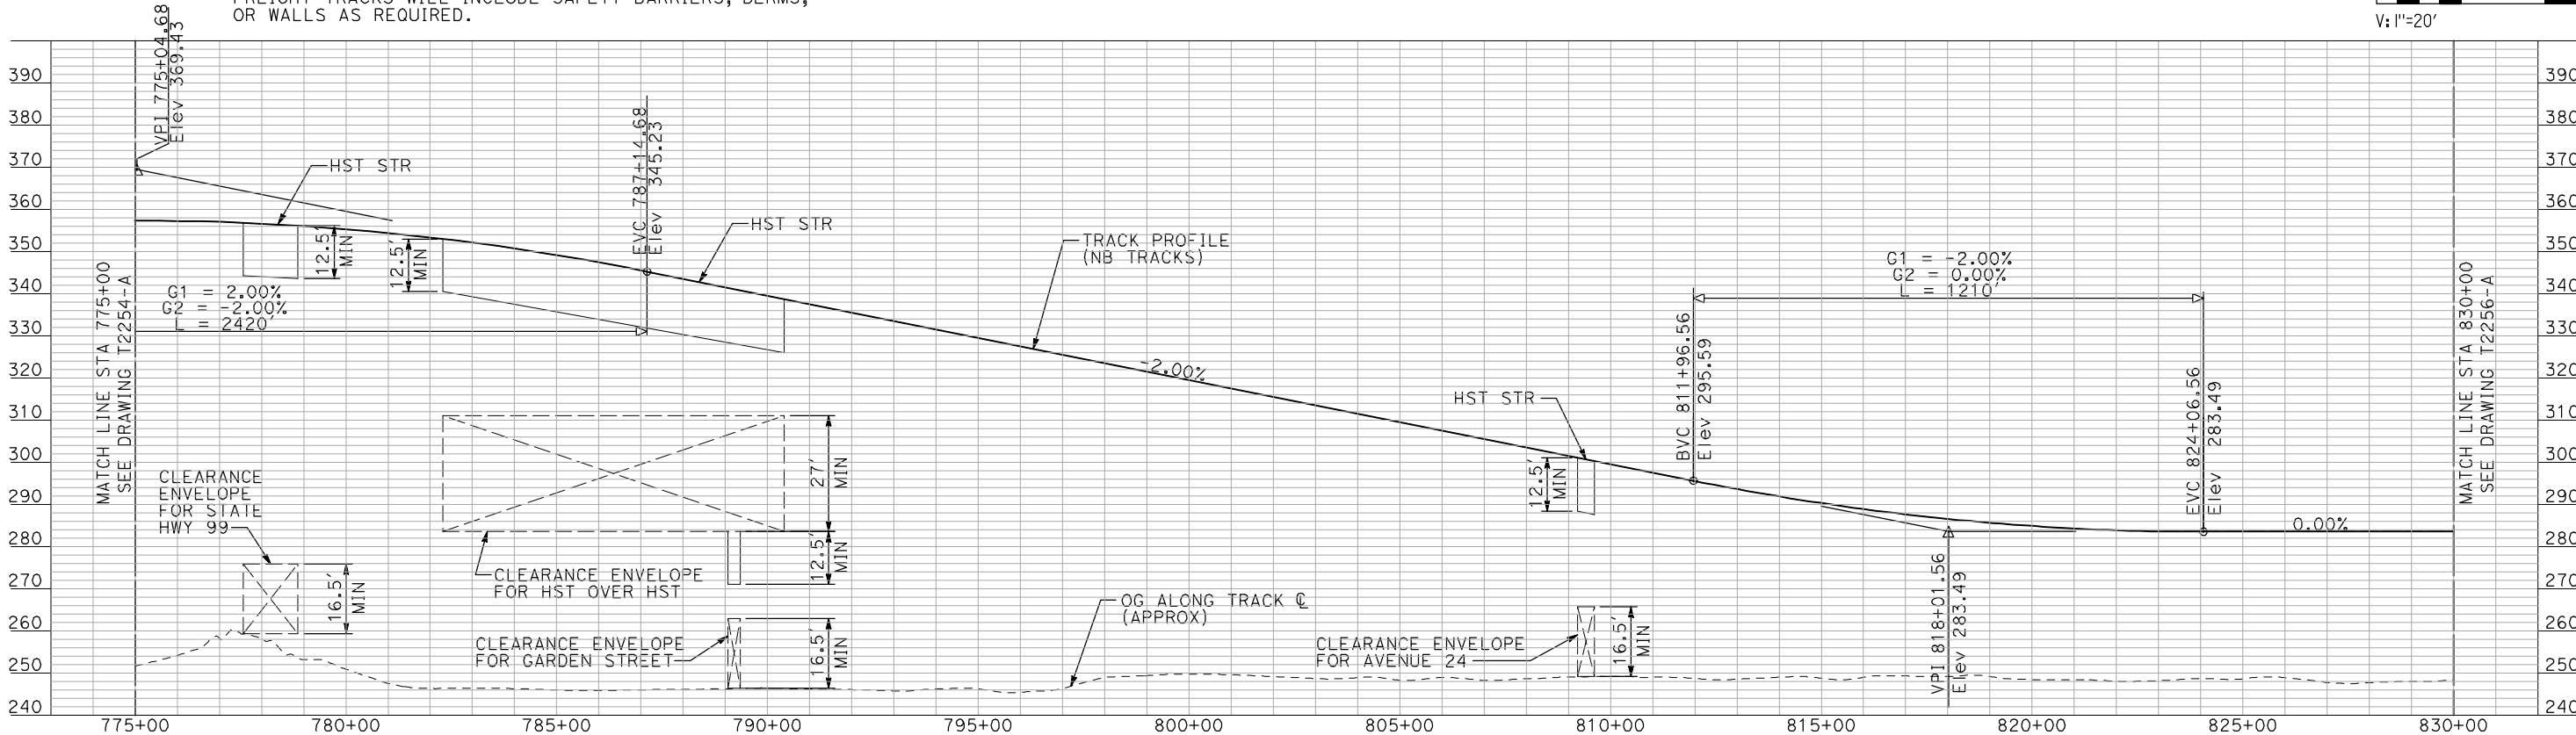
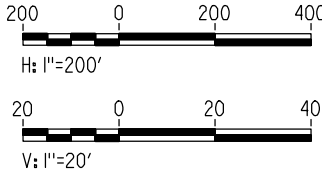
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NOTES:

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PLAN



PROFILE

"SEE T3000-T3017 DRAWINGS FOR  
TYPICAL SECTION LIMITS AND DETAILS"

REV	DATE	BY	CHK	APP	DESCRIPTION

DESIGNED BY A. SHIELDS
DRAWN BY H. SULLIVAN
CHECKED BY A. BOONE
IN CHARGE A. BOONE
DATE 07/20/2011

RECORD SET  
15% DESIGN  
SUBMITTAL

NOT FOR  
CONSTRUCTION



CALIFORNIA  
HIGH-SPEED RAIL AUTHORITY

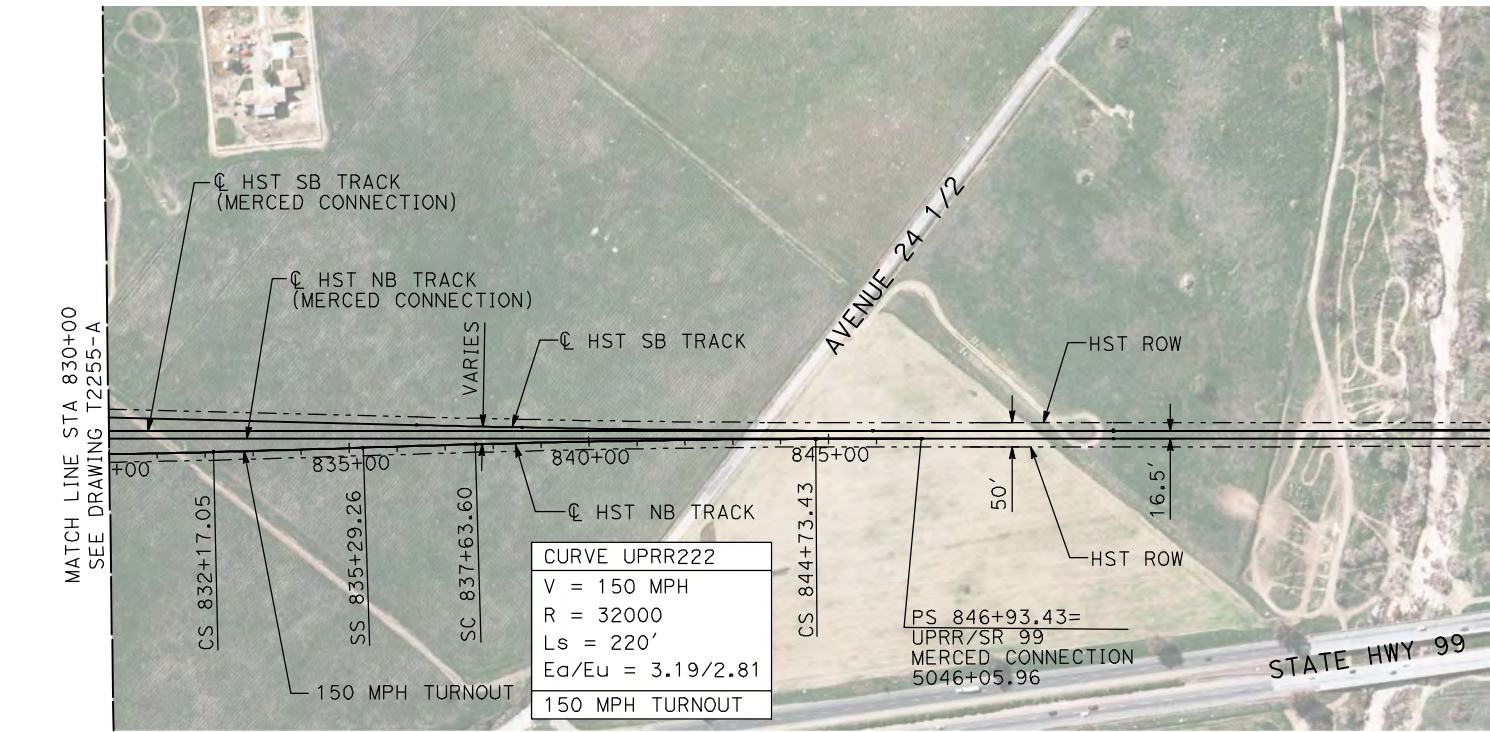
CALIFORNIA HIGH-SPEED TRAIN PROJECT  
MERCED TO FRESNO

UPRR/SR 99 WYE - NB CONNECTION  
AVENUE 21  
PLAN AND PROFILE  
STA 775+00 TO STA 830+00

CONTRACT NO. HSR06-007
DRAWING NO. T2255-A
SCALE AS SHOWN
SHEET NO. ### OF ###



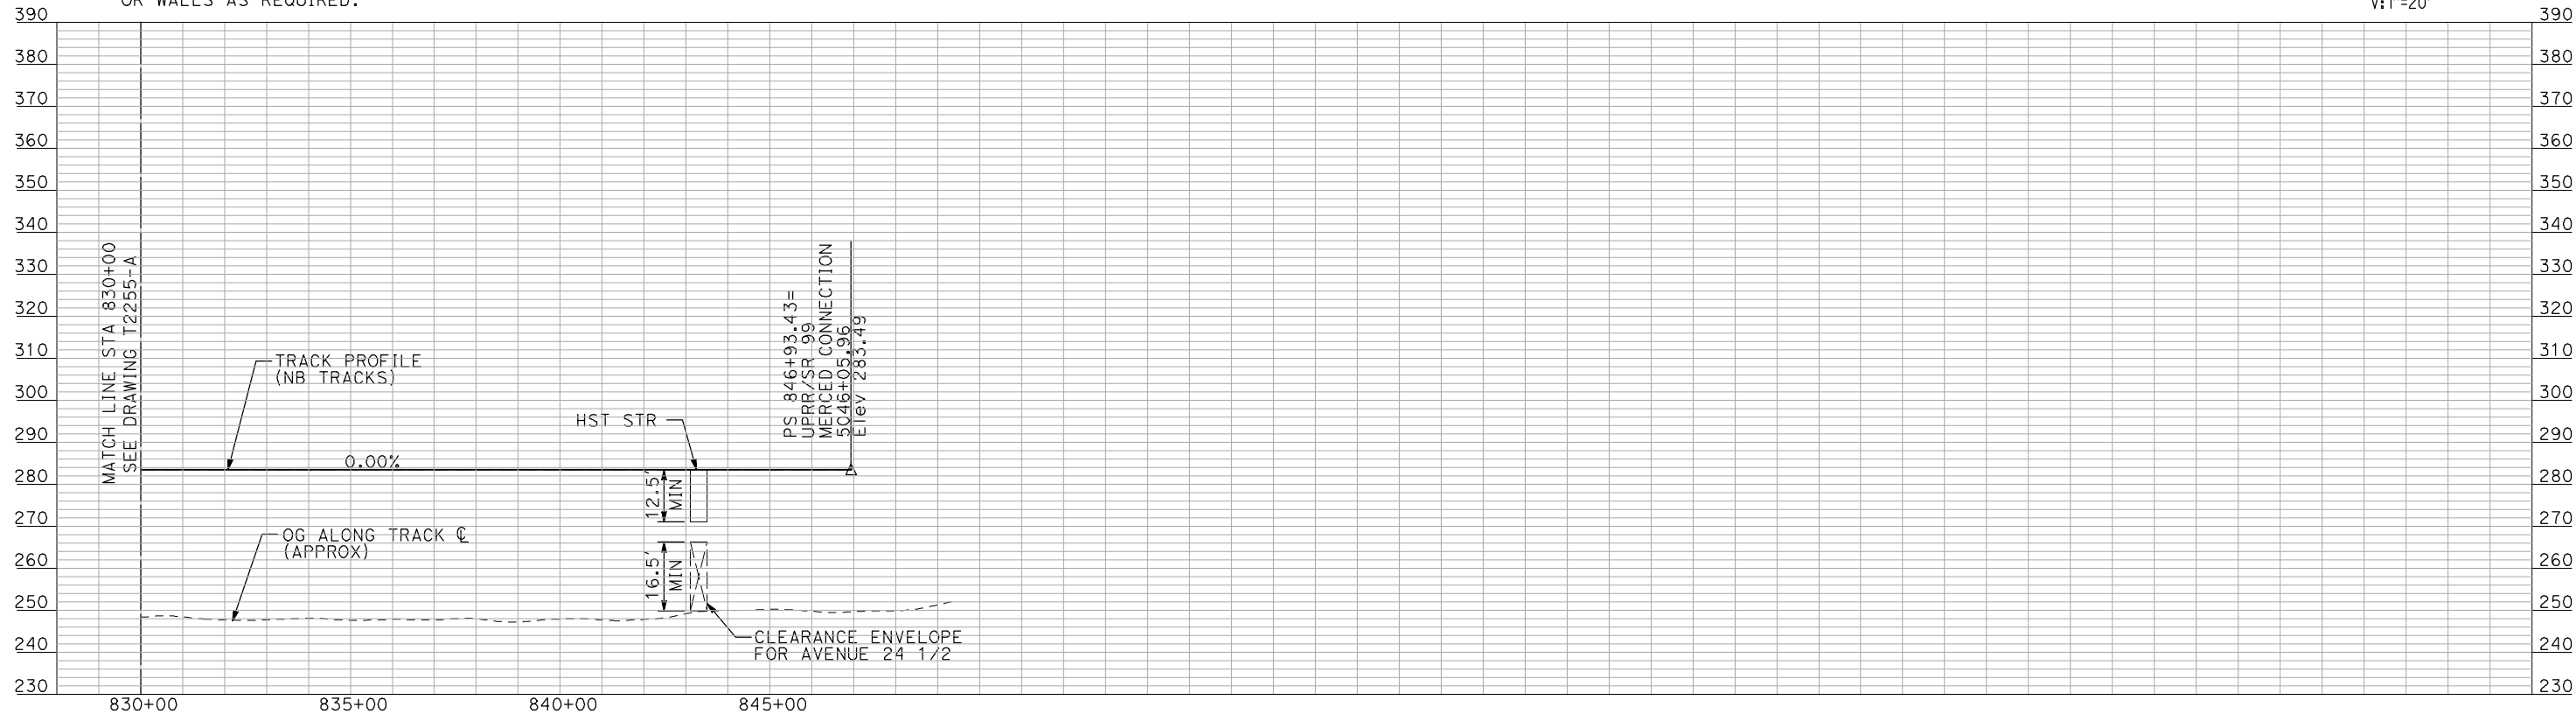
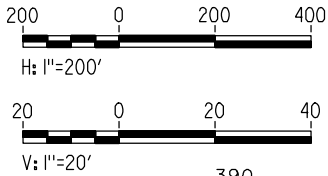
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NOTES:

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- TRACKS CLOSER THAN 102 FT TO THE NEAREST EXISTING FREIGHT TRACKS WILL INCLUDE SAFETY BARRIERS, BERMS, OR WALLS AS REQUIRED.

PLAN



PROFILE

"SEE T3000-T3017 DRAWINGS FOR  
TYPICAL SECTION LIMITS AND DETAILS"

REV	DATE	BY	CHK	APP	DESCRIPTION

DESIGNED BY A. SHIELDS
DRAWN BY H. SULLIVAN
CHECKED BY A. BOONE
IN CHARGE A. BOONE
DATE 07/20/2011

RECORD SET  
15% DESIGN  
SUBMITTAL

NOT FOR  
CONSTRUCTION



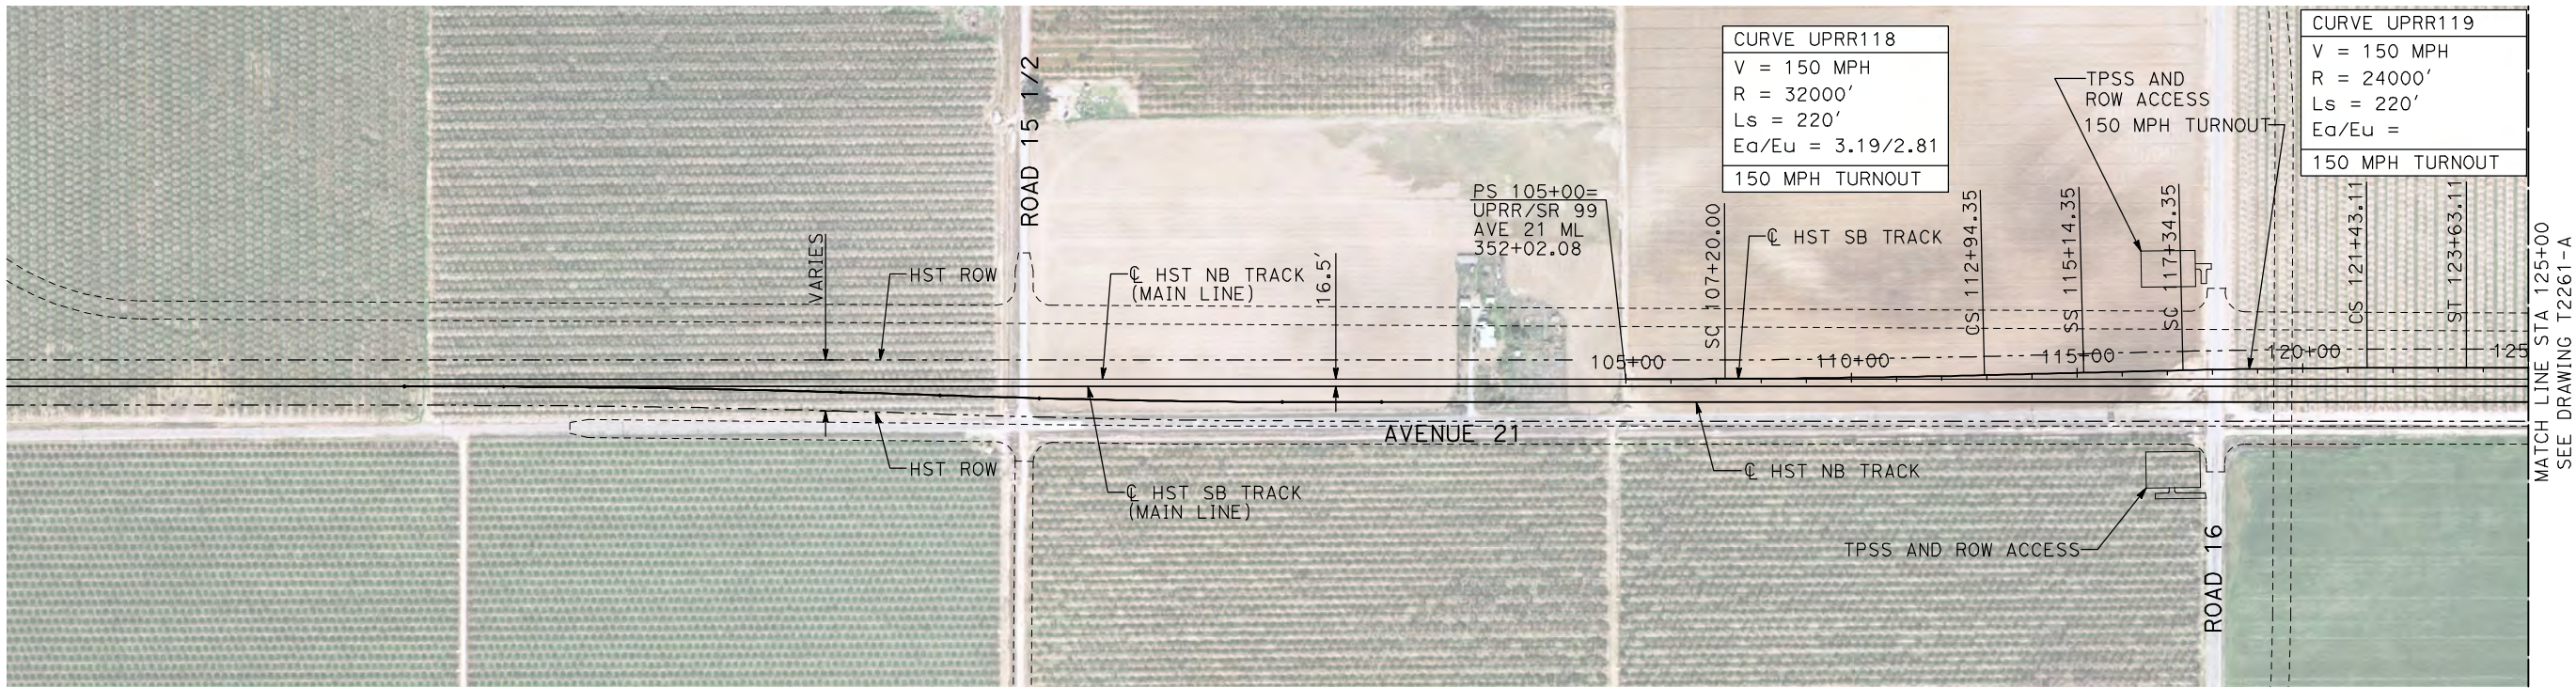
CALIFORNIA HIGH-SPEED TRAIN PROJECT  
MERCED TO FRESNO

UPRR/SR 99 WYE - NB CONNECTION  
AVENUE 21  
PLAN AND PROFILE  
STA 830+00 TO STA 846+93.43

CONTRACT NO. HSR06-007
DRAWING NO. T2256-A
SCALE AS SHOWN
SHEET NO. ### OF ###



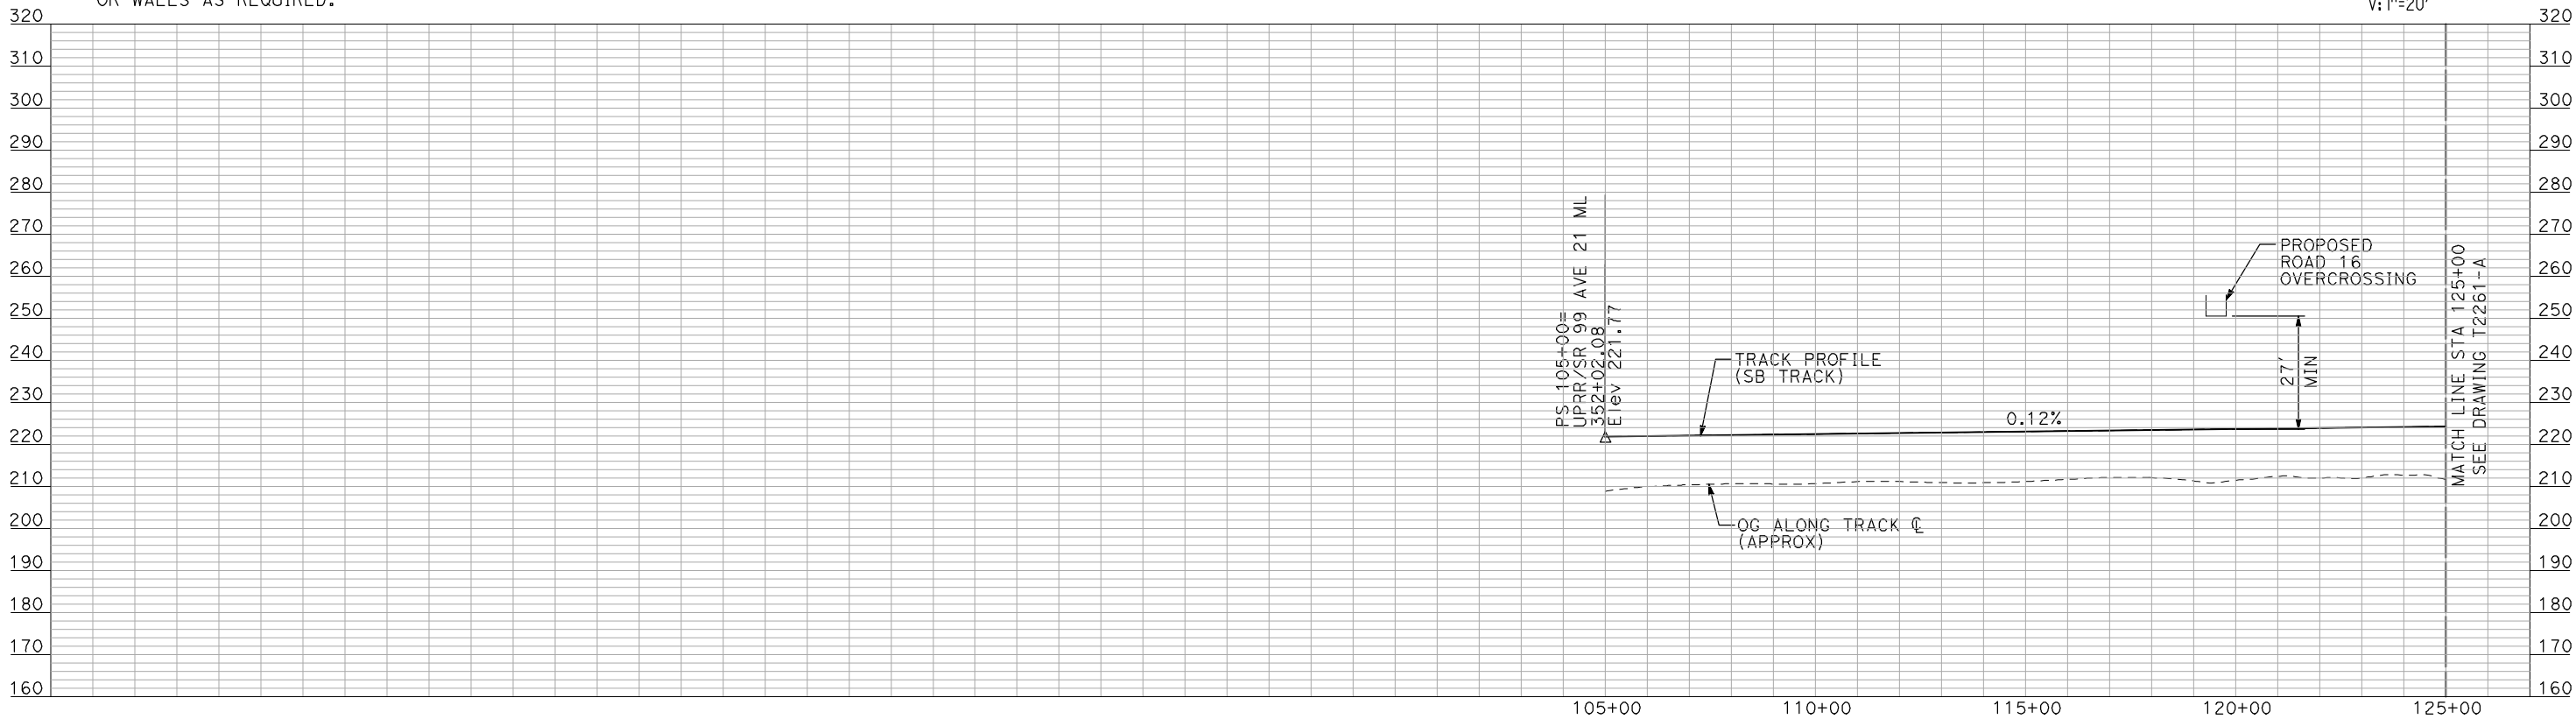
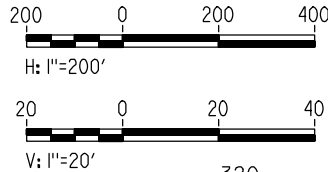
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PLAN



PROFILE

"SEE T3000-T3017 DRAWINGS FOR  
TYPICAL SECTION LIMITS AND DETAILS"

REV	DATE	BY	CHK	APP	DESCRIPTION

DESIGNED BY A. SHIELDS
DRAWN BY H. SULLIVAN
CHECKED BY A. BOONE
IN CHARGE A. BOONE
DATE 07/20/2011

RECORD SET  
15% DESIGN  
SUBMITTAL

NOT FOR  
CONSTRUCTION



CALIFORNIA  
HIGH-SPEED RAIL AUTHORITY

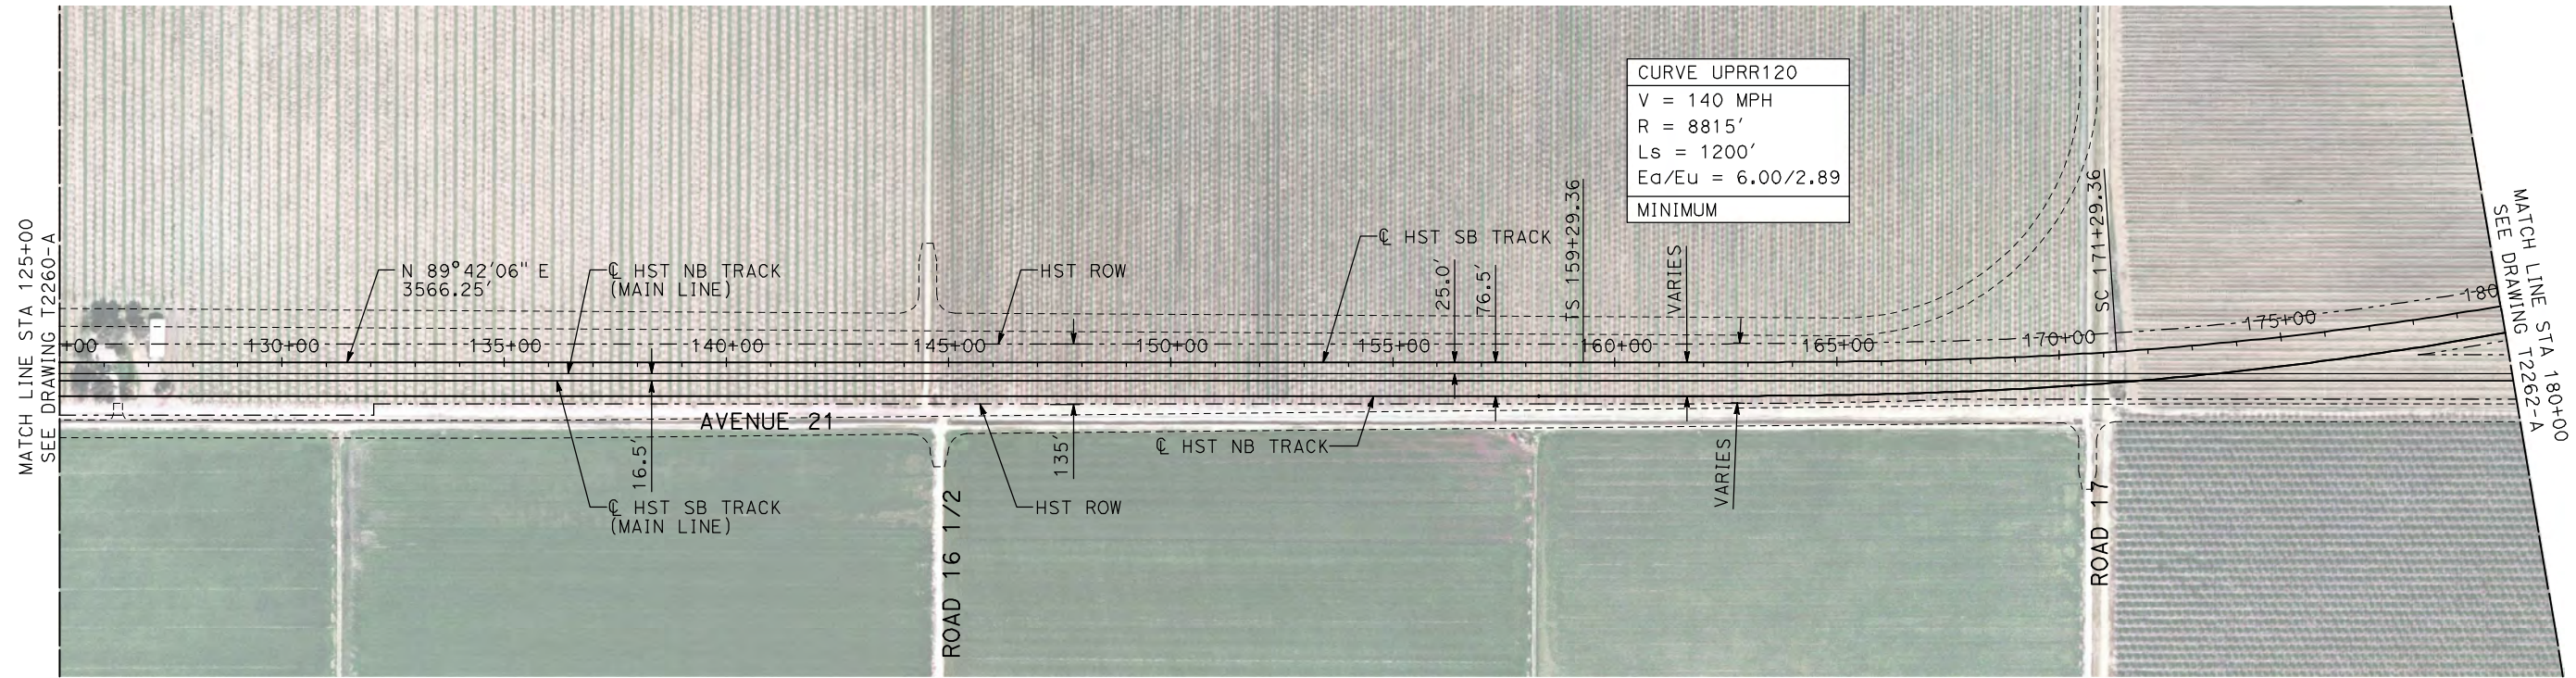
CALIFORNIA HIGH-SPEED TRAIN PROJECT  
MERCED TO FRESNO

UPRR/SR 99 WYE - SB CONNECTION  
AVENUE 21  
PLAN AND PROFILE  
STA 105+00 TO STA 125+00

CONTRACT NO. HSR06-007
DRAWING NO. T2260-A
SCALE AS SHOWN
SHEET NO. ### OF ###



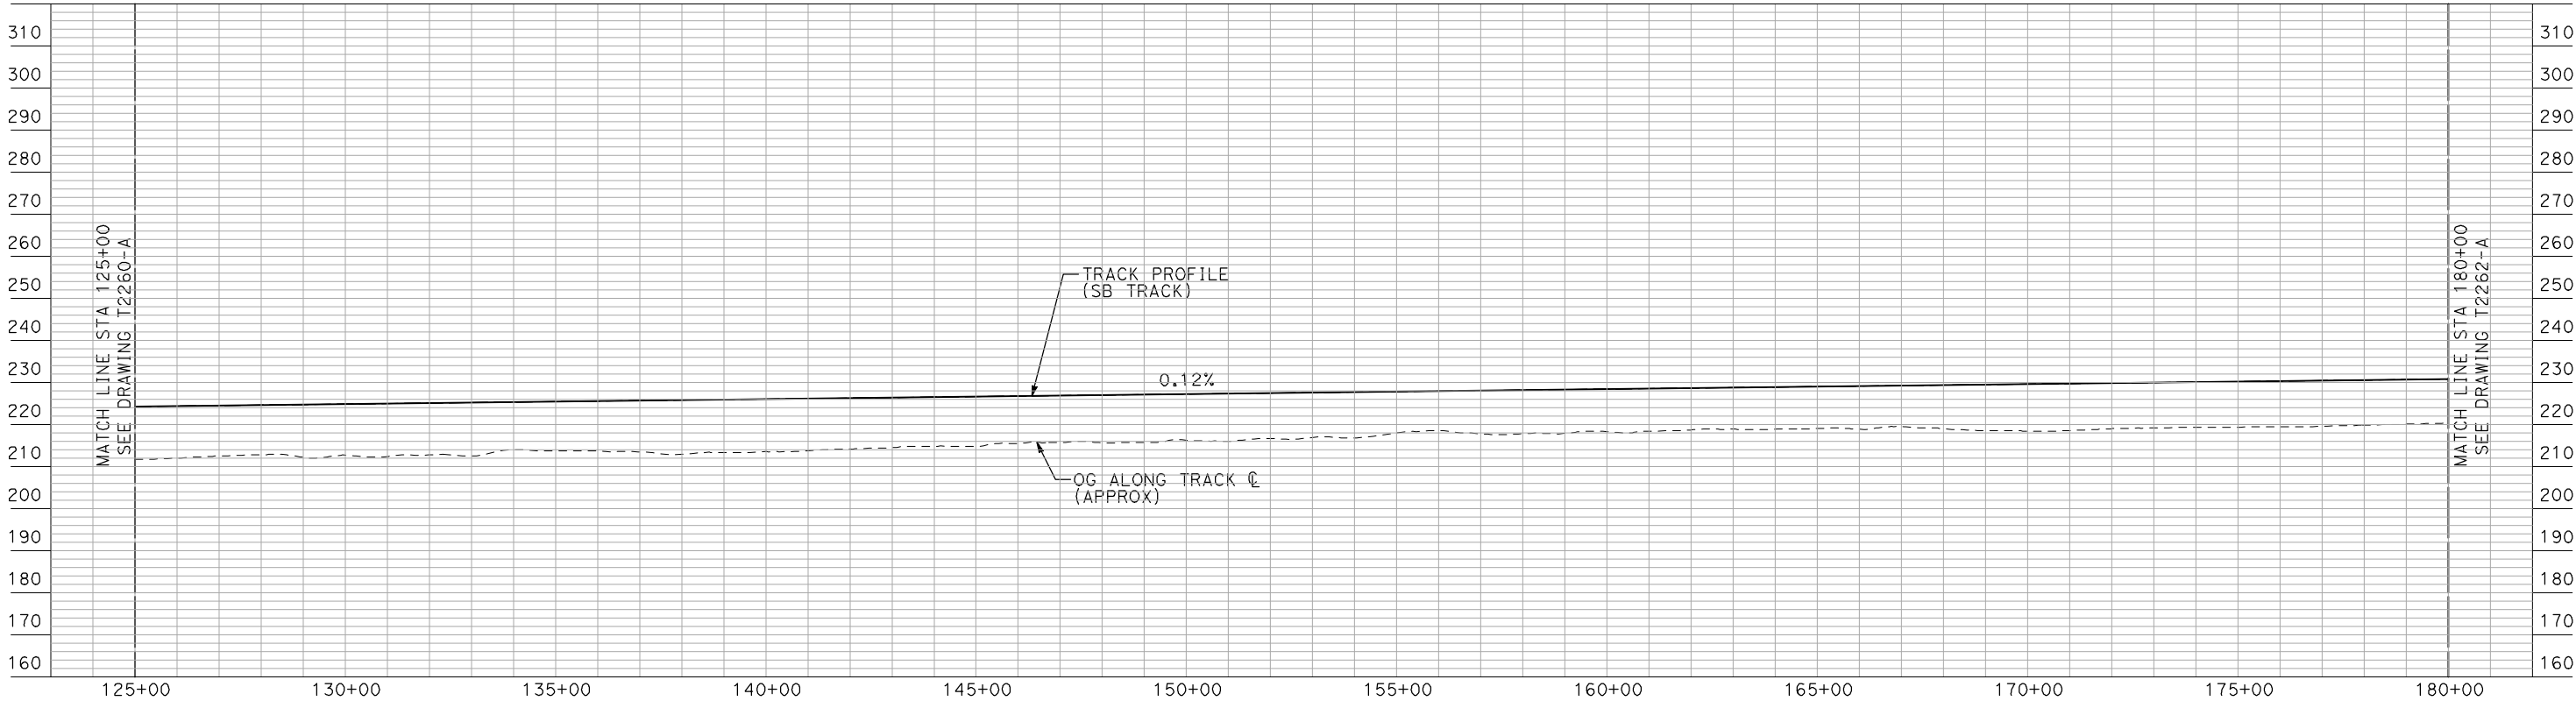
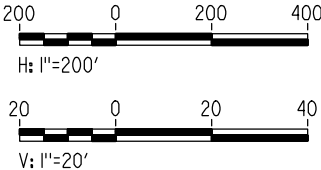
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NOTES:

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PLAN



PROFILE

"SEE T3000-T3017 DRAWINGS FOR  
TYPICAL SECTION LIMITS AND DETAILS"

REV	DATE	BY	CHK	APP	DESCRIPTION

DESIGNED BY A. SHIELDS
DRAWN BY H. SULLIVAN
CHECKED BY A. BOONE
IN CHARGE A. BOONE
DATE 07/20/2011

RECORD SET  
15% DESIGN  
SUBMITTAL

NOT FOR  
CONSTRUCTION



CALIFORNIA HIGH-SPEED TRAIN PROJECT  
MERCED TO FRESNO  
UPRR/SR 99 WYE - SB CONNECTION  
AVENUE 21  
PLAN AND PROFILE  
STA 125+00 TO STA 180+00

CONTRACT NO. HSR06-007
DRAWING NO. T2261-A
SCALE AS SHOWN
SHEET NO. ### OF ###



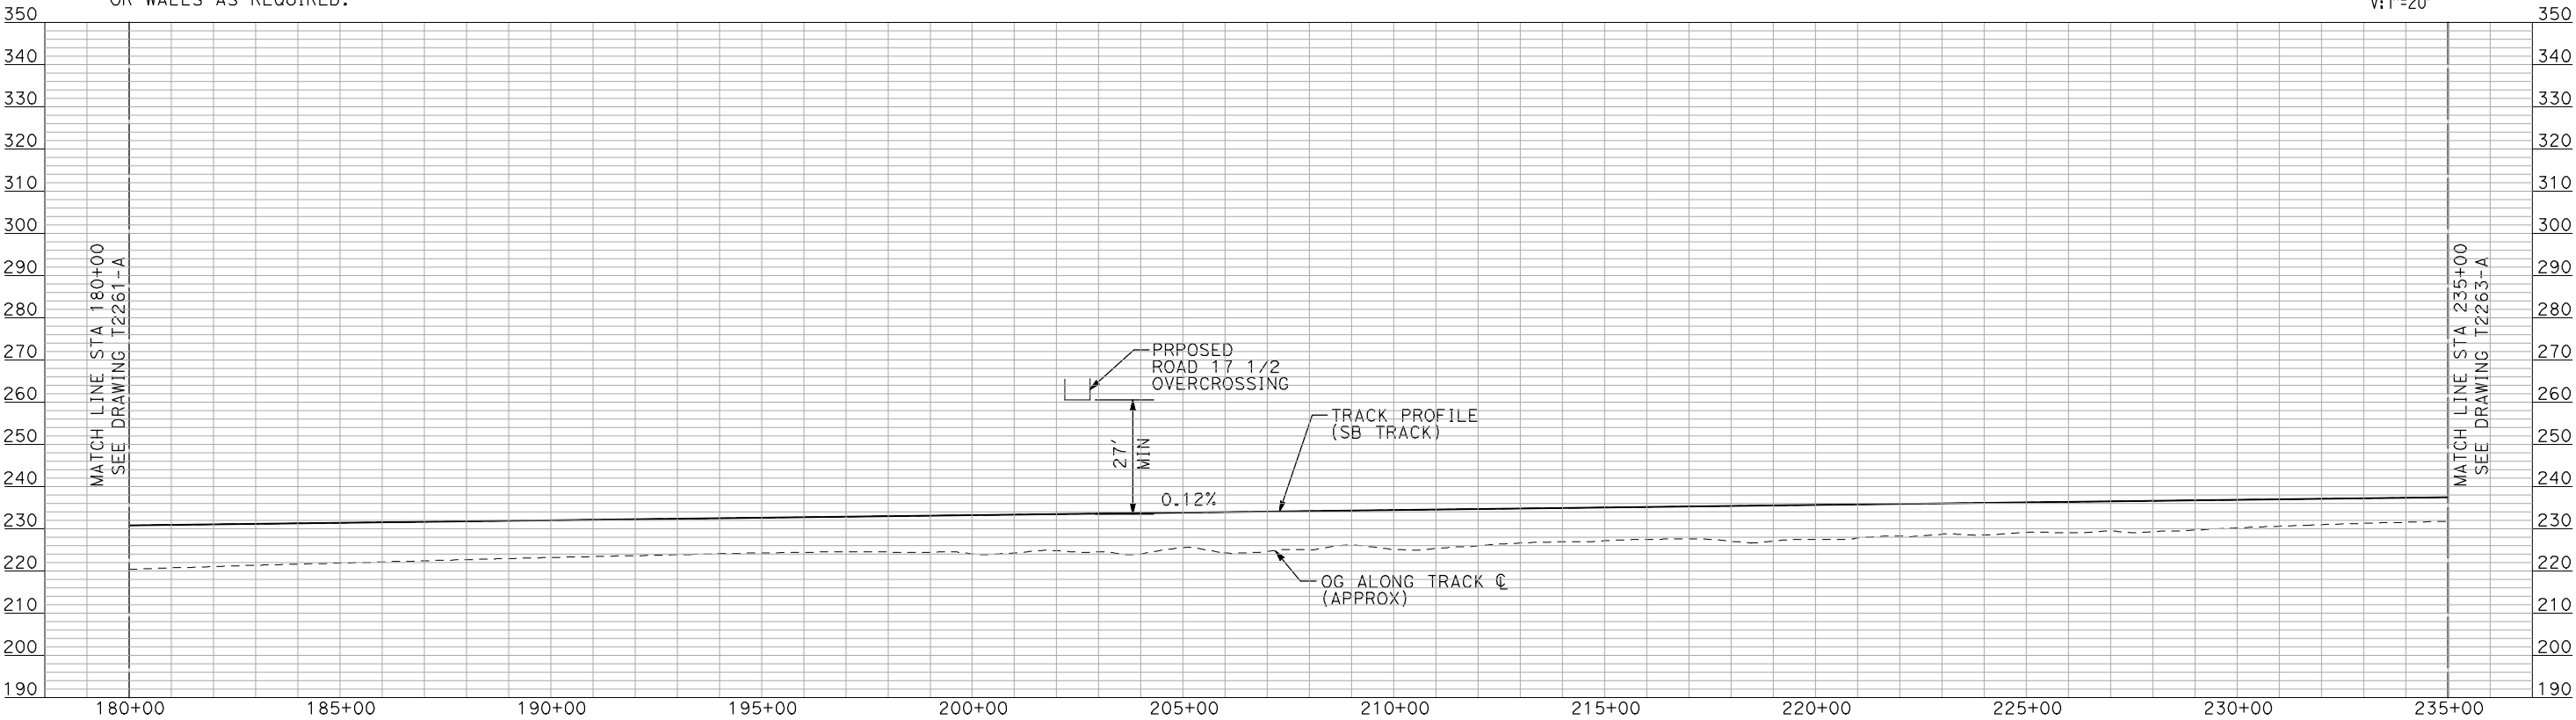
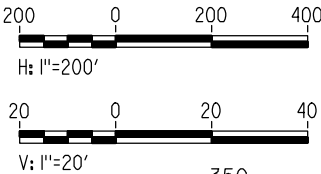
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PLAN



PROFILE

"SEE T3000-T3017 DRAWINGS FOR  
TYPICAL SECTION LIMITS AND DETAILS"

REV	DATE	BY	CHK	APP	DESCRIPTION

DESIGNED BY A. SHIELDS
DRAWN BY H. SULLIVAN
CHECKED BY A. BOONE
IN CHARGE A. BOONE
DATE 07/20/2011

RECORD SET  
15% DESIGN  
SUBMITTAL  
  
NOT FOR  
CONSTRUCTION

**AECOM**  
Technical Services, Inc.  
2020 L Street, Suite 300  
Sacramento, CA 95811  
**CH2M HILL**

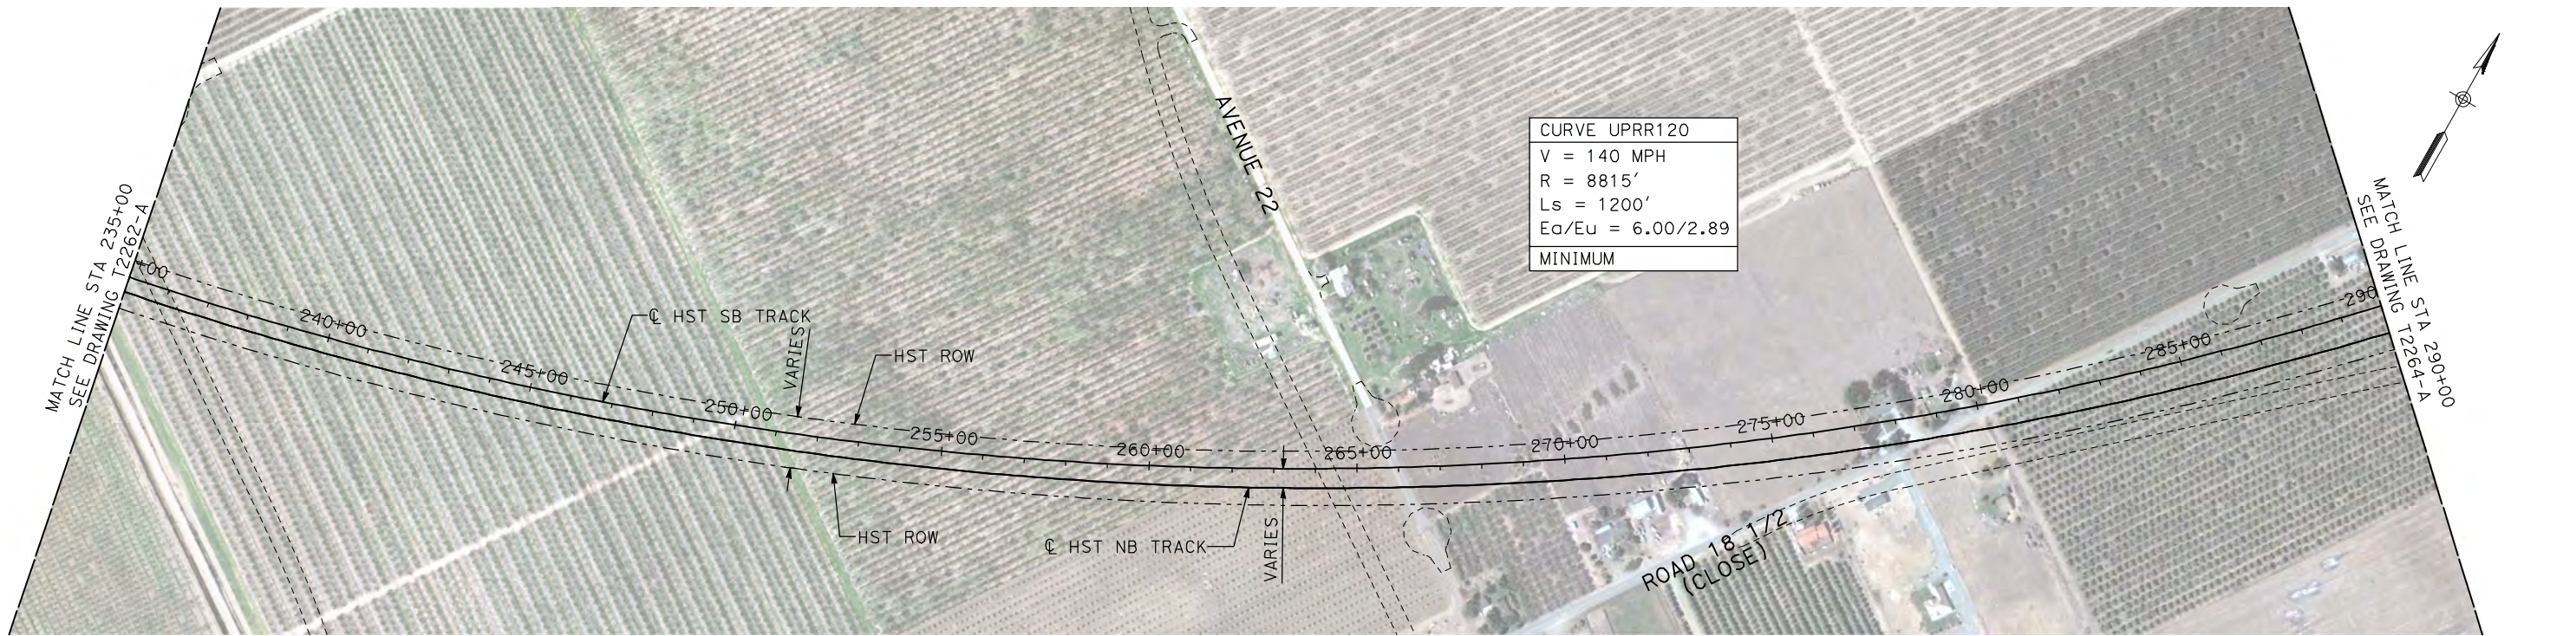


**CALIFORNIA HIGH-SPEED TRAIN PROJECT  
MERCED TO FRESNO**  
UPRR/SR 99 WYE - SB CONNECTION  
AVENUE 21  
PLAN AND PROFILE  
STA 180+00 TO STA 235+00

CONTRACT NO. HSR06-007
DRAWING NO. T2262-A
SCALE AS SHOWN
SHEET NO. ### OF ###



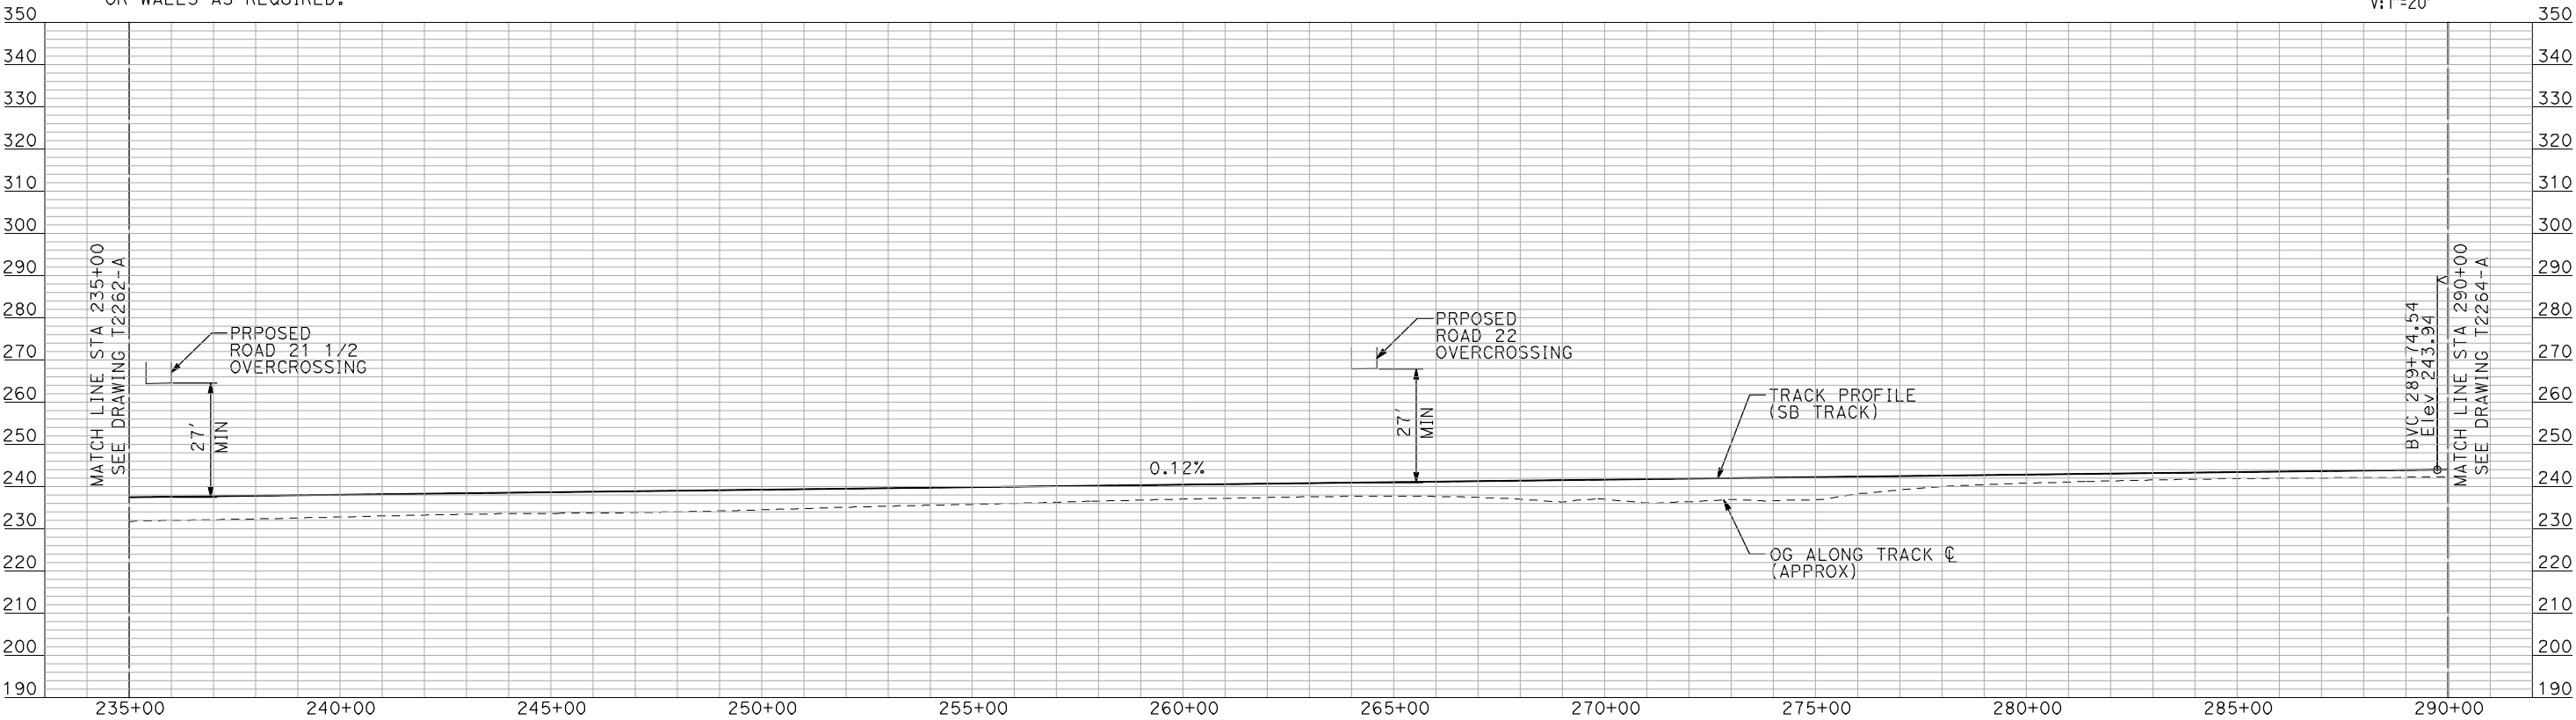
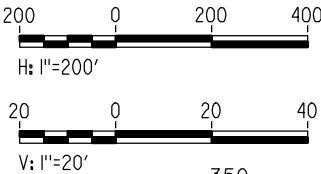
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NOTES:

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PLAN



PROFILE

"SEE T3000-T3017 DRAWINGS FOR  
TYPICAL SECTION LIMITS AND DETAILS"

REV	DATE	BY	CHK	APP	DESCRIPTION

DESIGNED BY A. SHIELDS
DRAWN BY H. SULLIVAN
CHECKED BY A. BOONE
IN CHARGE A. BOONE
DATE 07/20/2011

RECORD SET  
15% DESIGN  
SUBMITTAL

NOT FOR  
CONSTRUCTION



CALIFORNIA  
HIGH-SPEED RAIL AUTHORITY

CALIFORNIA HIGH-SPEED TRAIN PROJECT  
MERCED TO FRESNO

UPRR/SR 99 WYE - SB CONNECTION  
AVENUE 21  
PLAN AND PROFILE  
STA 235+00 TO STA 290+00

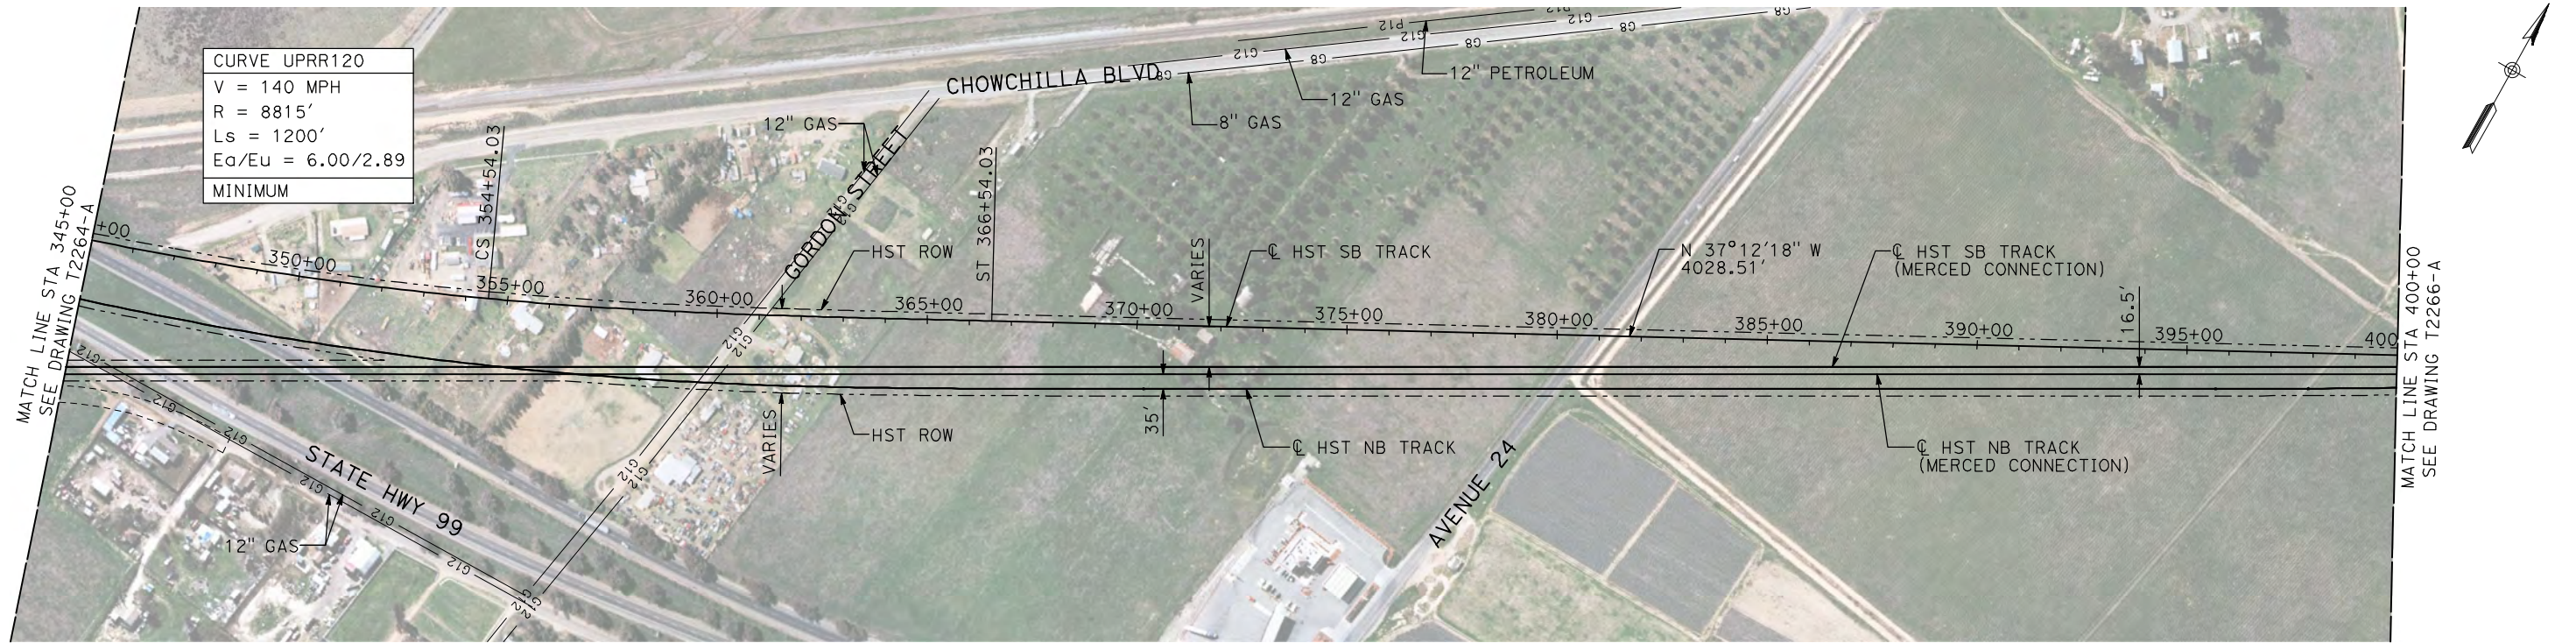
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DRAWING NO. T2263-A
SCALE AS SHOWN
SHEET NO. ### OF ###







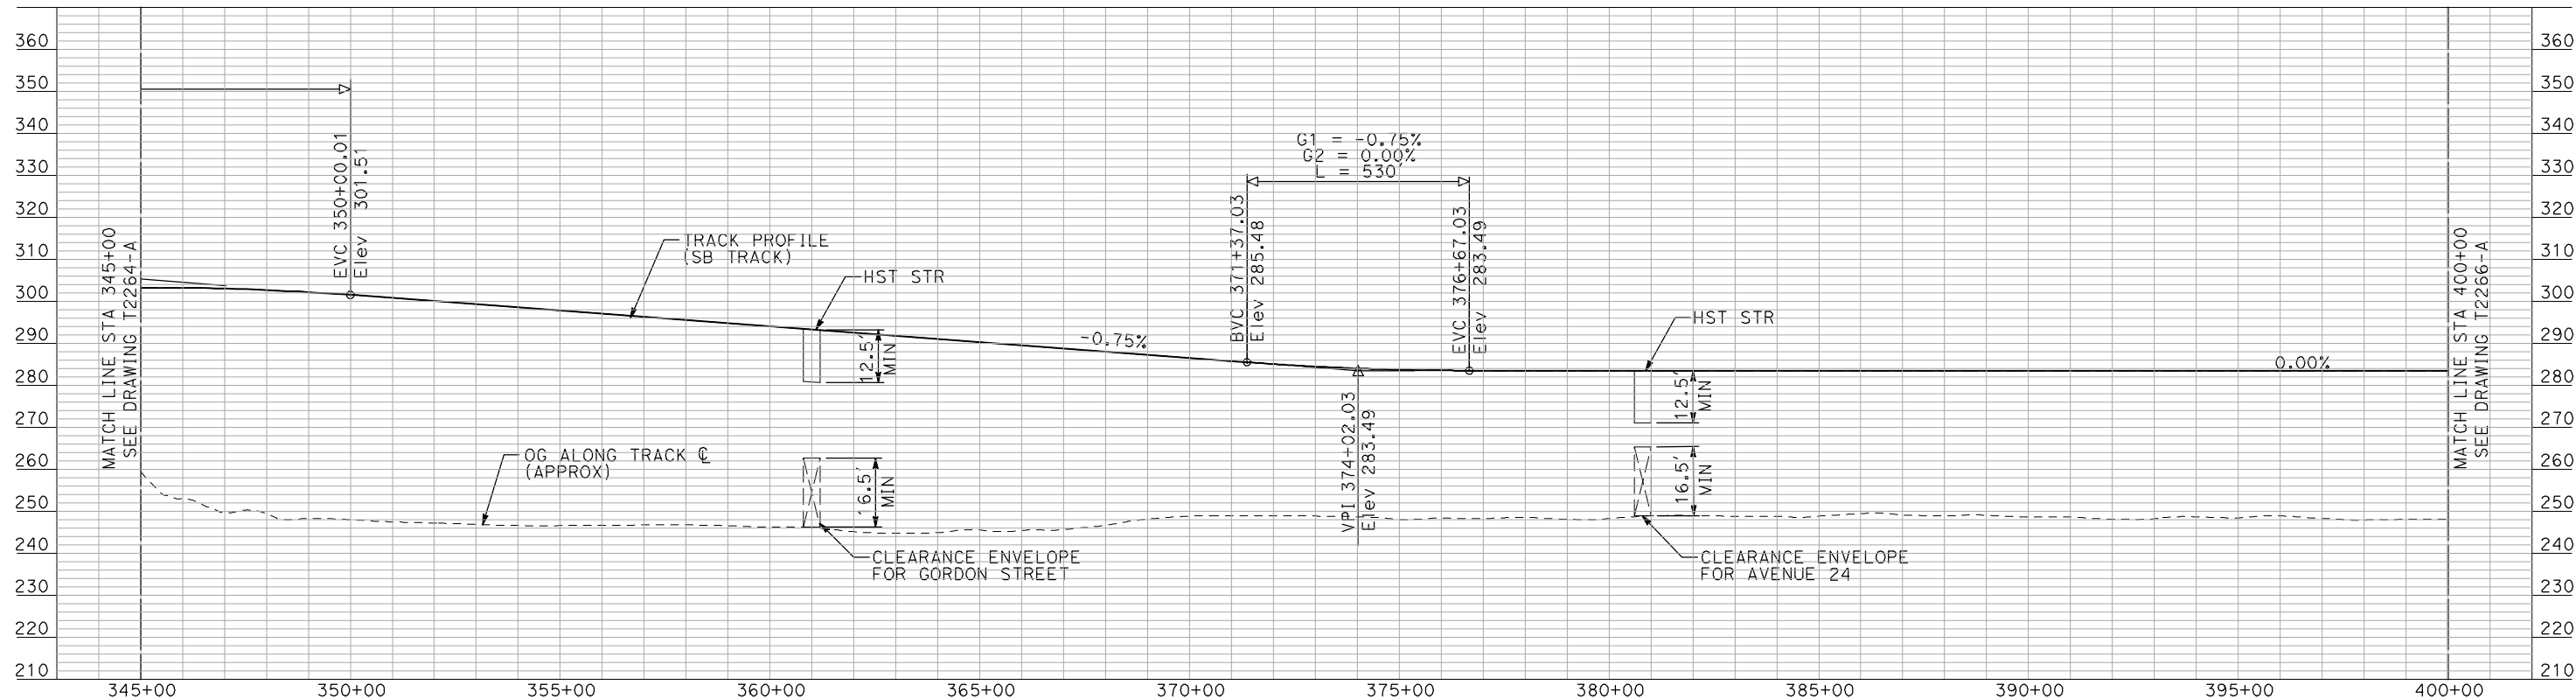
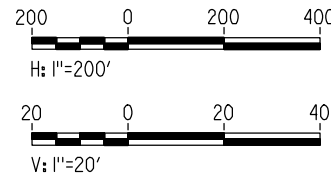
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PLAN



PROFILE

"SEE T3000-T3017 DRAWINGS FOR  
TYPICAL SECTION LIMITS AND DETAILS"

REV	DATE	BY	CHK	APP	DESCRIPTION

DESIGNED BY  
A. SHIELDS  
DRAWN BY  
H. SULLIVAN  
CHECKED BY  
A. BOONE  
IN CHARGE  
A. BOONE  
DATE  
07/20/2011

RECORD SET  
15% DESIGN  
SUBMITTAL  
  
NOT FOR  
CONSTRUCTION

**AECOM**  
Technical Services, Inc.  
2020 L Street, Suite 300  
Sacramento, CA 95811  
**CH2M HILL**

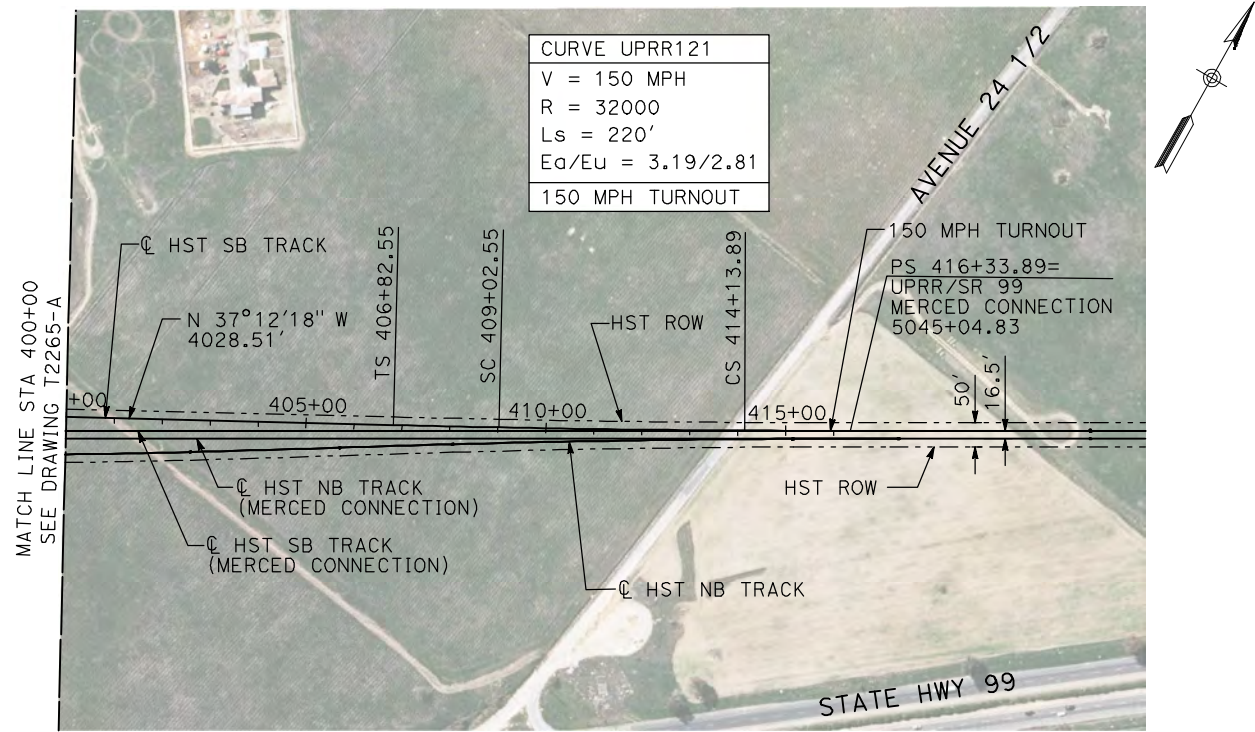


**CALIFORNIA HIGH-SPEED TRAIN PROJECT  
MERCED TO FRESNO**  
UPRR/SR 99 WYE - SB CONNECTION  
AVENUE 21  
PLAN AND PROFILE  
STA 345+00 TO STA 400+00

CONTRACT NO.  
HSR06-007  
DRAWING NO.  
T2265-A  
SCALE  
AS SHOWN  
SHEET NO.  
### OF ###



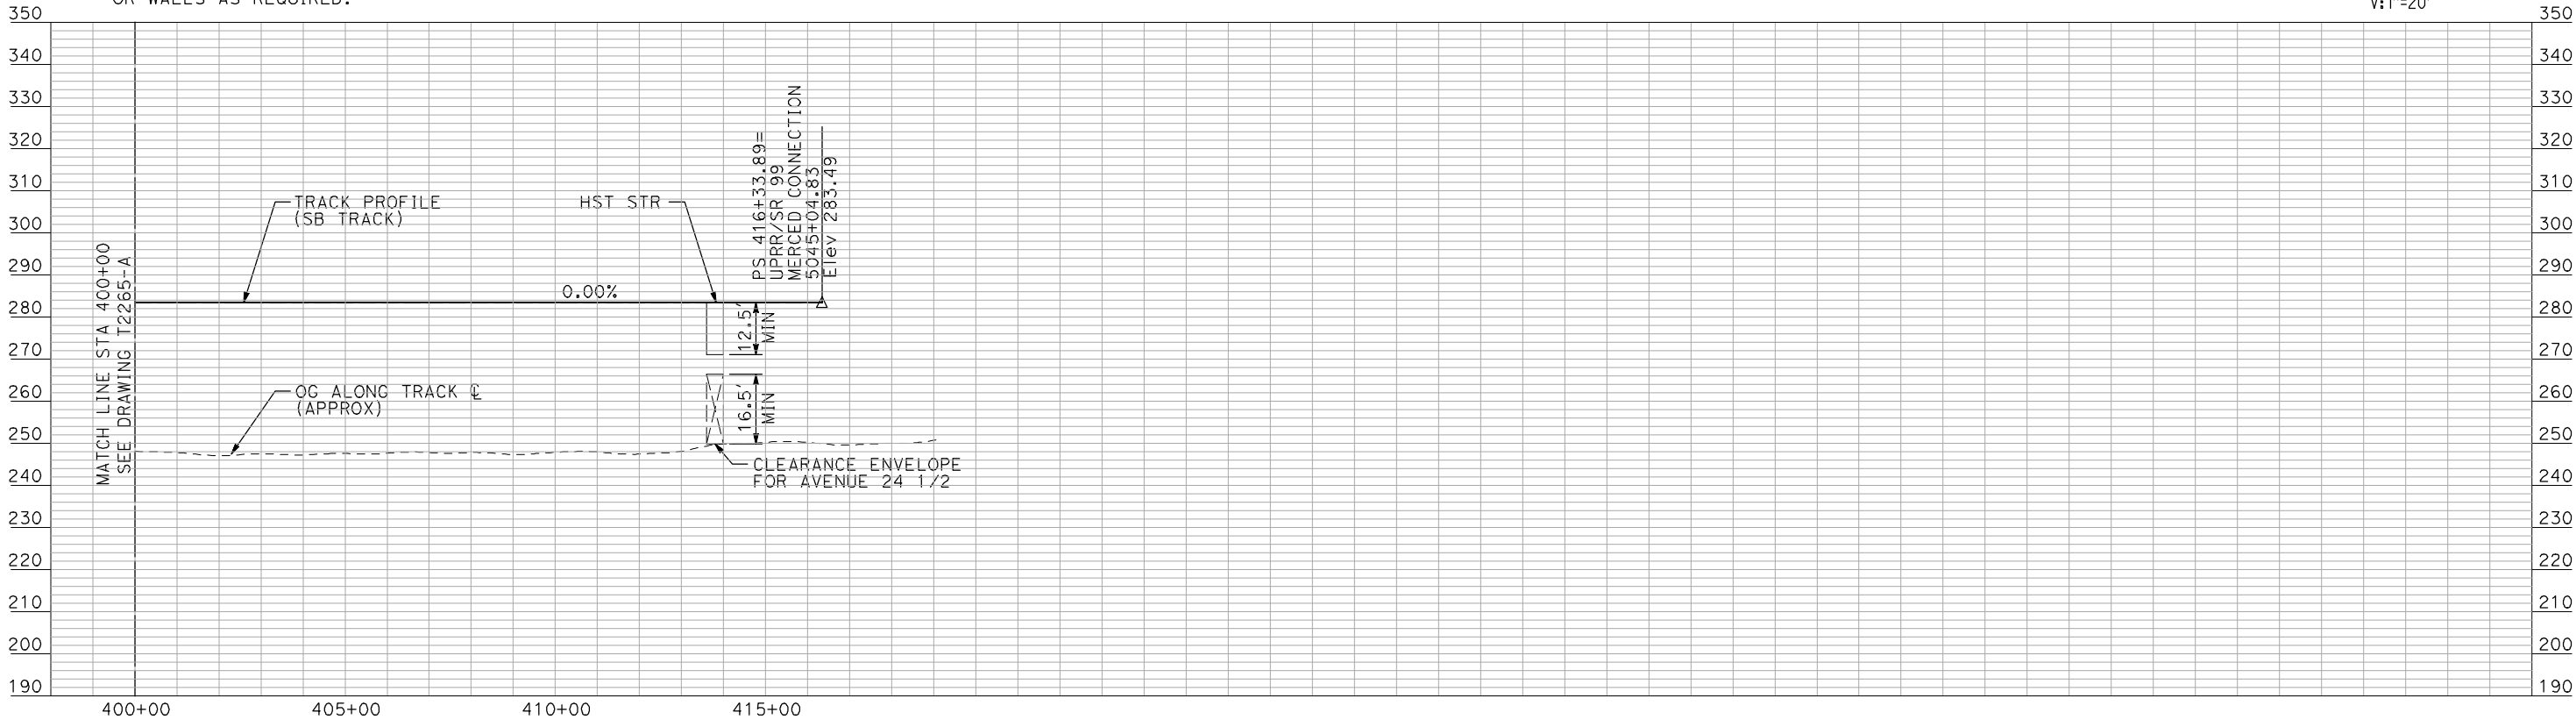
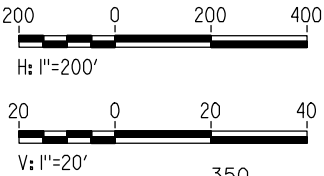
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PLAN



PROFILE

"SEE T3000-T3017 DRAWINGS FOR  
TYPICAL SECTION LIMITS AND DETAILS"

REV	DATE	BY	CHK	APP	DESCRIPTION

DESIGNED BY A. SHIELDS
DRAWN BY H. SULLIVAN
CHECKED BY A. BOONE
IN CHARGE A. BOONE
DATE 07/20/2011

RECORD SET  
15% DESIGN  
SUBMITTAL

NOT FOR  
CONSTRUCTION



CALIFORNIA HIGH-SPEED TRAIN PROJECT  
MERCED TO FRESNO

UPRR/SR 99 WYE - SB CONNECTION  
AVENUE 21  
PLAN AND PROFILE  
STA 400+00 TO STA 416+33.89

CONTRACT NO. HSR06-007
DRAWING NO. T2266-A
SCALE AS SHOWN
SHEET NO. ### OF ###